


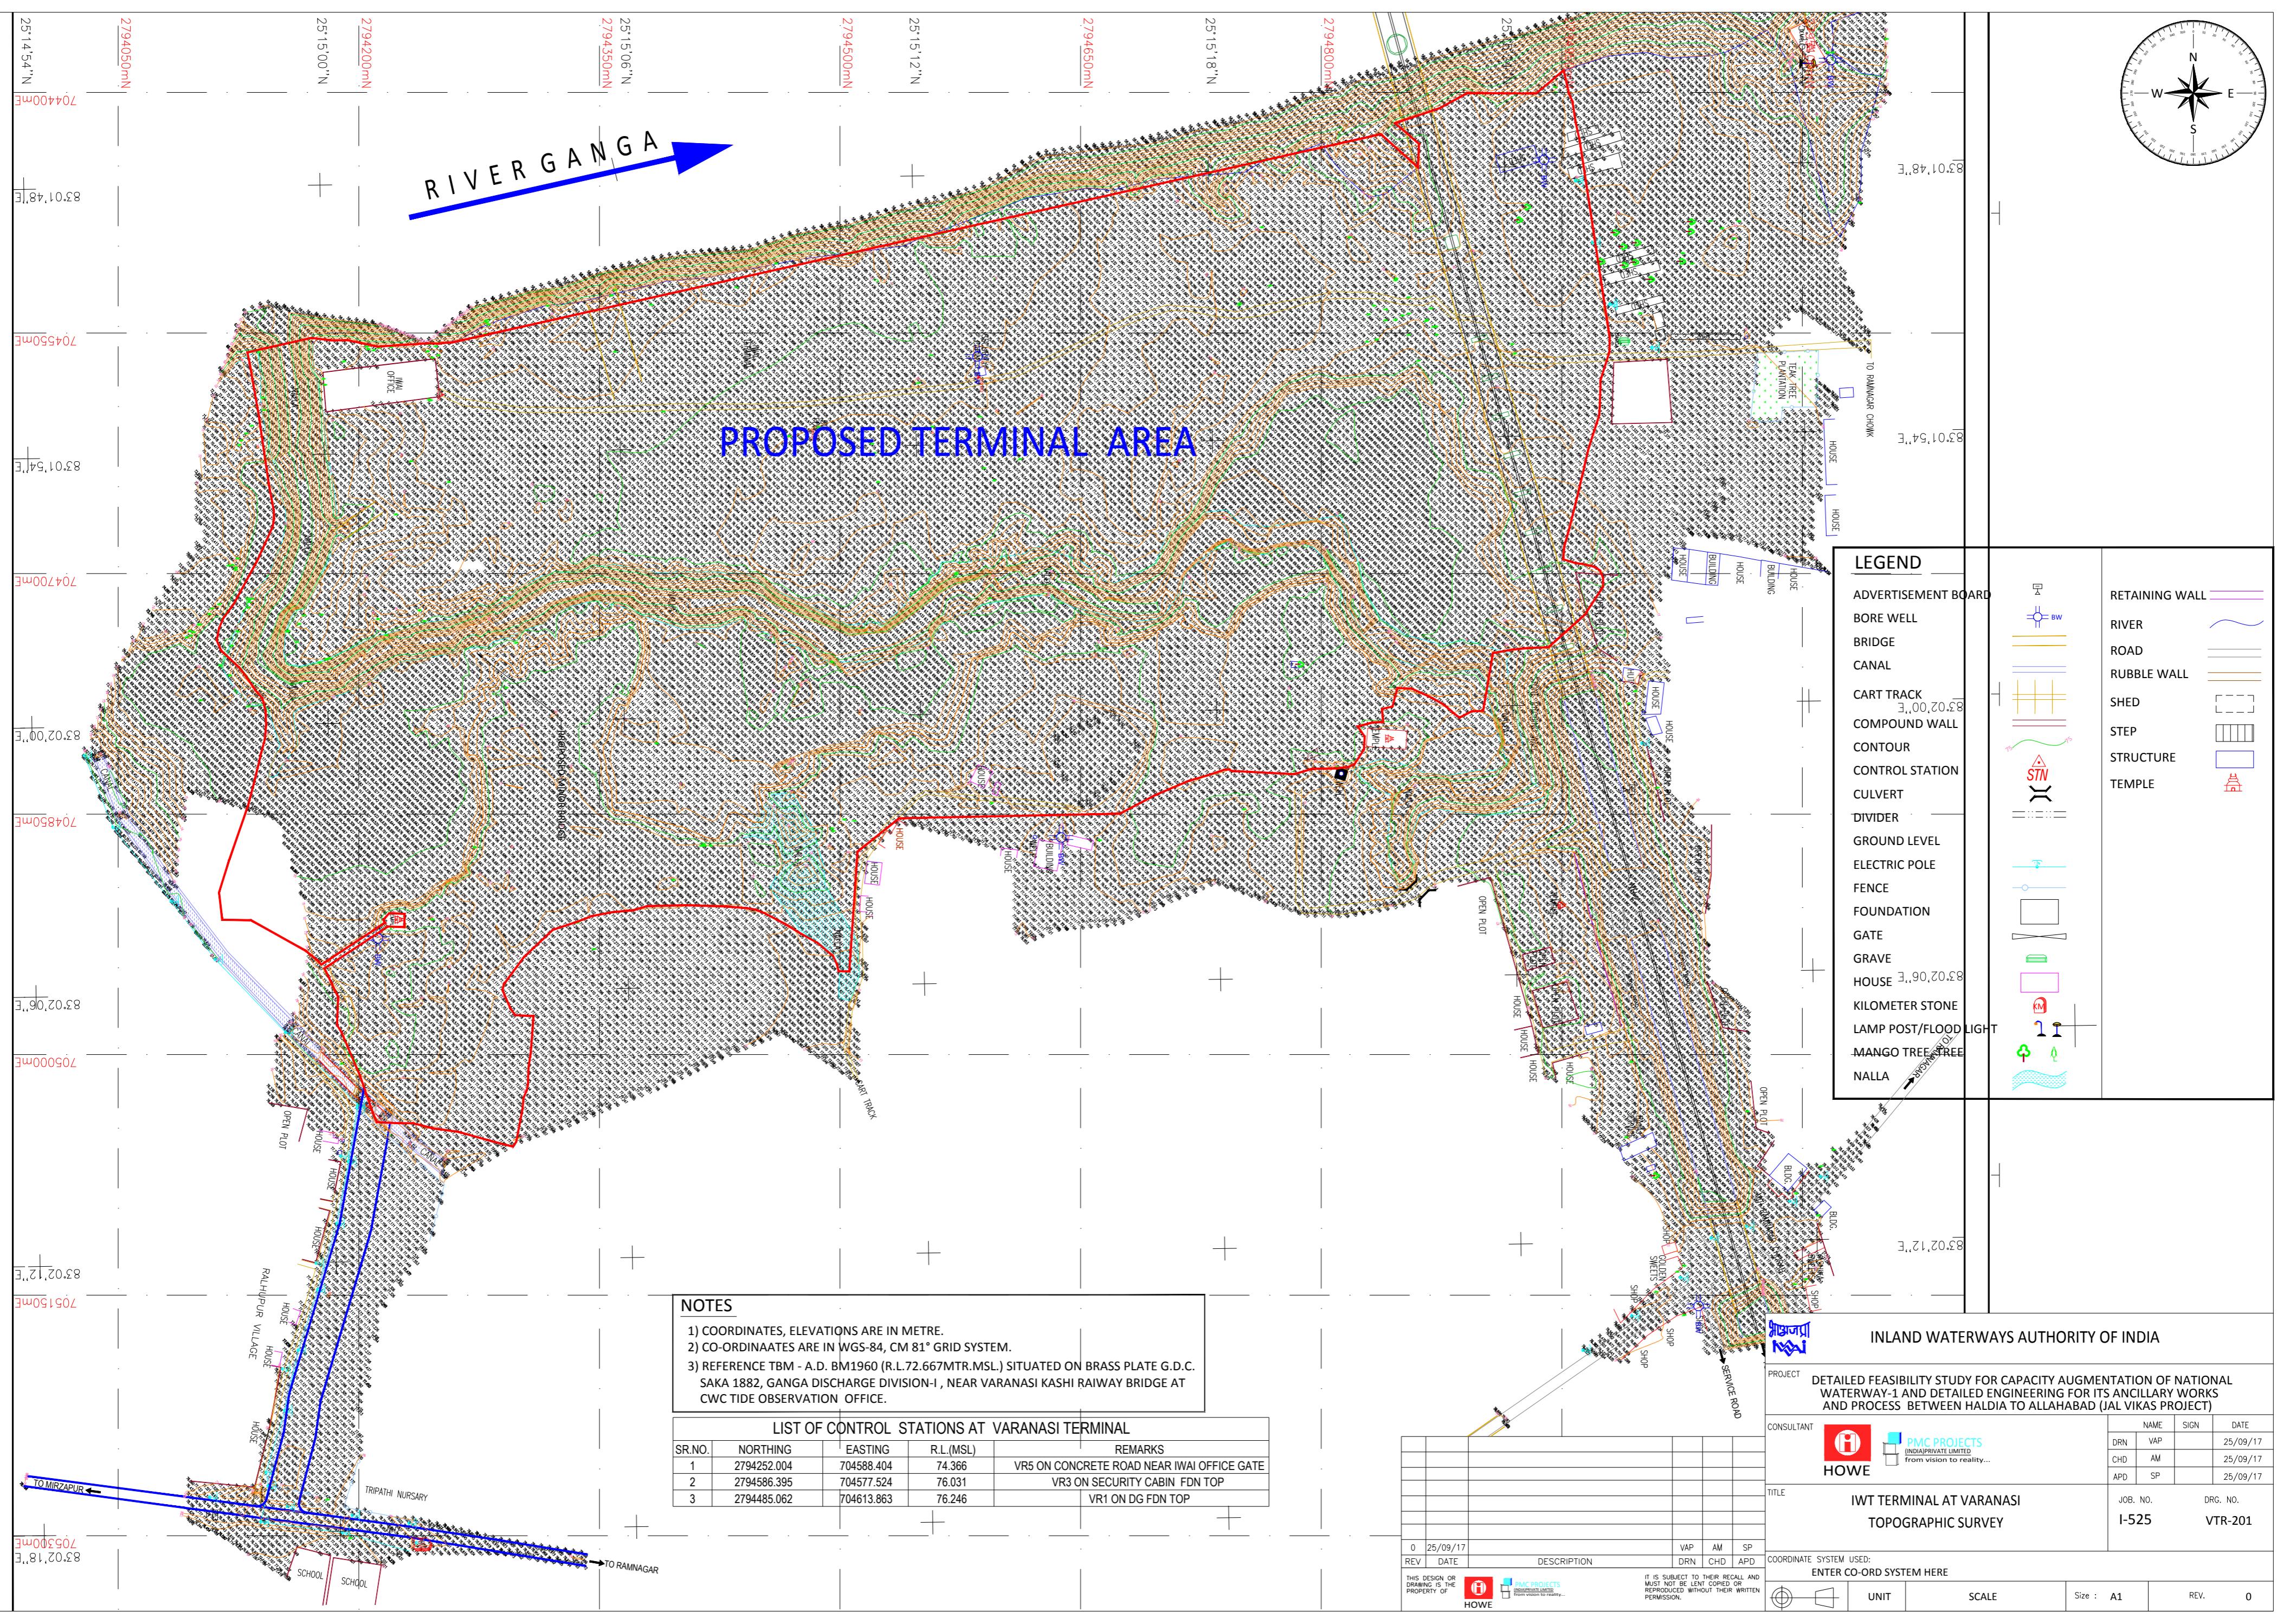


I-525 VARANASI TERMINAL - DPR DRAWING LIST		
S. NO.	DWG. NO.	TITLE
1	I-525-VTR-201	TOPOGRAPHIC SURVEY
2	I-525-VTR-202	BATHYMETRY SURVEY
3	I-525-VTR-203	LOCATION PLAN OF BORE HOLES
4	I-525-VTR-204	LAYOUT OF TERMINAL IN PHASE-1A
5	I-525-VTR-205	LAYOUT OF TERMINAL IN PHASE-1B
6	I-525-VTR-206	TERMINAL FACILITIES -MASTER PLAN
7	I-525-VTR-207	LAYOUT OF TERMINAL BOUNDARY
8	I-525-VTR-208	LAYOUT OF AIDS TO NAVIGATION
9	I-525-VTR-209	GENERAL ARRANGEMENT & CROSS SECTION OF JETTY (FINAL PHASE)
10	I-525-VTR-209A	GENERAL ARRANGEMENT & CROSS SECTION OF JETTY (PHASE -1A)
11	I-525-VTR-210	TYPICAL DETAIL OF SHORE PROTECTION WORK
12	I-525-VTR-211 (SHEET-1)	TYPICAL LAYOUT OF TERMINAL ADMINISTRATION BUILDING
13	I-525-VTR-211 (SHEET-2)	TYPICAL ELEVATION OF TERMINAL ADMINISTRATION BUILDING
14	I-525-VTR-212	LAYOUT OF FIRE FIGHTING PUMP HOUSE (FINAL PHASE)
15	I-525-VTR-212A	LAYOUT OF FIRE FIGHTING PUMP HOUSE (PHASE-1B)
16	I-525-VTR-213	GENERAL ARRANGEMENT OF GATE COMPLEX
17	I-525-VTR-214	SECURITY OFFICE
18	I-525-VTR-215	WEIGH BRIDGE CONTROL ROOM
19	I-525-VTR-216	LAYOUT OF CANTEEN & TOILET
20	I-525-VTR-217	GENERAL ARRANGEMENT OF COVERED STORAGE SHED
21	I-525-VTR-218	TYPICAL DETAILS OF STOCKYARD
22	I-525-VTR-219	CONVEYOR PROFILE
23	I-525-VTR-220	ROAD CROSS SECTIONS
24	I-525-VTR-221	LAYOUT OF WATER SUPPLY SYSTEM IN PHASE-1B
25	I-525-VTR-222	LAYOUT OF WATER SUPPLY SYSTEM IN MASTER PLAN
26	I-525-VTR-223	FIRE FIGHTING LAYOUT IN PHASE-1B
27	I-525-VTR-224	FIRE FIGHTING LAYOUT IN MASTER PLAN
28	I-525-VTR-225	LAYOUT OF STORM WATER SYSTEM IN PHASE-1A
29	I-525-VTR-226	LAYOUT OF STORM WATER SYSTEM IN PHASE-1B
30	I-525-VTR-227	LAYOUT OF STORM WATER SYSTEM IN MASTER PLAN
31	I-525-VTR-228 (SHEET-1)	LAYOUT OF TOILET BLOCK
32	I-525-VTR-228 (SHEET-2)	ELEVATION & SECTION OF TOILET BLOCK
33	I-525-VTR-229	LAYOUT OF JAI YATRI NIWAS (GUEST HOUSE)
34	I-525-VTR-230 (SHEET -1)	LAYOUT OF NALLA DIVERSION
35	I-525-VTR-230 (SHEET - 2)	LONGITUDINAL SECTION OF NALLA DIVERSION
36	I-525-VTR-230 (SHEET -3)	CSOSS SECTION OF NALLA DIVERSION
37	I-525-VTR-232	SUB STATION EQUIPMENT LAYOUT (ESS-2)
38	I-525-VTR-233	POWER SINGLE LINE DIAGRAM (ESS-1)
39	I-525-VTR-234	POWER SINGLE LINE DIAGRAM (ESS-2)
40	I-525-VTR-235	HIGH MAST & CCTV CAMERA CABLE ROUTE
41	I-525-VTR-236	YARD CRUST DETAILS
42	I-525-VTR-237	SEWERAGE COLLECTION SYSTEM PHASE-1A
43	I-525-VTR-238	ELECTRICAL SUBSTATION PLAN (ESS-1) (PHASE-1A)
44	I-525-VTR-239	ELECTRICAL SUBSTATION ELEVATION & SECTION (ESS-1) (PHASE-1A)
45	I-525-VTR-240	WORKERS AMENITY BLOCK (PHASE-1A)
46	I-525-VTR-241	BERTHING APPURTEANCES DETAILS
47	I-525-VTR-242	EXTERNAL ROAD CONNECTIVITY
48	I-525-VTR-243	SEWERAGE COLLECTION SYSTEM IN MASTER PLAN
49	I-525-VTR-244	GATE PLAN, ELEVATION & CROSS SECTION
50	I-525-VTR-245	PONTOON LAYOUT
51	I-525-VTR-246	PONTOON CROSS SECTION

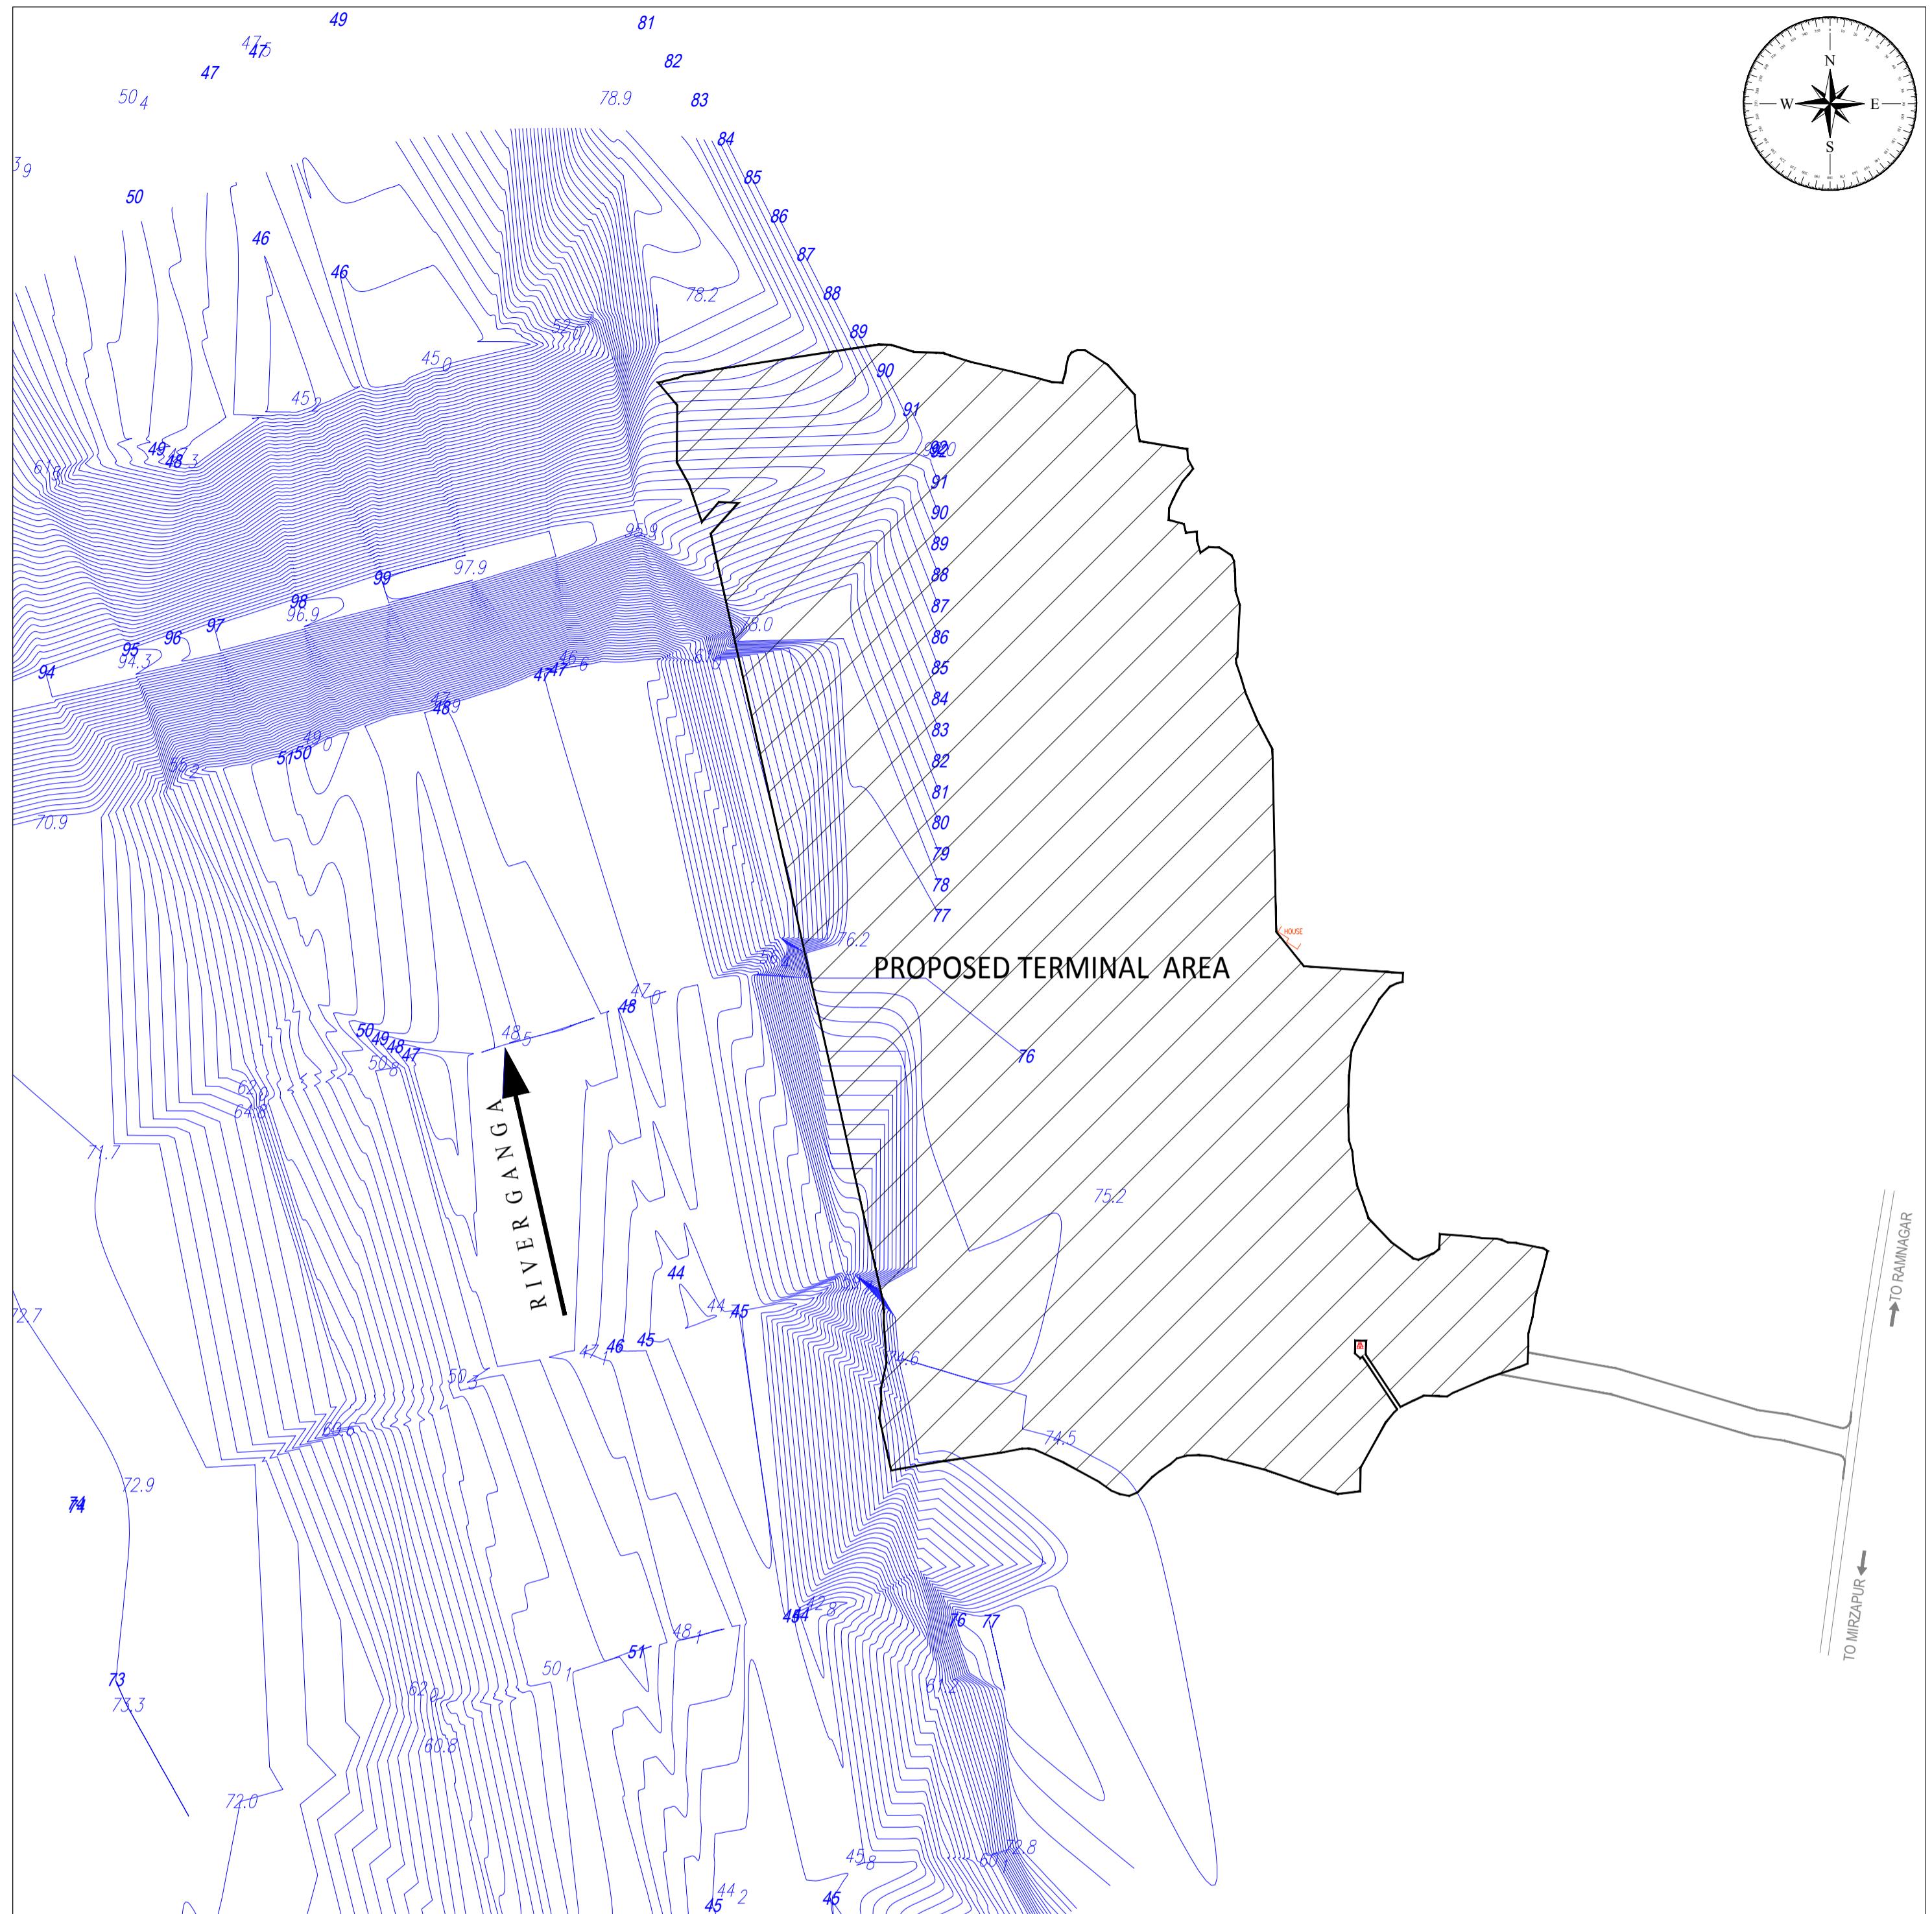


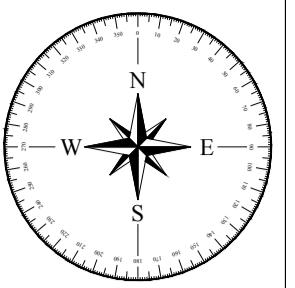


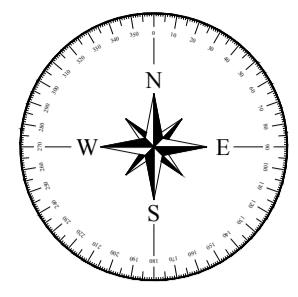



LEGEND
RIVER BOREHOLE
LAND BOREHOLE


BOREHOLES CO-ORDINATES		
MKD.	EASTING	NORTHING
RBH1	704487	2794455
RBH2	704522	2794306
LBH1	704534	2794467
LBH2	704538	2794382
LBH3	704622	2794303


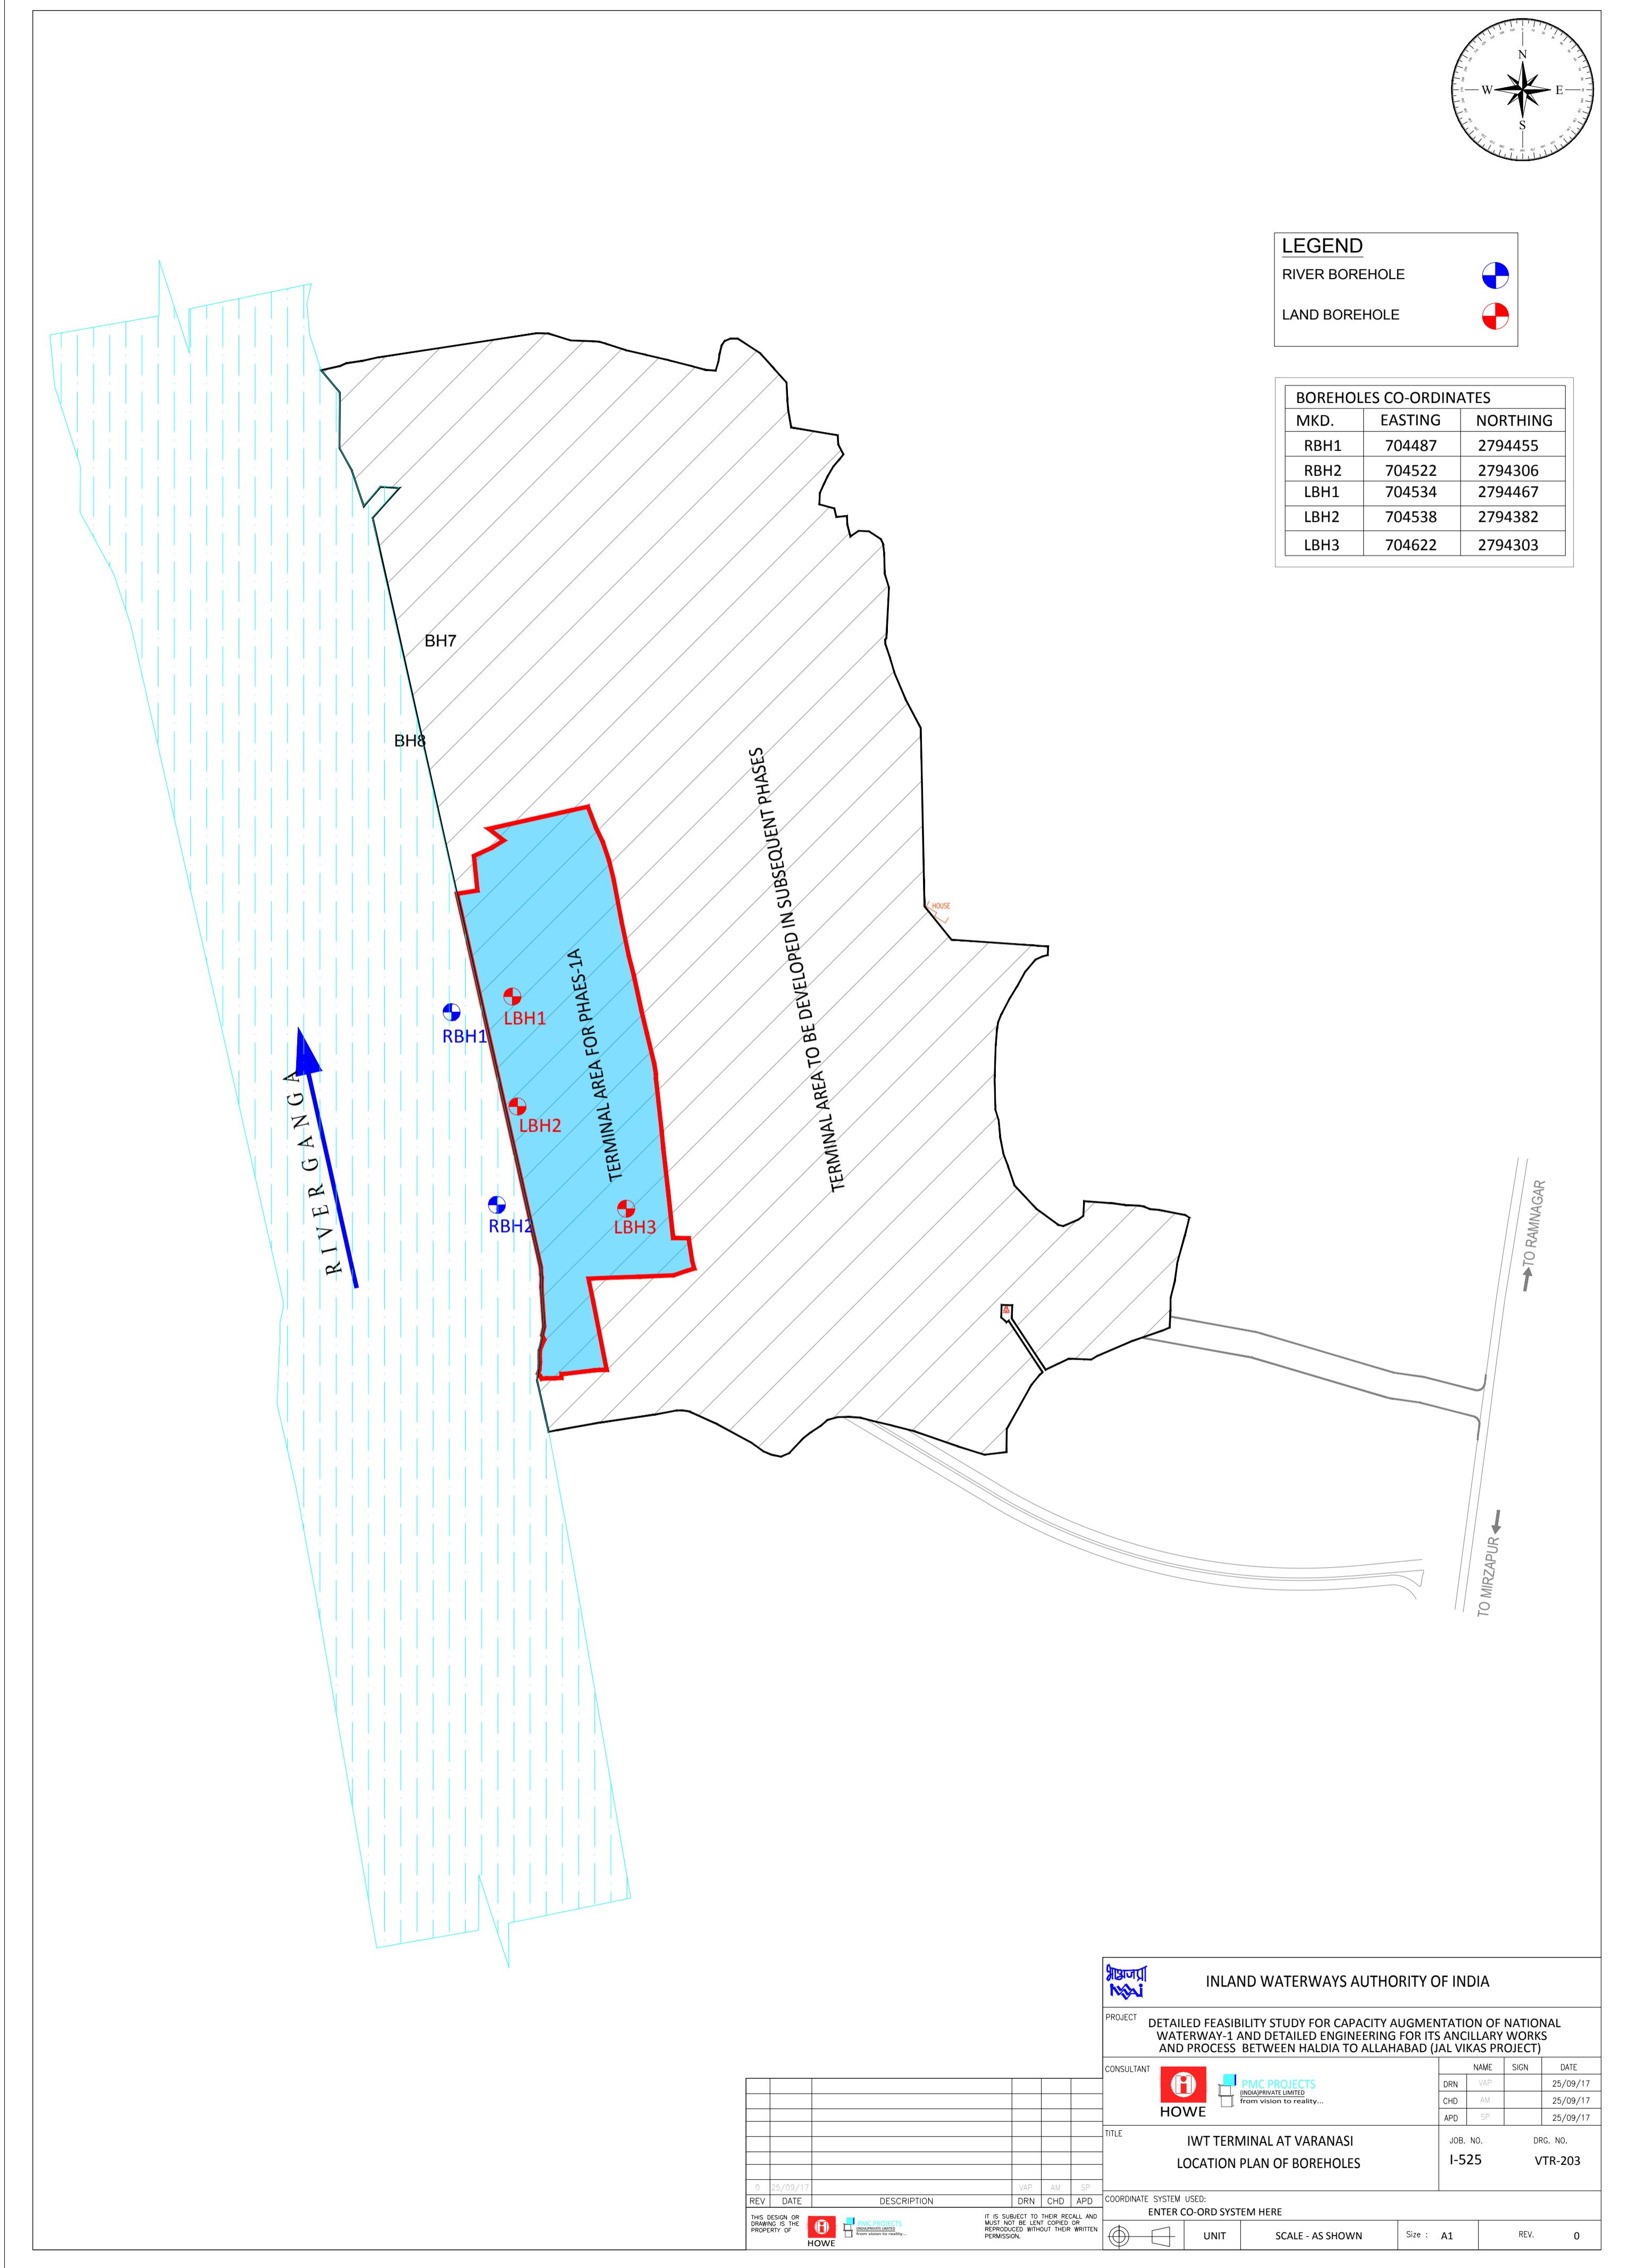


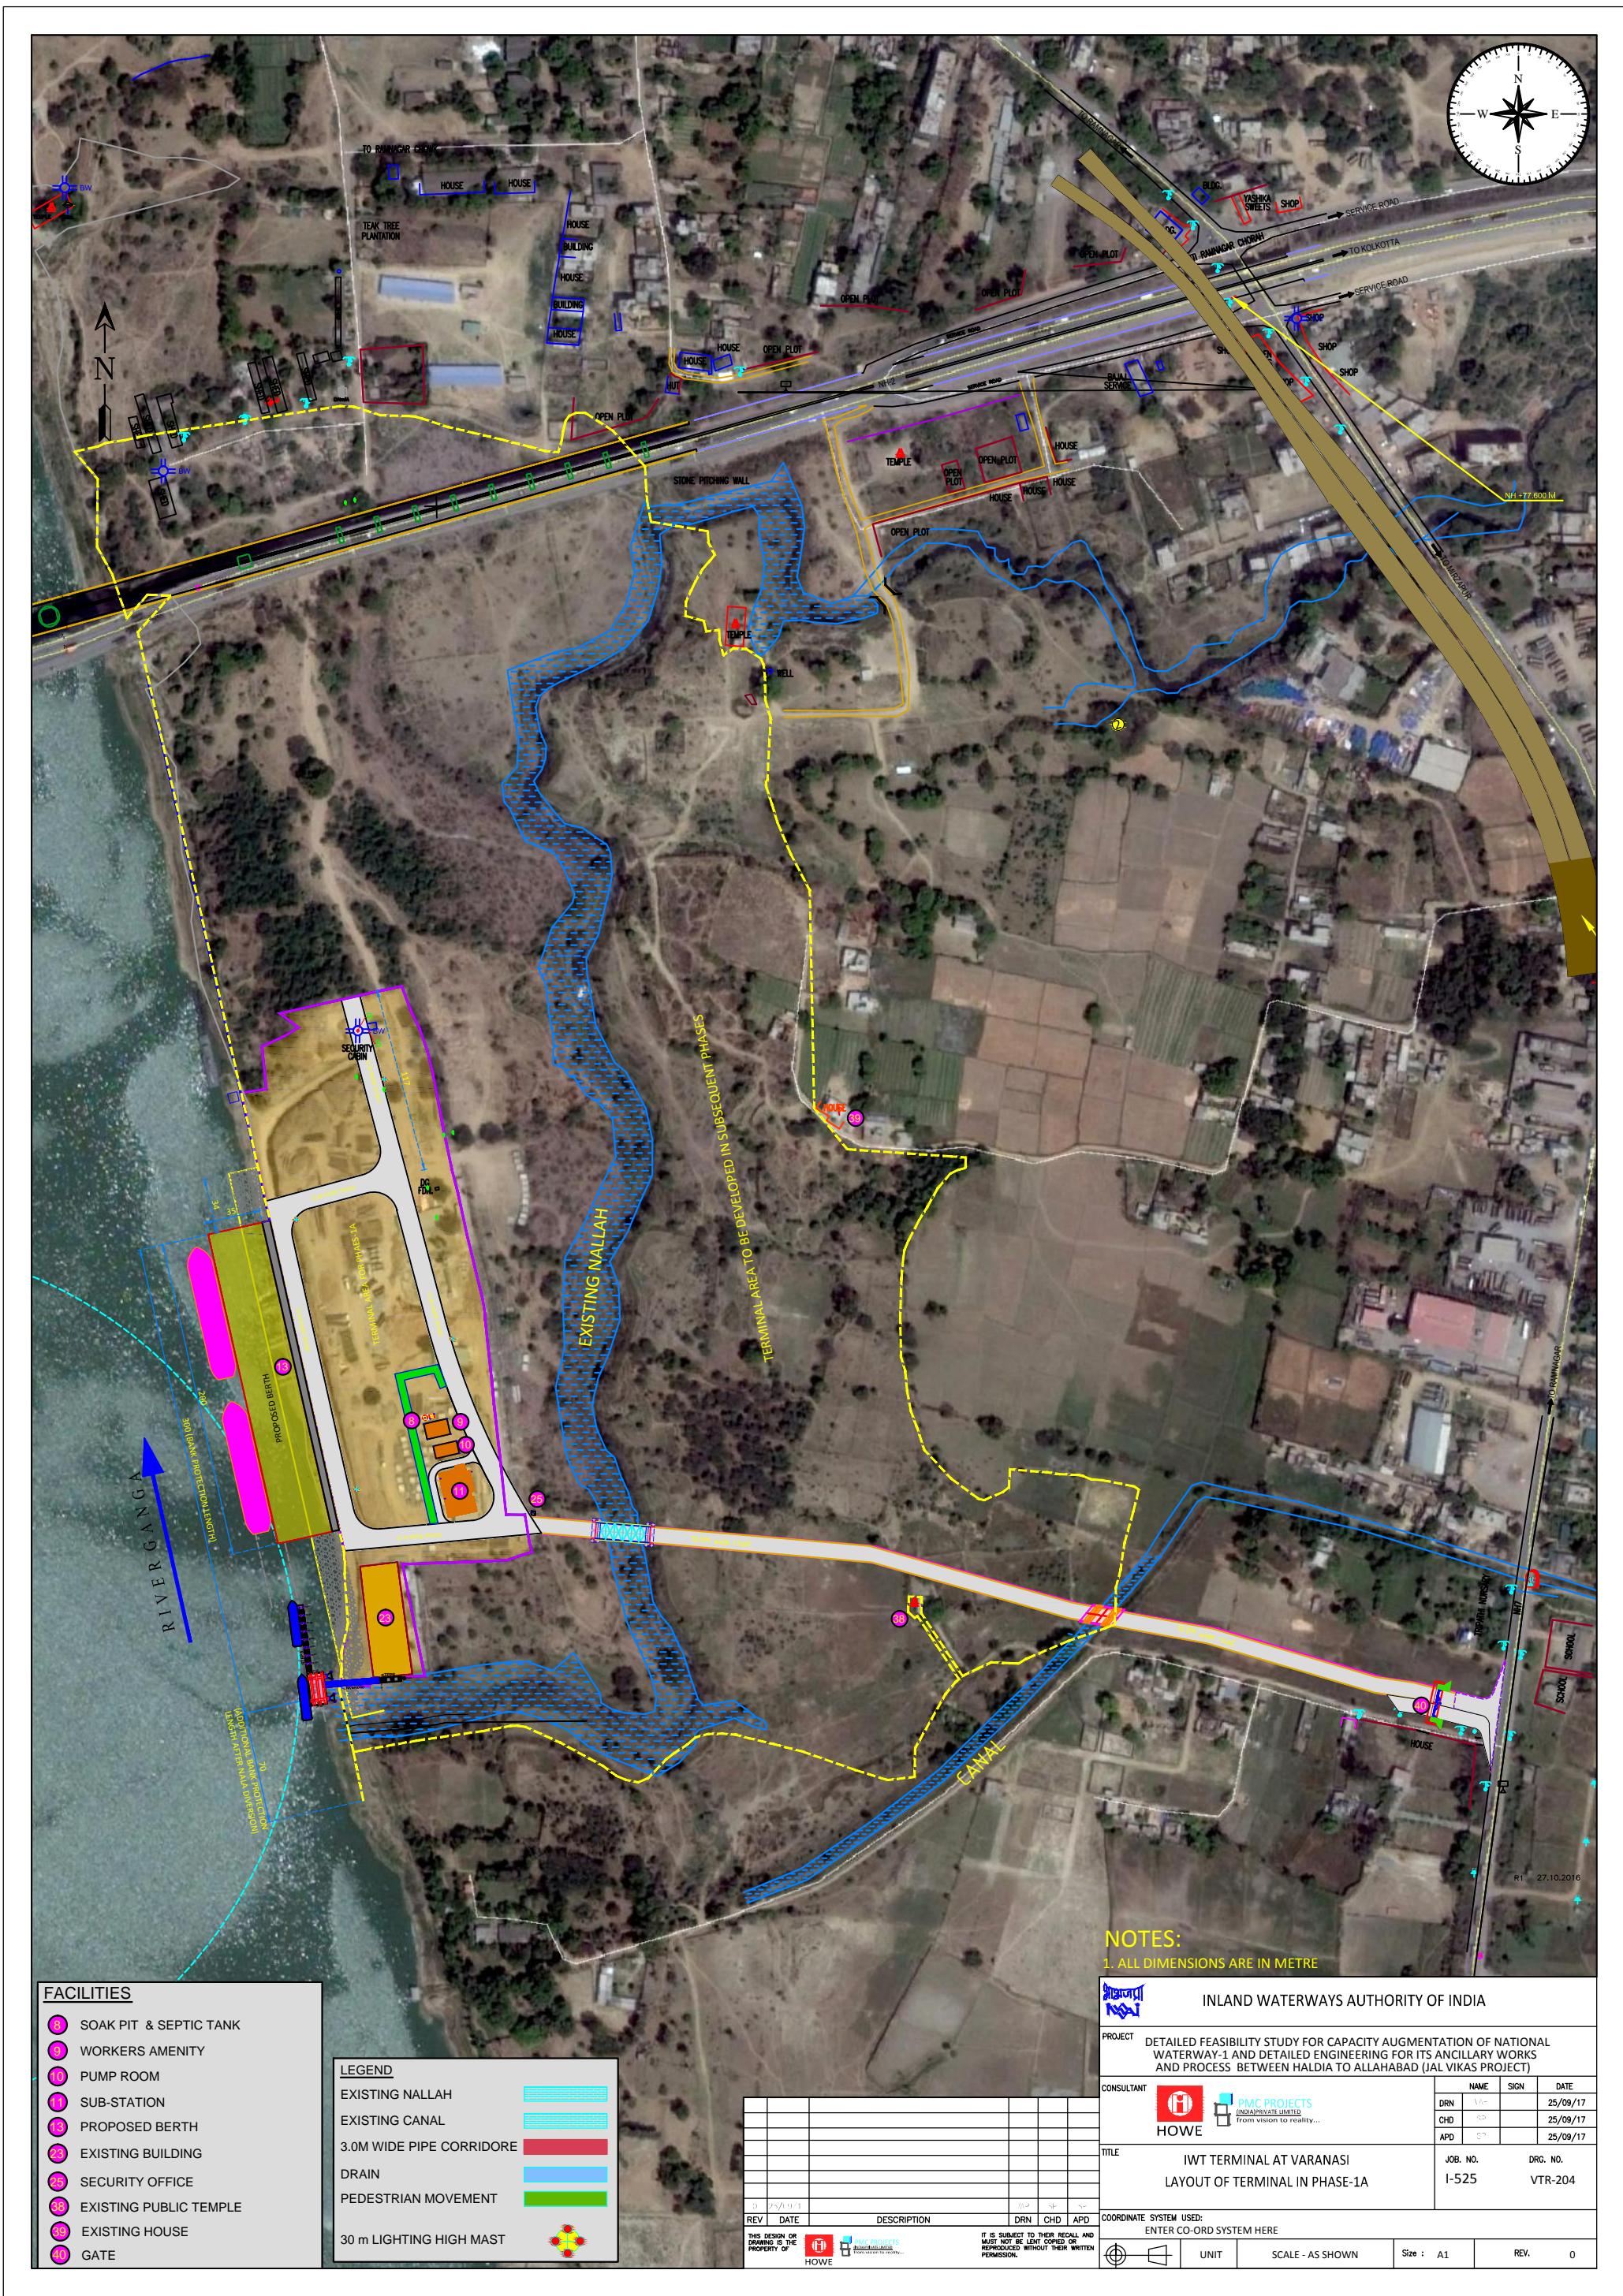

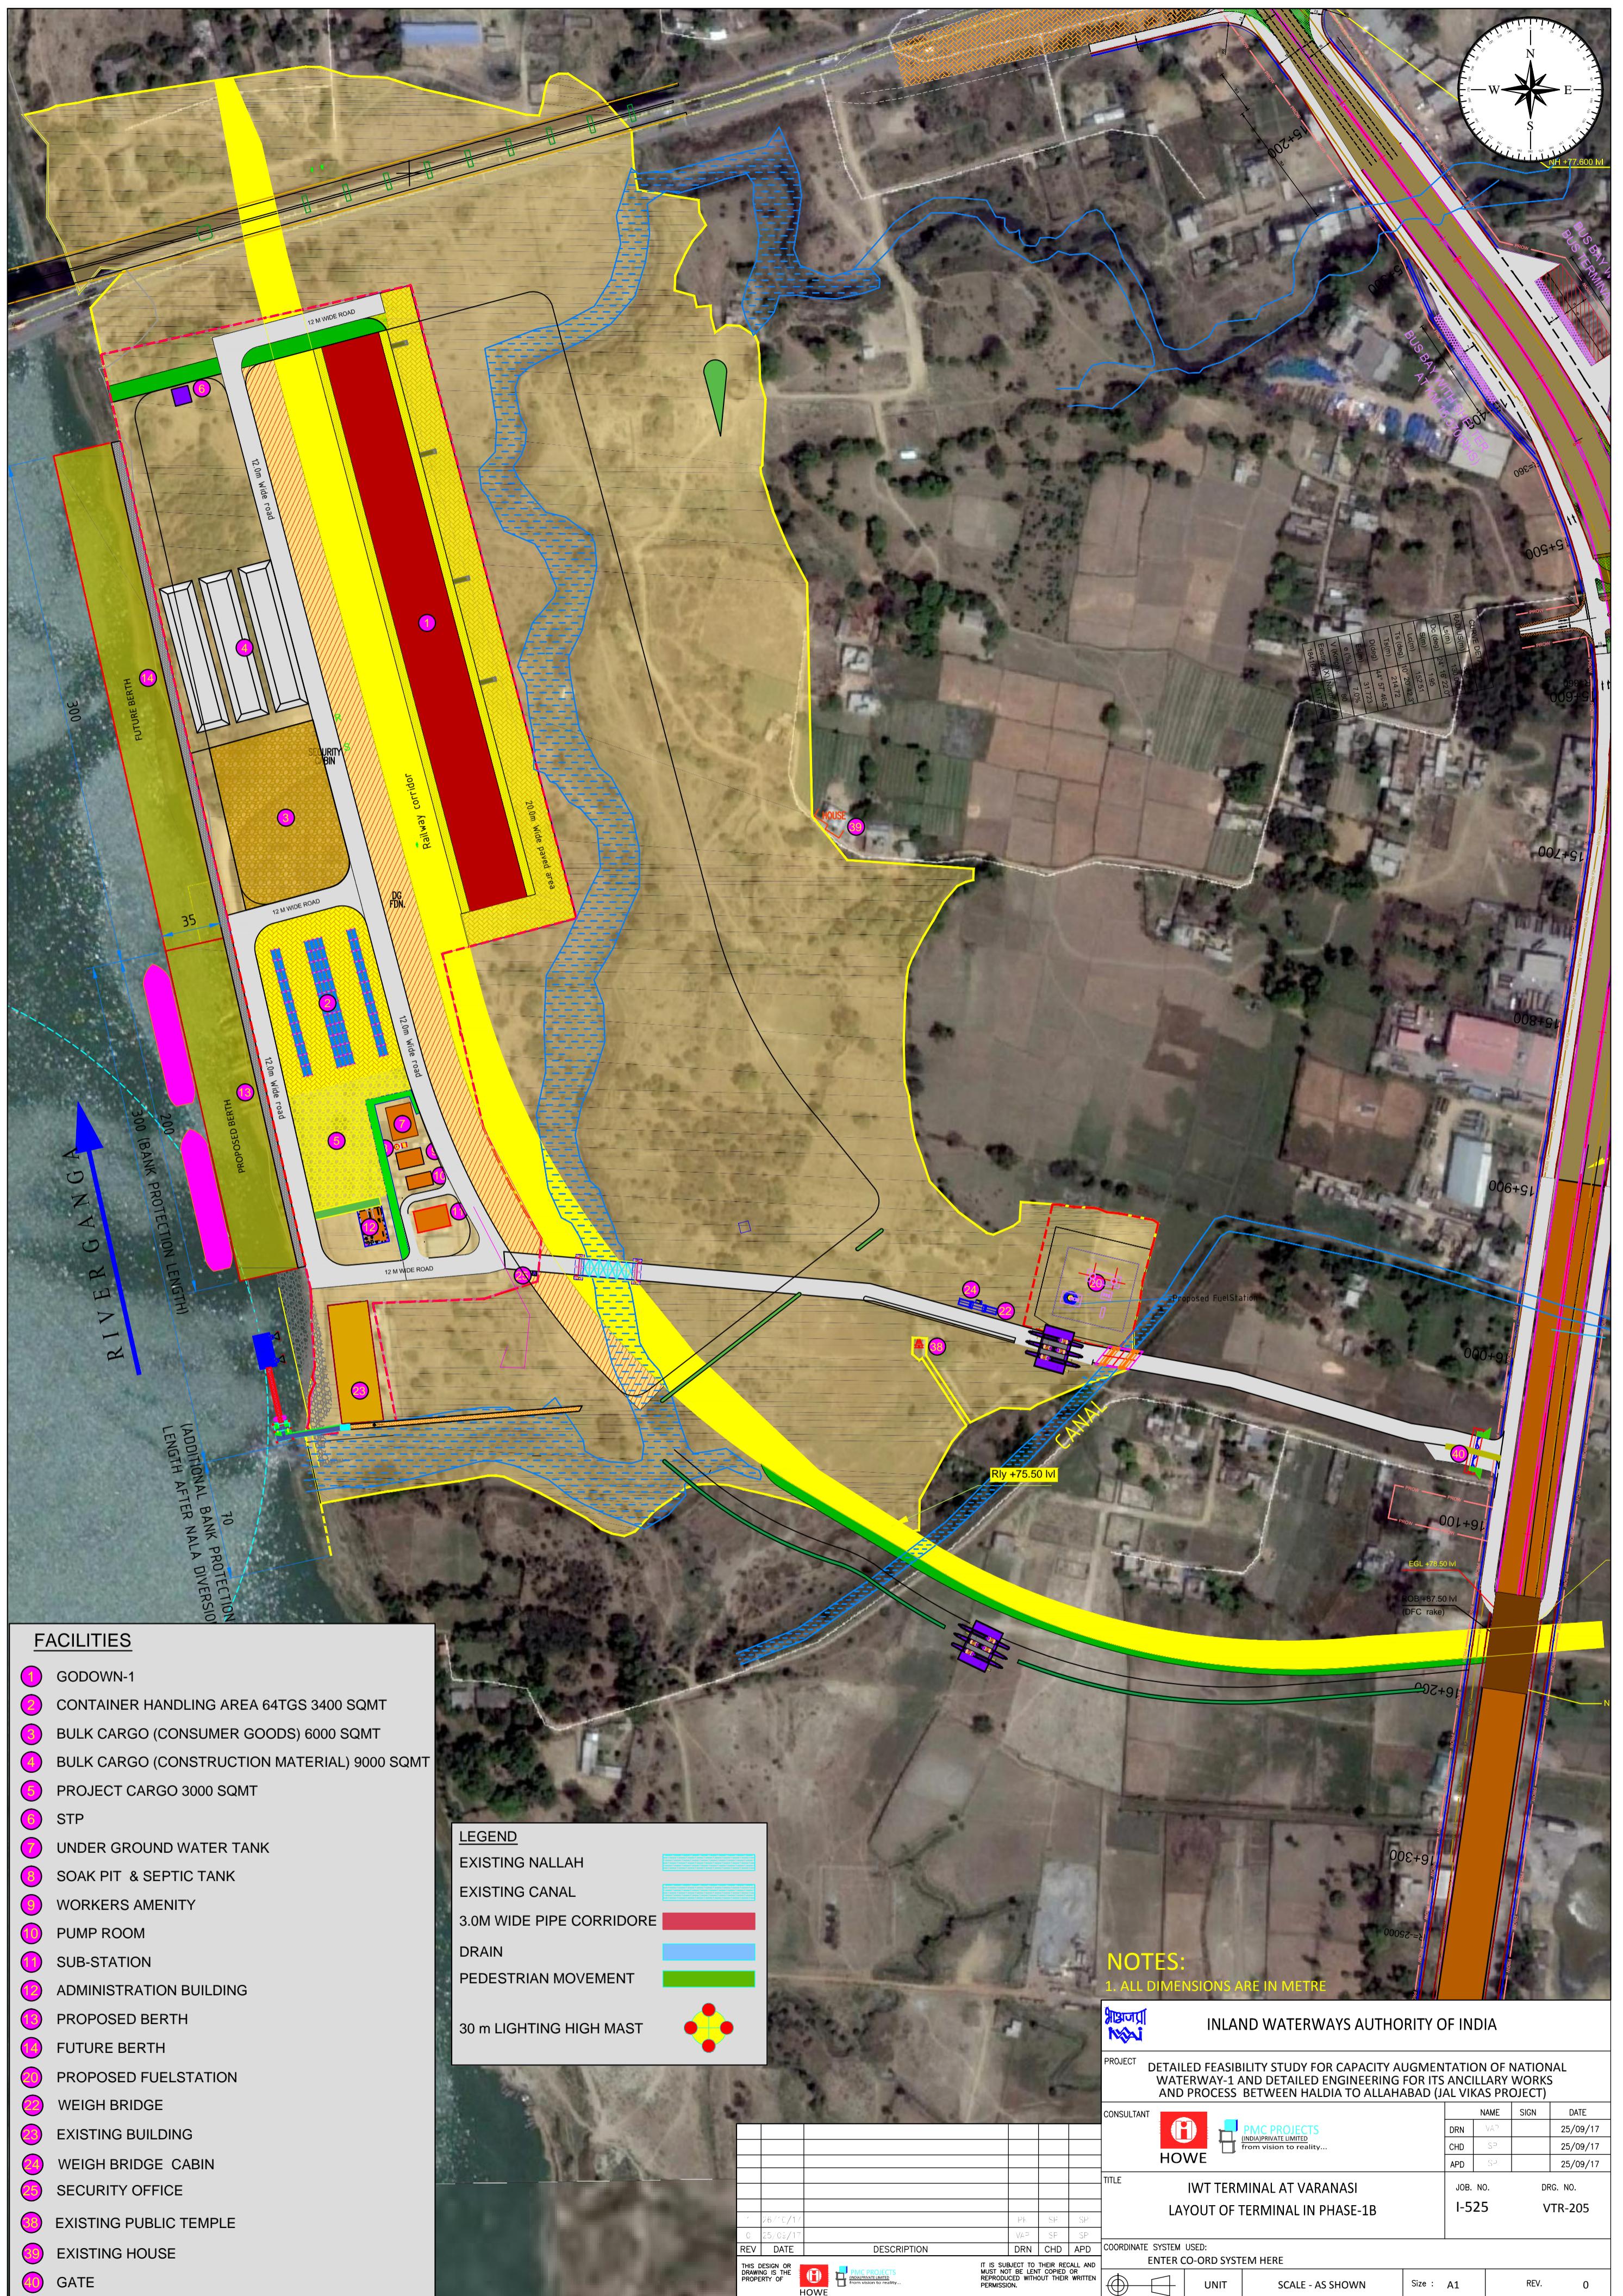

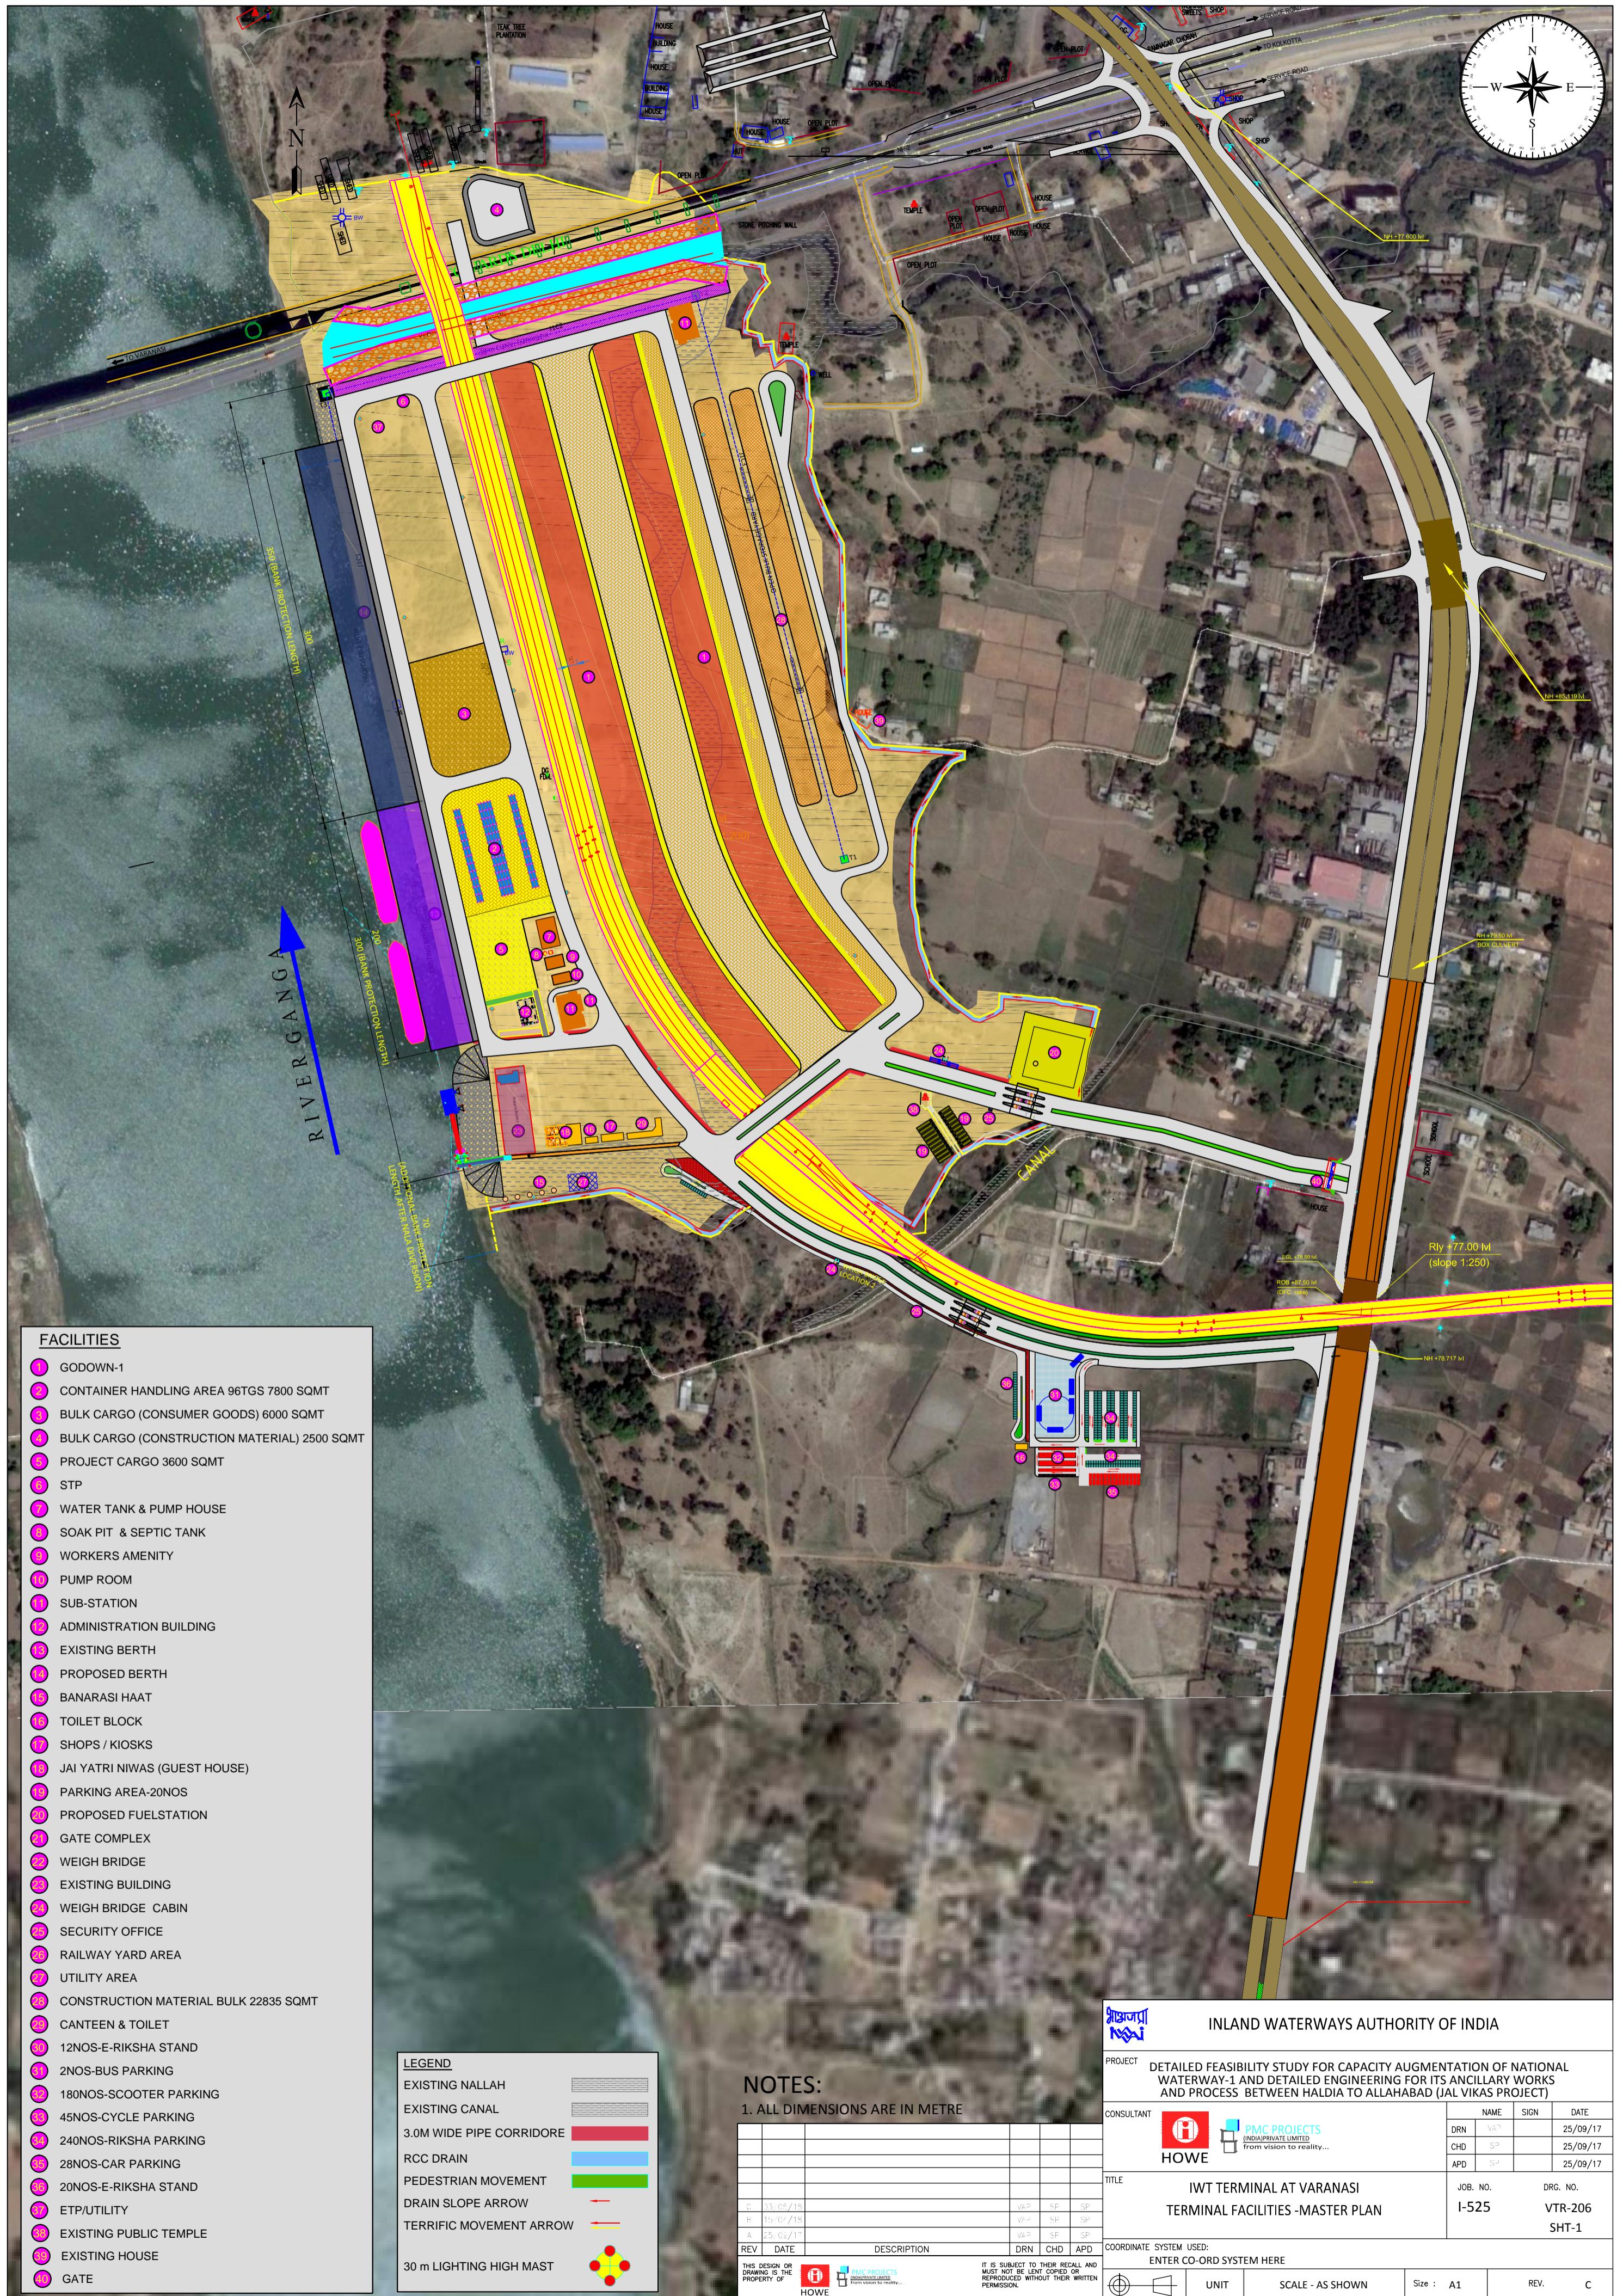

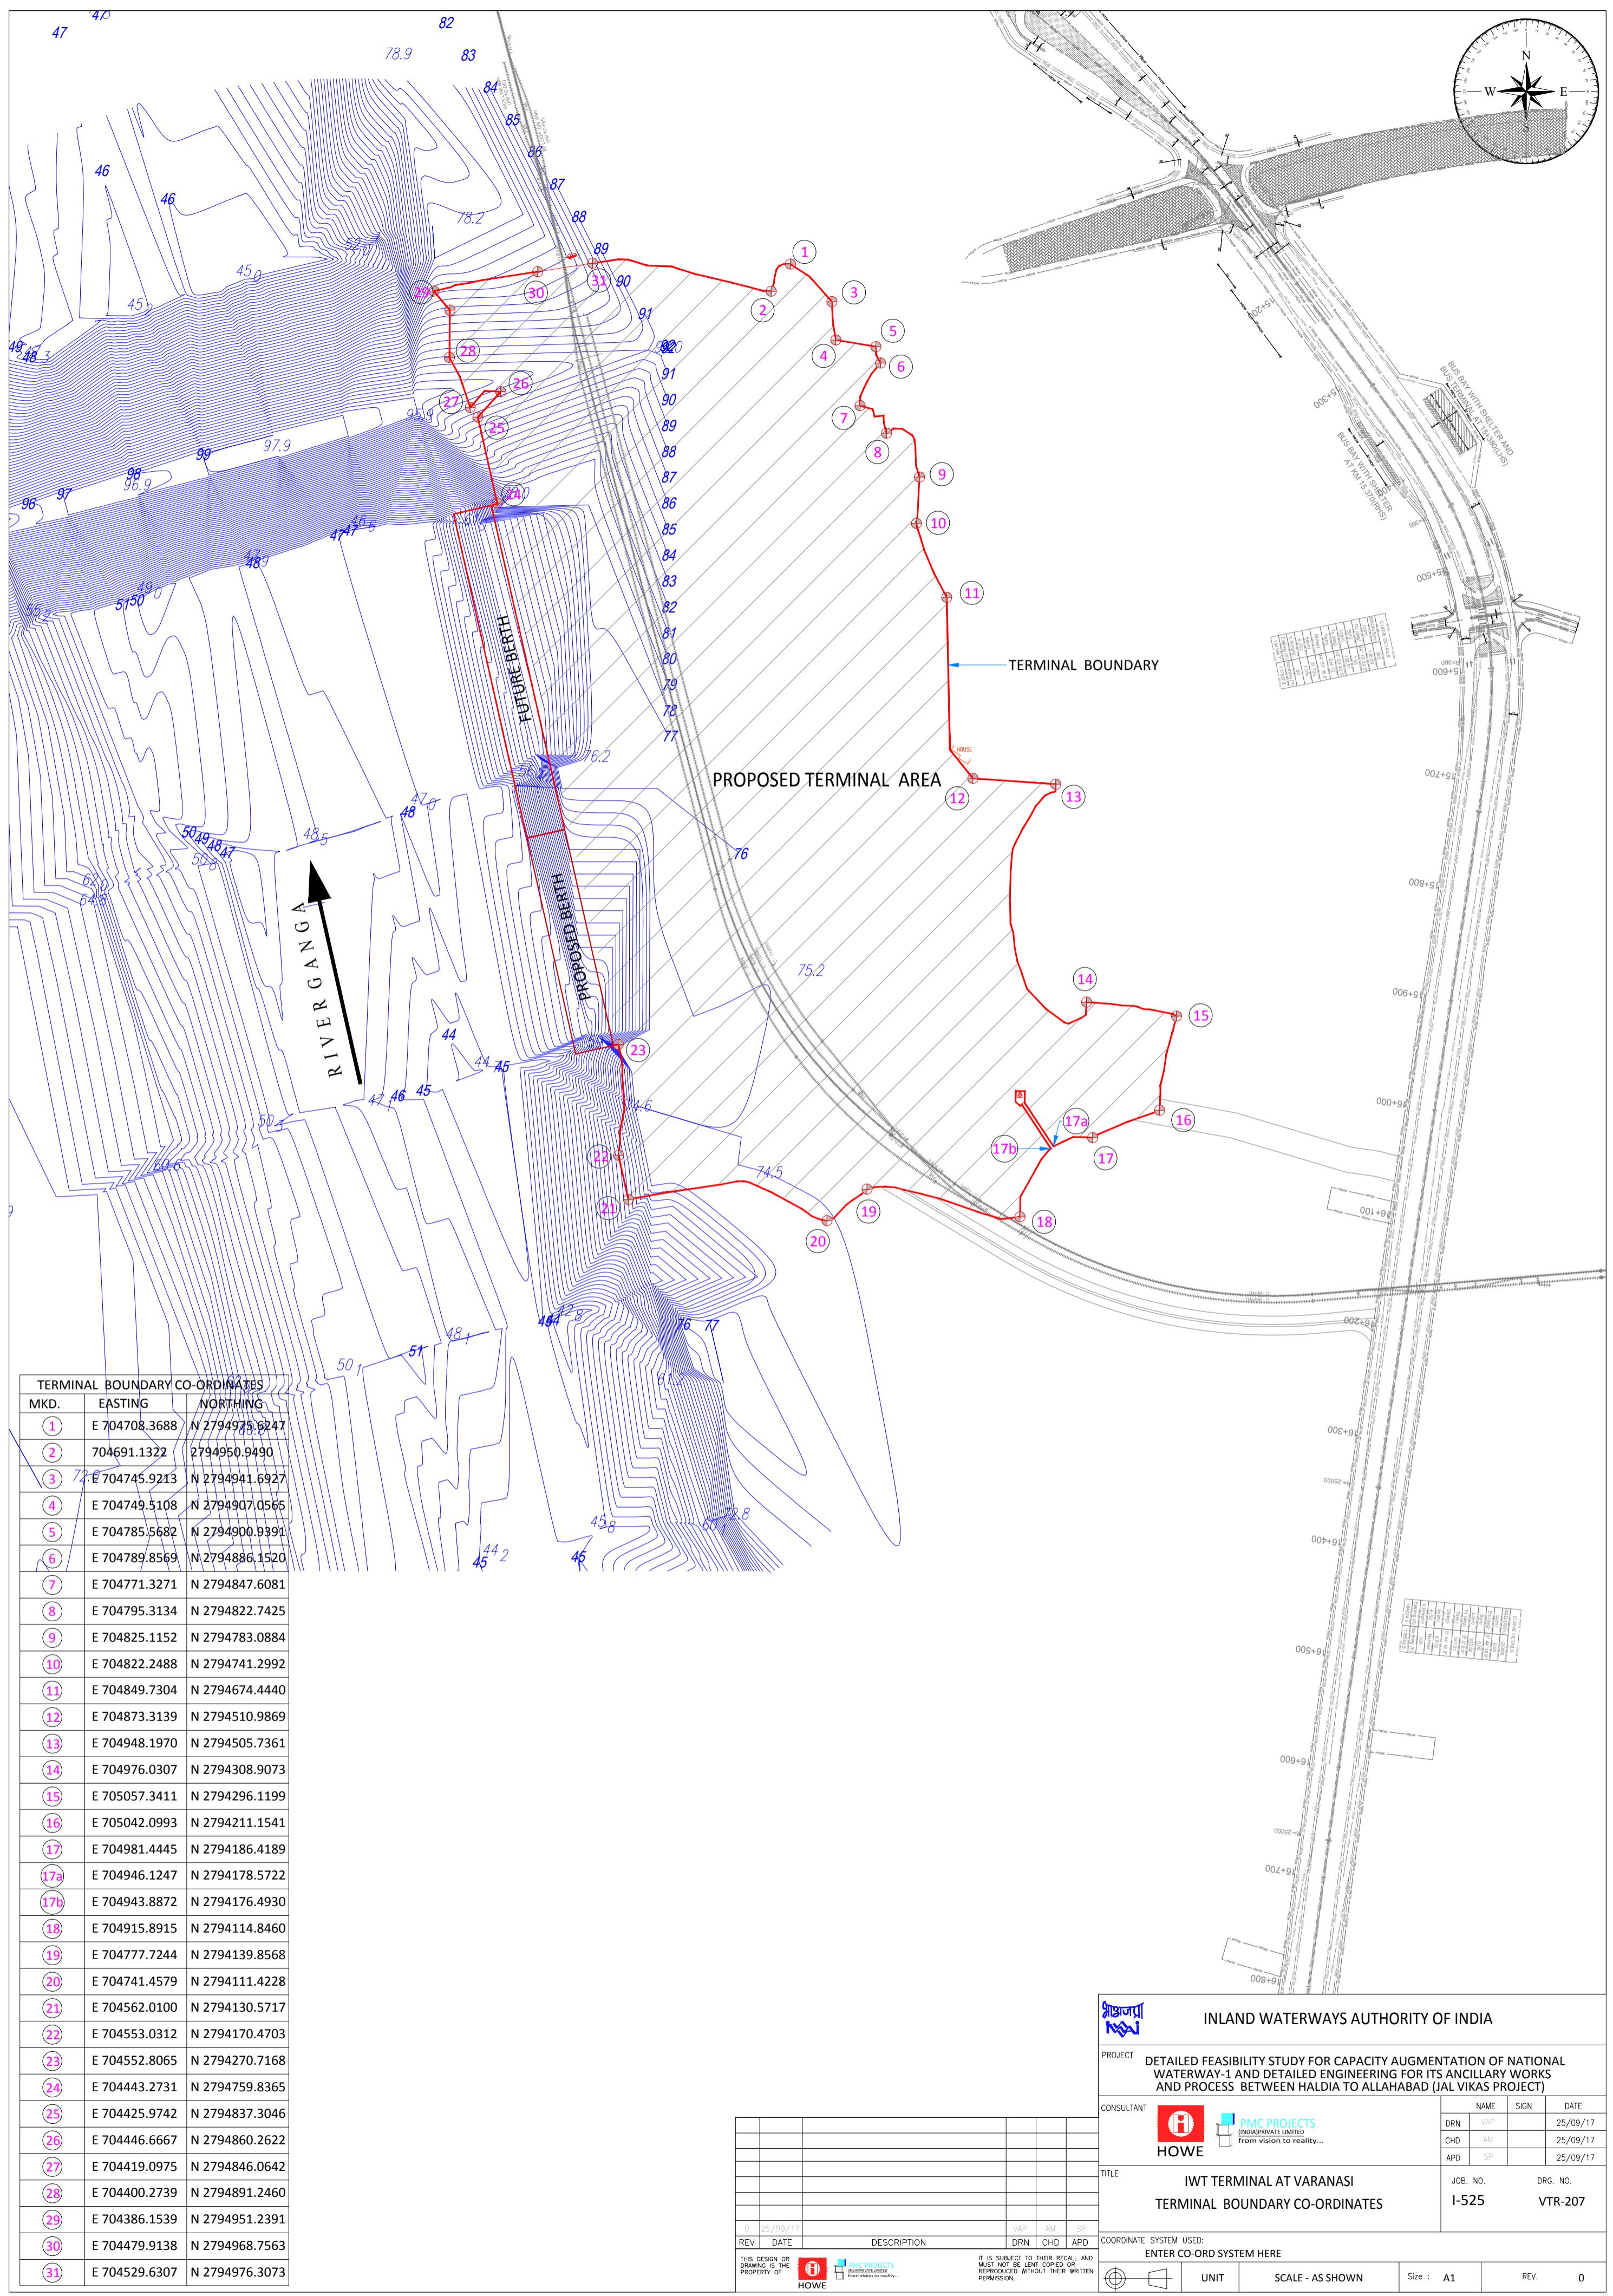

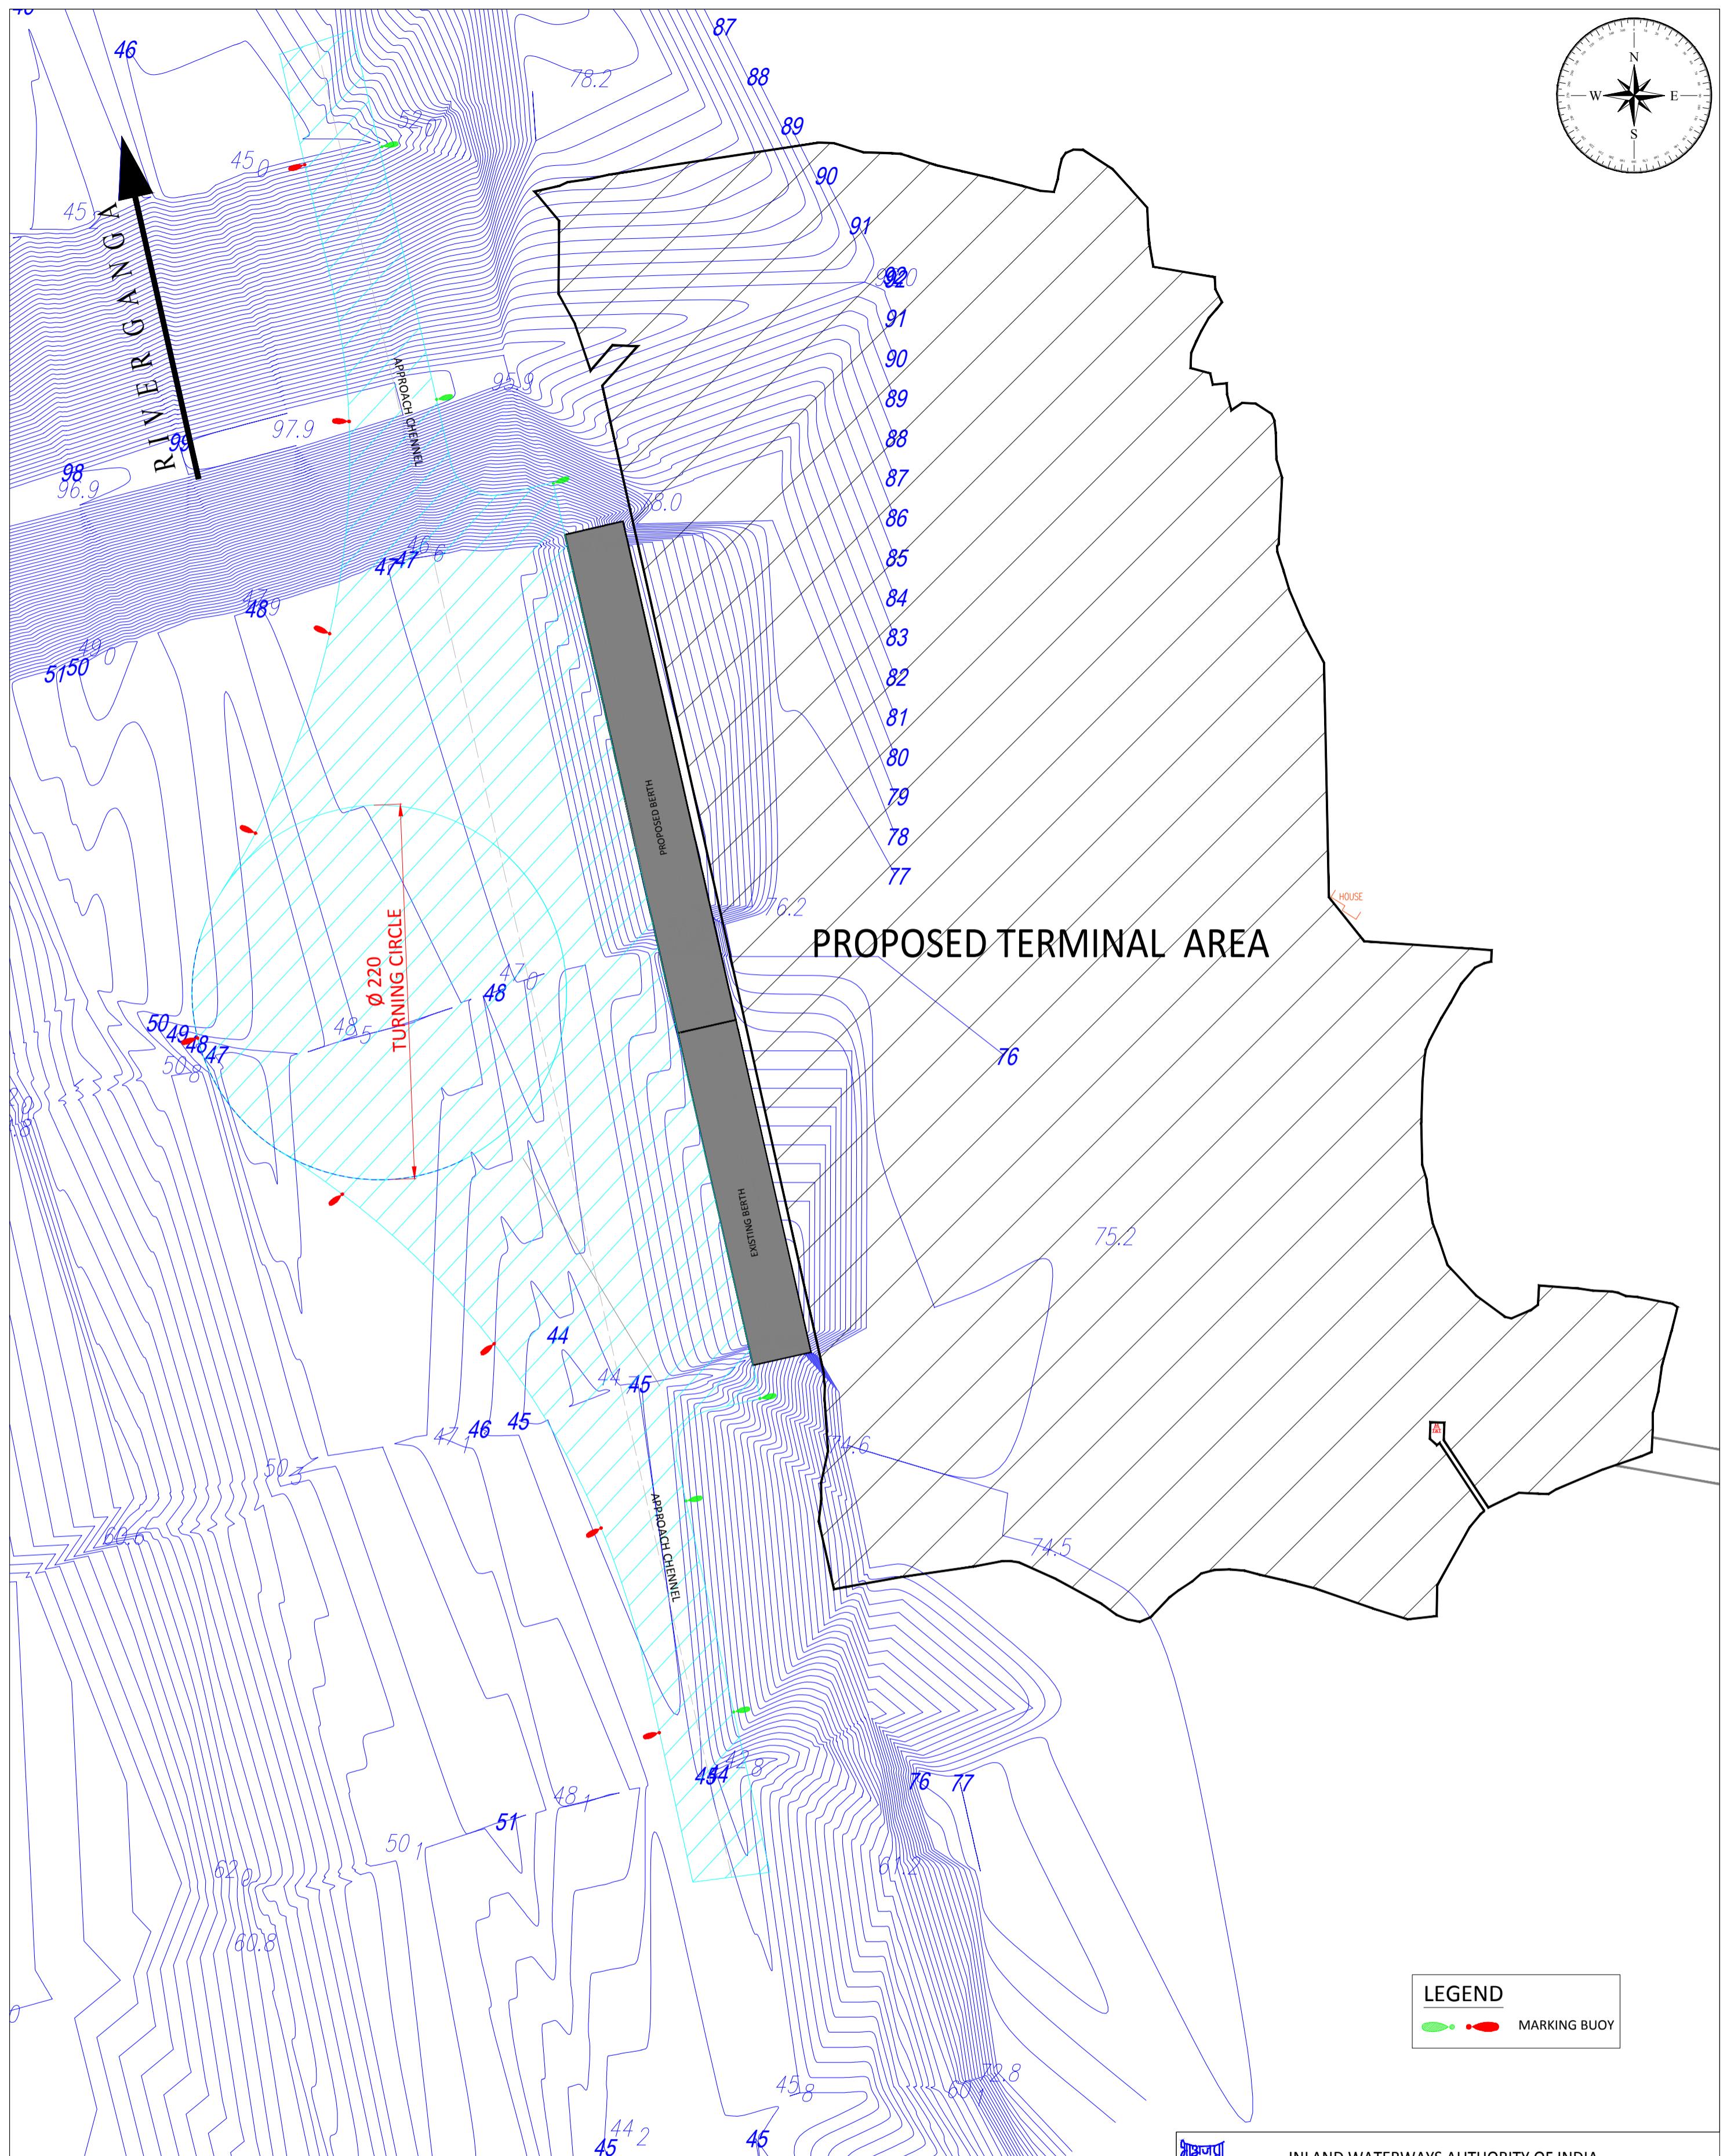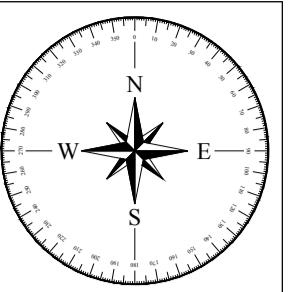

NOTES:

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2. ALL LEVELS ARE IN METRE & ARE WITH RESPECT TO MSL

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PROJECT DETAILED FEASIBILITY STUDY FOR CAPACITY AUGMENTATION OF NATIONAL WATERWAY-1 AND DETAILED ENGINEERING FOR ITS ANCILLARY WORKS AND PROCESS BETWEEN HALDIA TO ALLAHABAD (JAL VIKAS PROJECT)

CONSULTANT
HOWE

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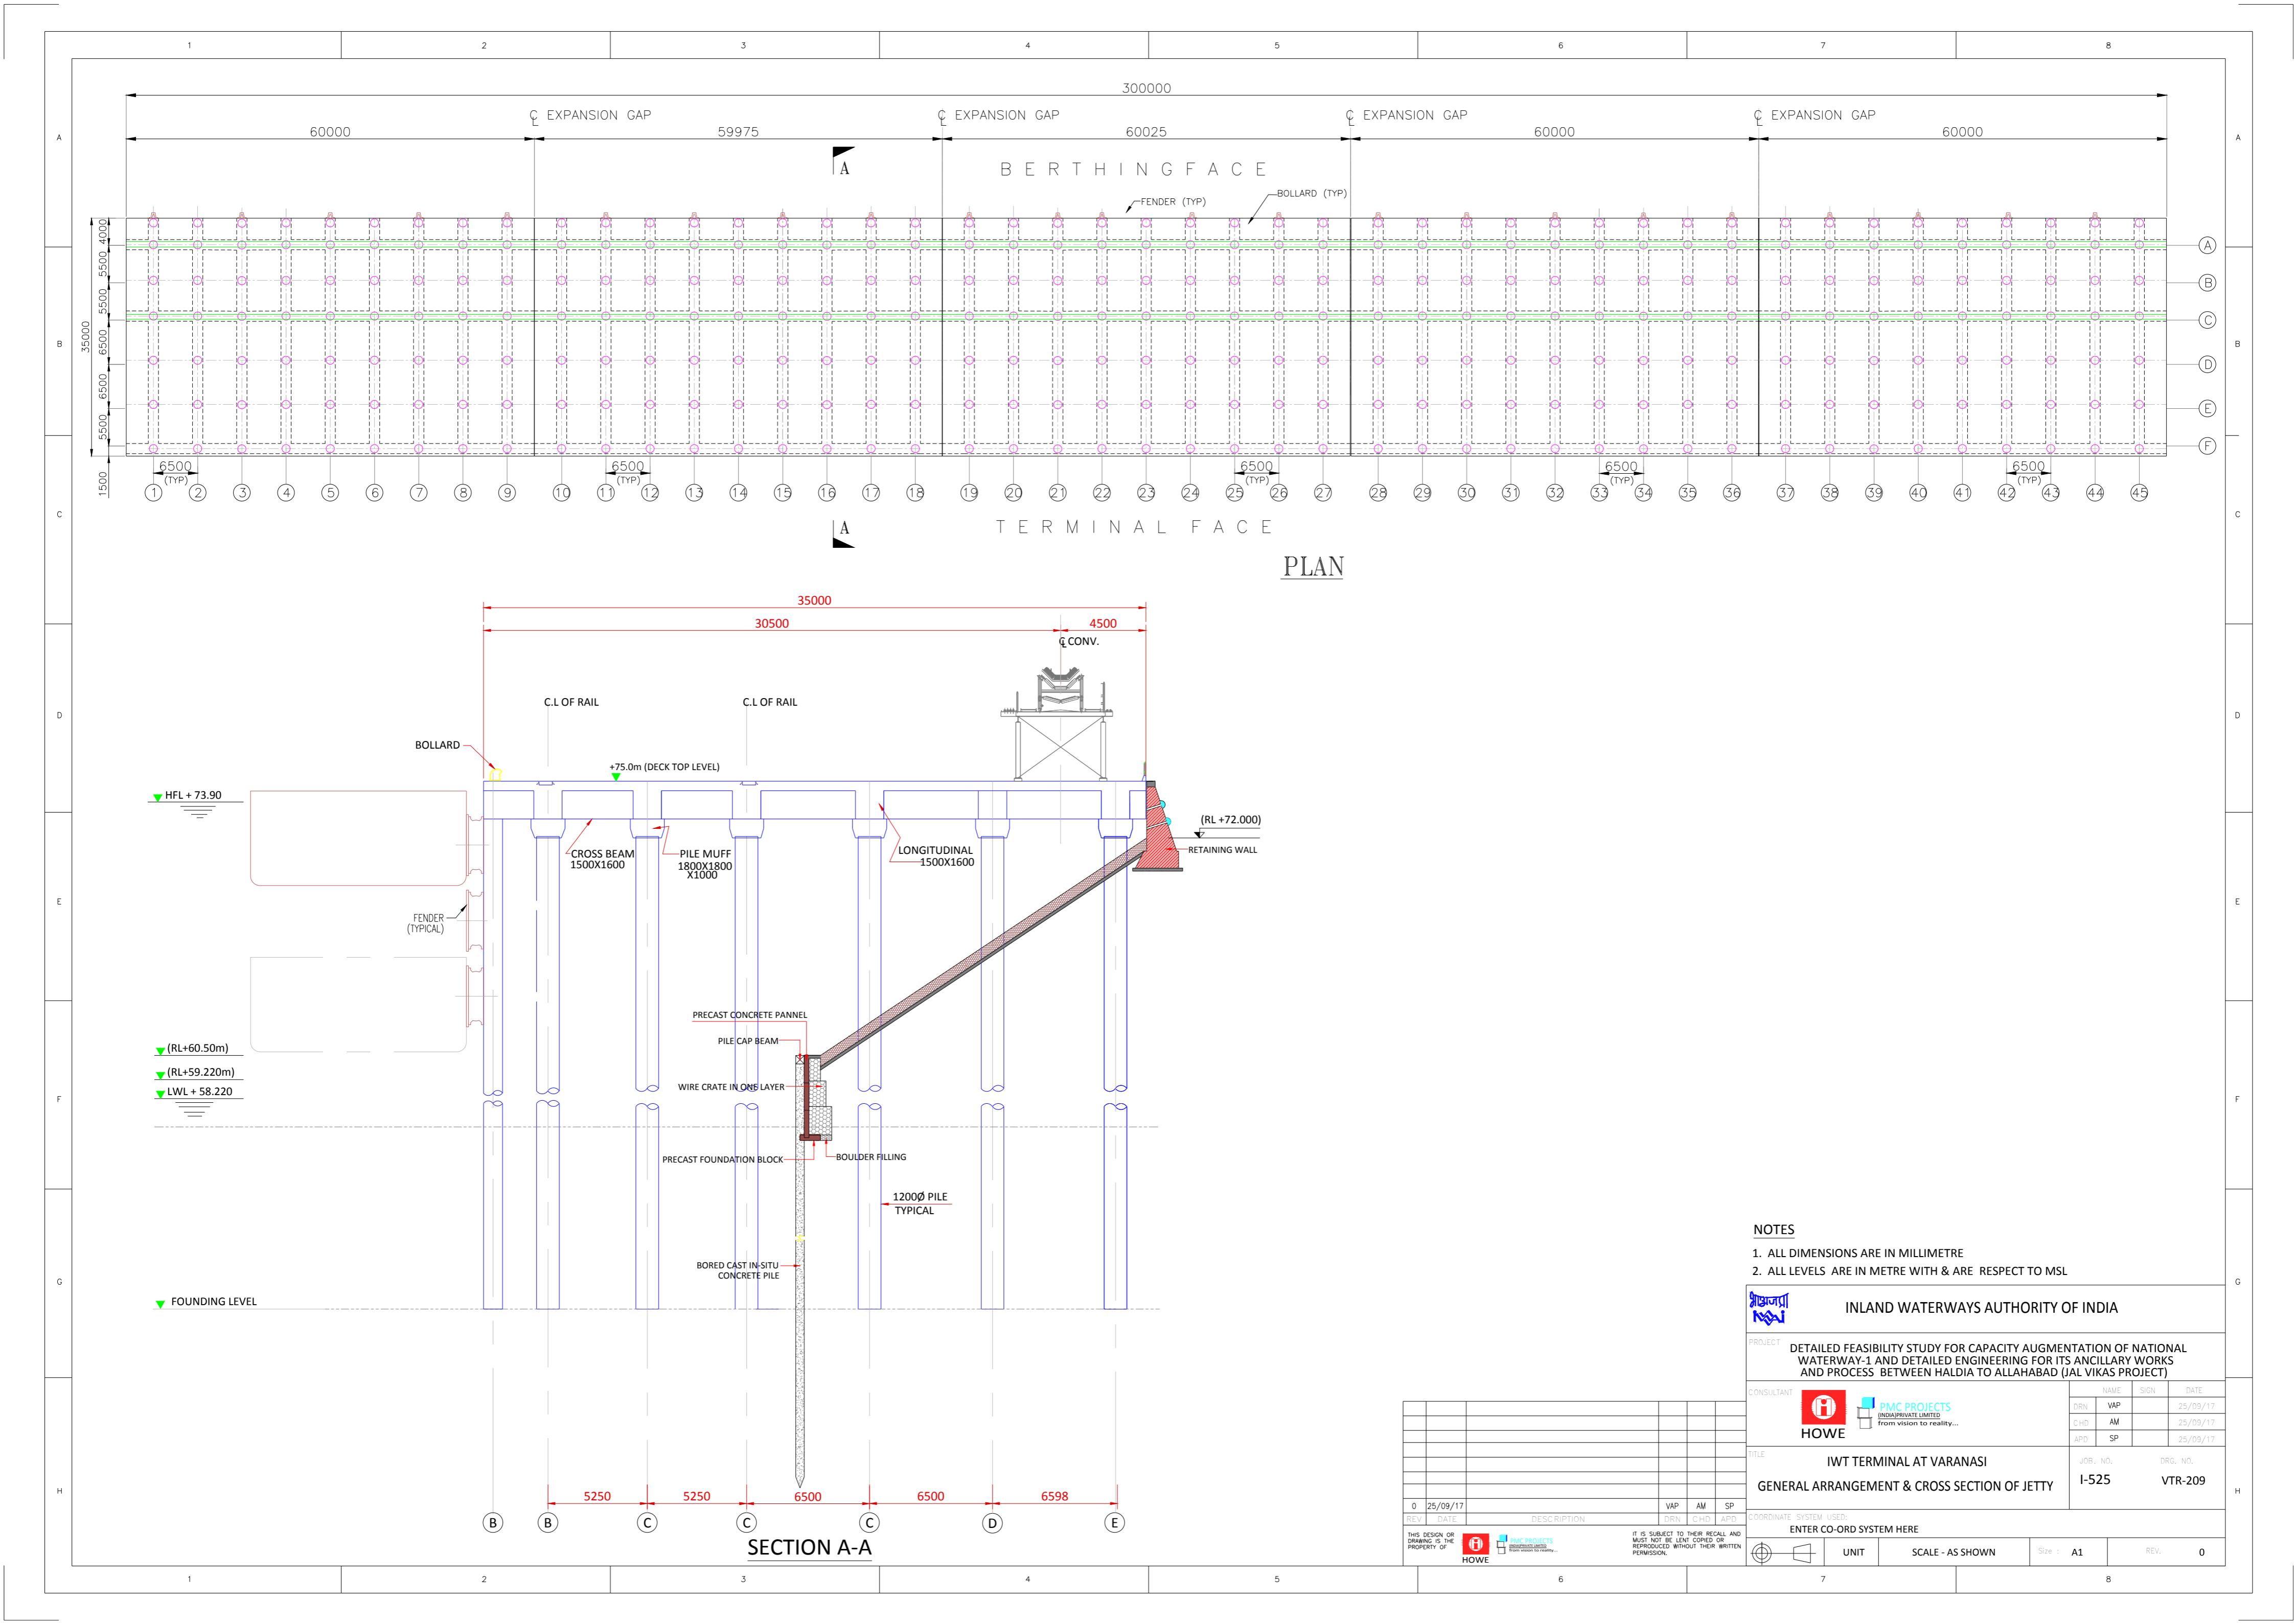
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DRN	VAP	25/09/17
CHD	AM	25/09/17
APD	SP	25/09/17


TITLE IWT TERMINAL AT VARANASI
LAYOUT OF AIDS TO NAVIGATION

JOB. NO. I-525 DRG. NO. VTR-208

COORDINATE SYSTEM USED:
ENTER CO-ORD SYSTEM HERE

UNIT SCALE - AS SHOWN Size : A1 REV. 0



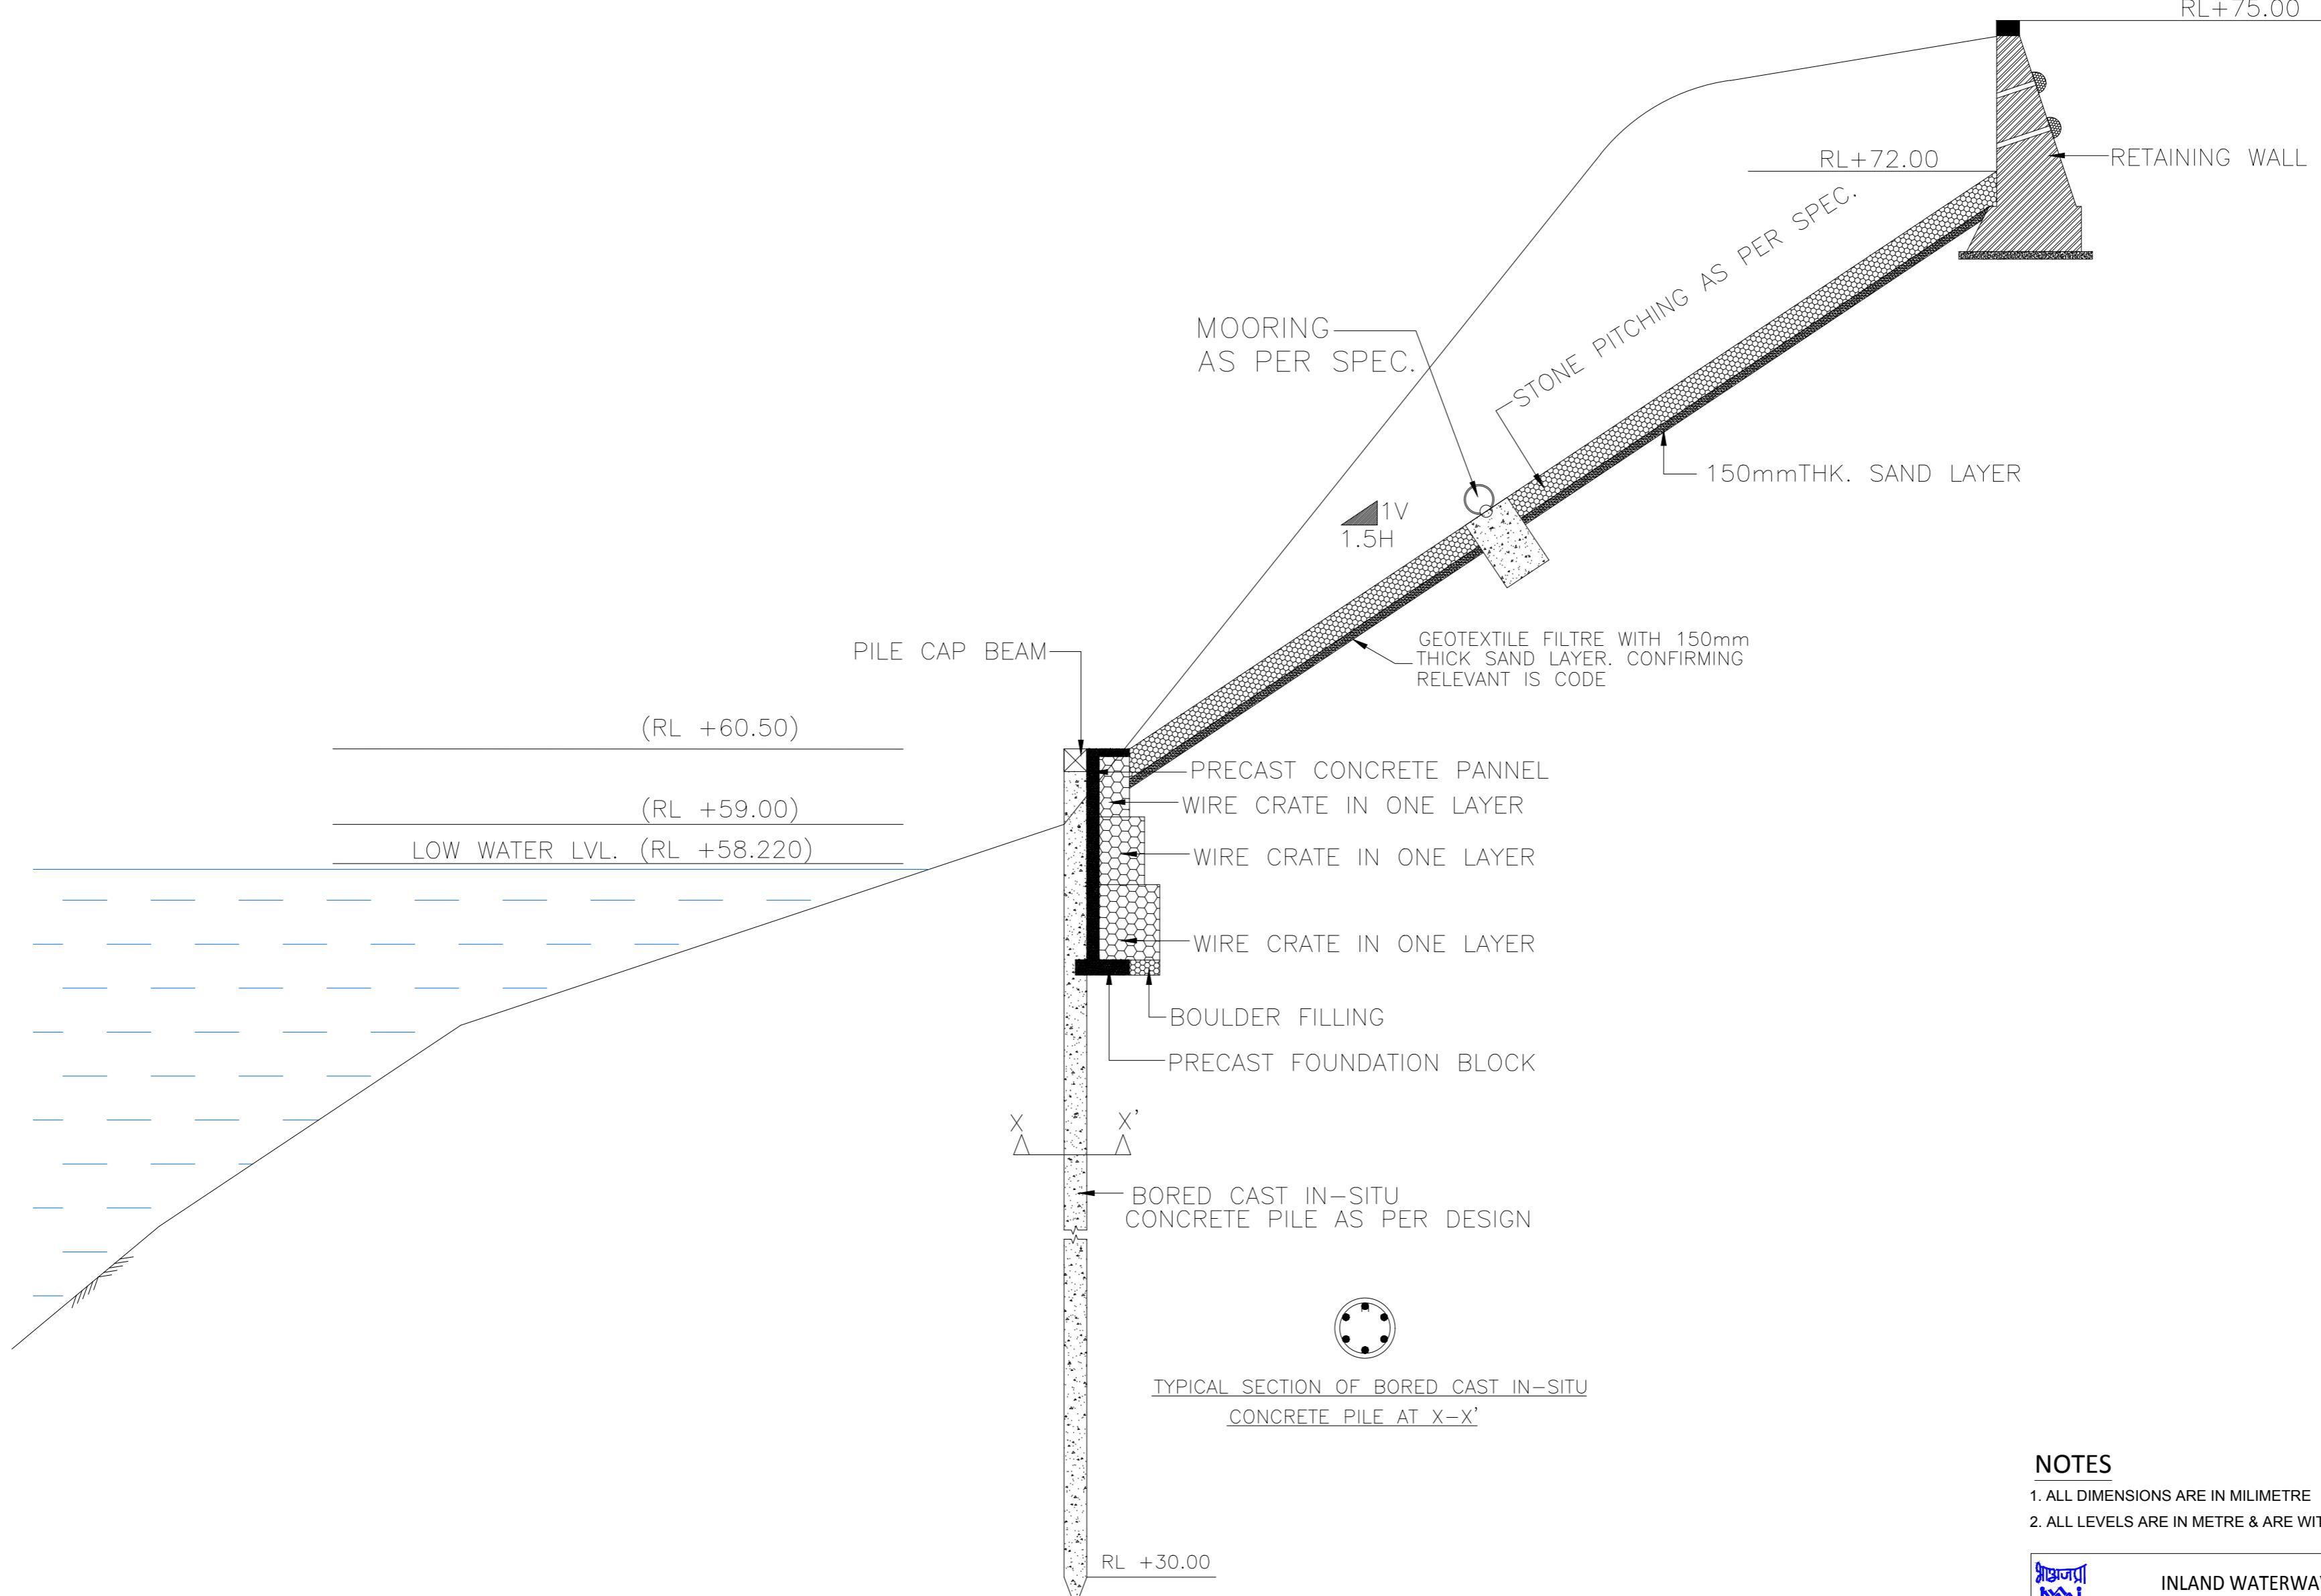

TYPICAL SECTION OF BORED CAST IN-SITU CONCRETE PILE AT X-X'


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- ALL DIMENSIONS ARE IN MILLIMETRE
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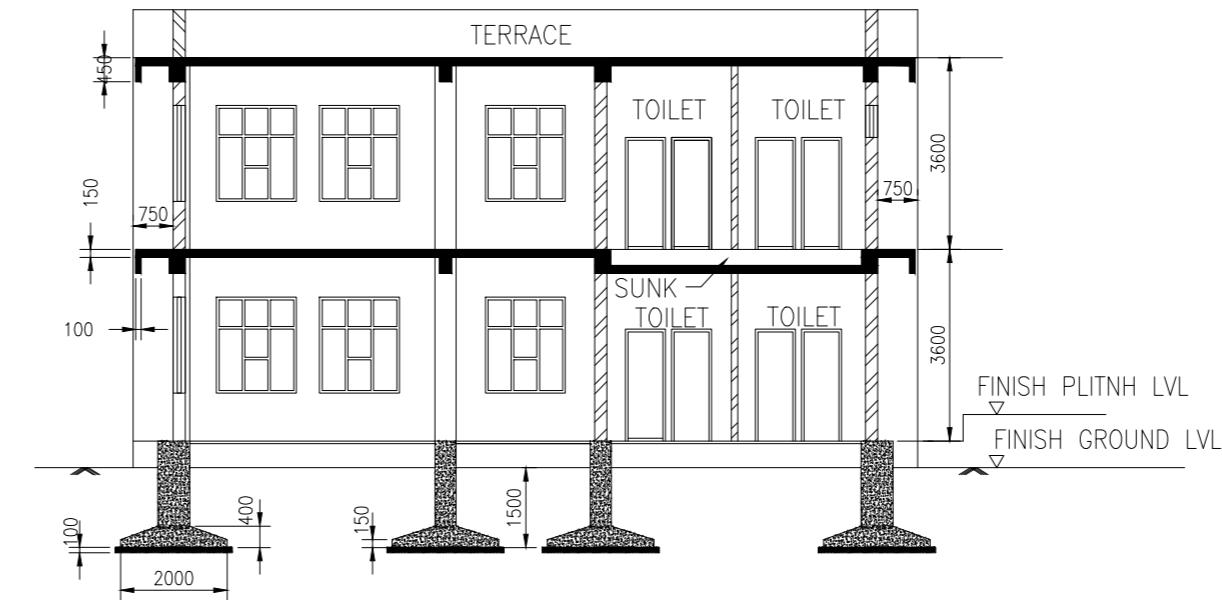
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PROJECT		DETAILED FEASIBILITY STUDY FOR CAPACITY AUGMENTATION OF NATIONAL WATERWAY-1 AND DETAILED ENGINEERING FOR ITS ANCILLARY WORKS AND PROCESS BETWEEN HALDIA TO ALLAHABAD (JAL VIKAS PROJECT)		
CONSULTANT		HOWE PMC PROJECTS (INDIA) PRIVATE LIMITED from vision to reality...		
REV	DATE	VAP	AM	SP
0	25/09/17			
		DRN	CHD	APP
TITLE IWT TERMINAL AT VARANASI				
TYPICAL DETAIL OF SHORE PROTECTION WORK				
COORDINATE SYSTEM USED: ENTER CO-ORD SYSTEM HERE				
	UNIT	SCALE - AS SHOWN	Size : A1	REV. 0

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SECTION A-A



SECTION B-B

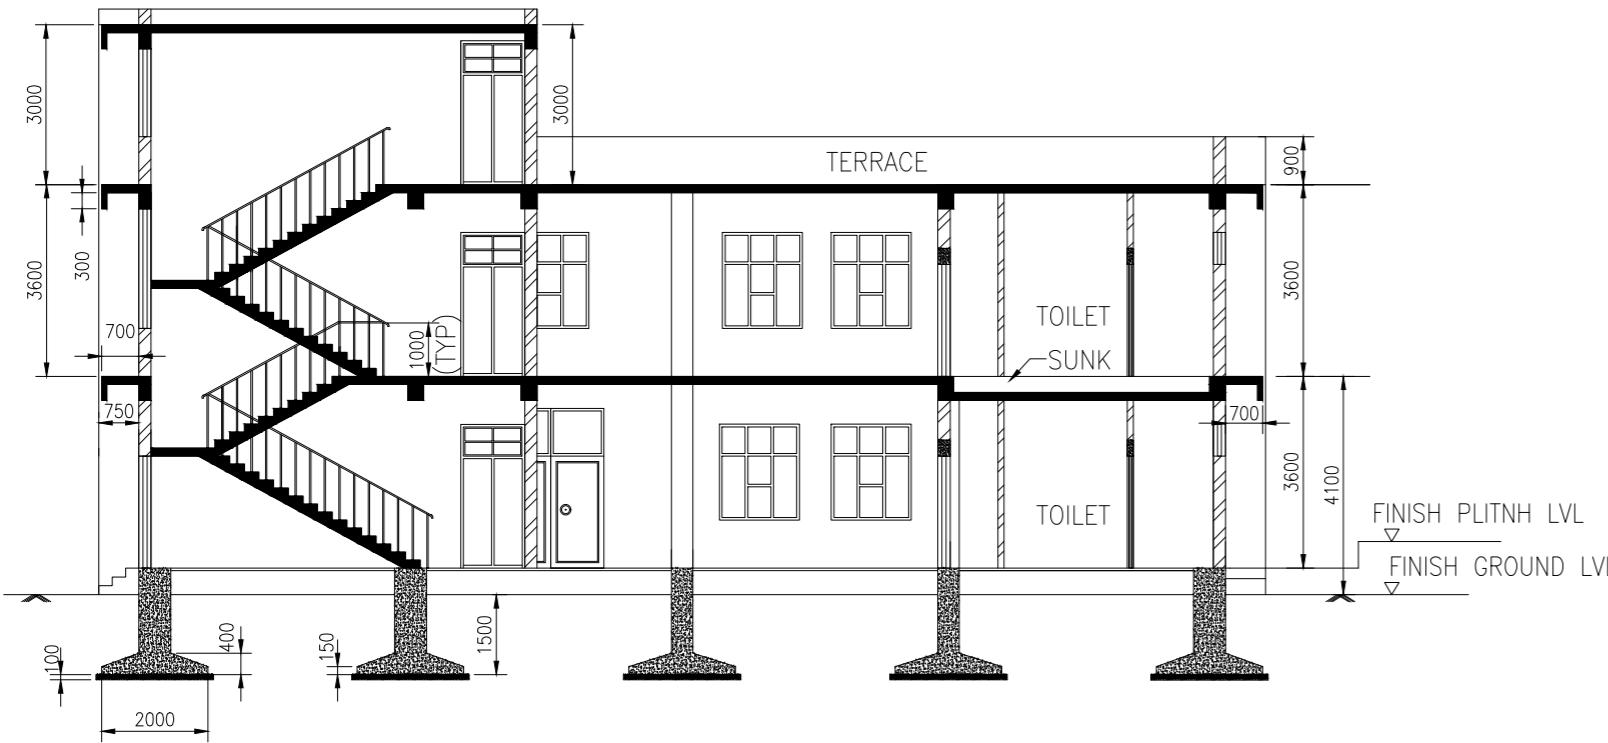

FRONT ELEVATION






REAR ELEVATION

NOTES

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PROJECT	DETAILED FEASIBILITY STUDY FOR CAPACITY AUGMENTATION OF NATIONAL WATERWAY-1 AND DETAILED ENGINEERING FOR ITS ANCILLARY WORKS AND PROCESS BETWEEN HALDIA TO ALLAHABAD (JAL VIKAS PROJECT)														
CONSULTANT	HOWE	PMC PROJECTS (INDIA) PRIVATE LIMITED from vision to reality...	<table border="1"> <tr> <td>NAME</td> <td>SIGN</td> <td>DATE</td> </tr> <tr> <td>DRN</td> <td>VAP</td> <td>05/09/17</td> </tr> <tr> <td>CHD</td> <td>DNS</td> <td>05/09/17</td> </tr> <tr> <td>APD</td> <td>SP</td> <td>05/09/17</td> </tr> </table>	NAME	SIGN	DATE	DRN	VAP	05/09/17	CHD	DNS	05/09/17	APD	SP	05/09/17
NAME	SIGN	DATE													
DRN	VAP	05/09/17													
CHD	DNS	05/09/17													
APD	SP	05/09/17													
TITLE	IWT TERMINAL AT VARANASI		JOB. NO. DRG. NO.												
TYPICAL ELEVATION OF TERMINAL ADMINISTRATION BUILDING		I-525	VTR-211												
SHEET-2 OF 2			SHEET-2 OF 2												
COORDINATE SYSTEM USED: ENTER CO-ORD SYSTEM HERE															
		UNIT	SCALE - AS SHOWN												
			Size : A1												
			REV. 0												

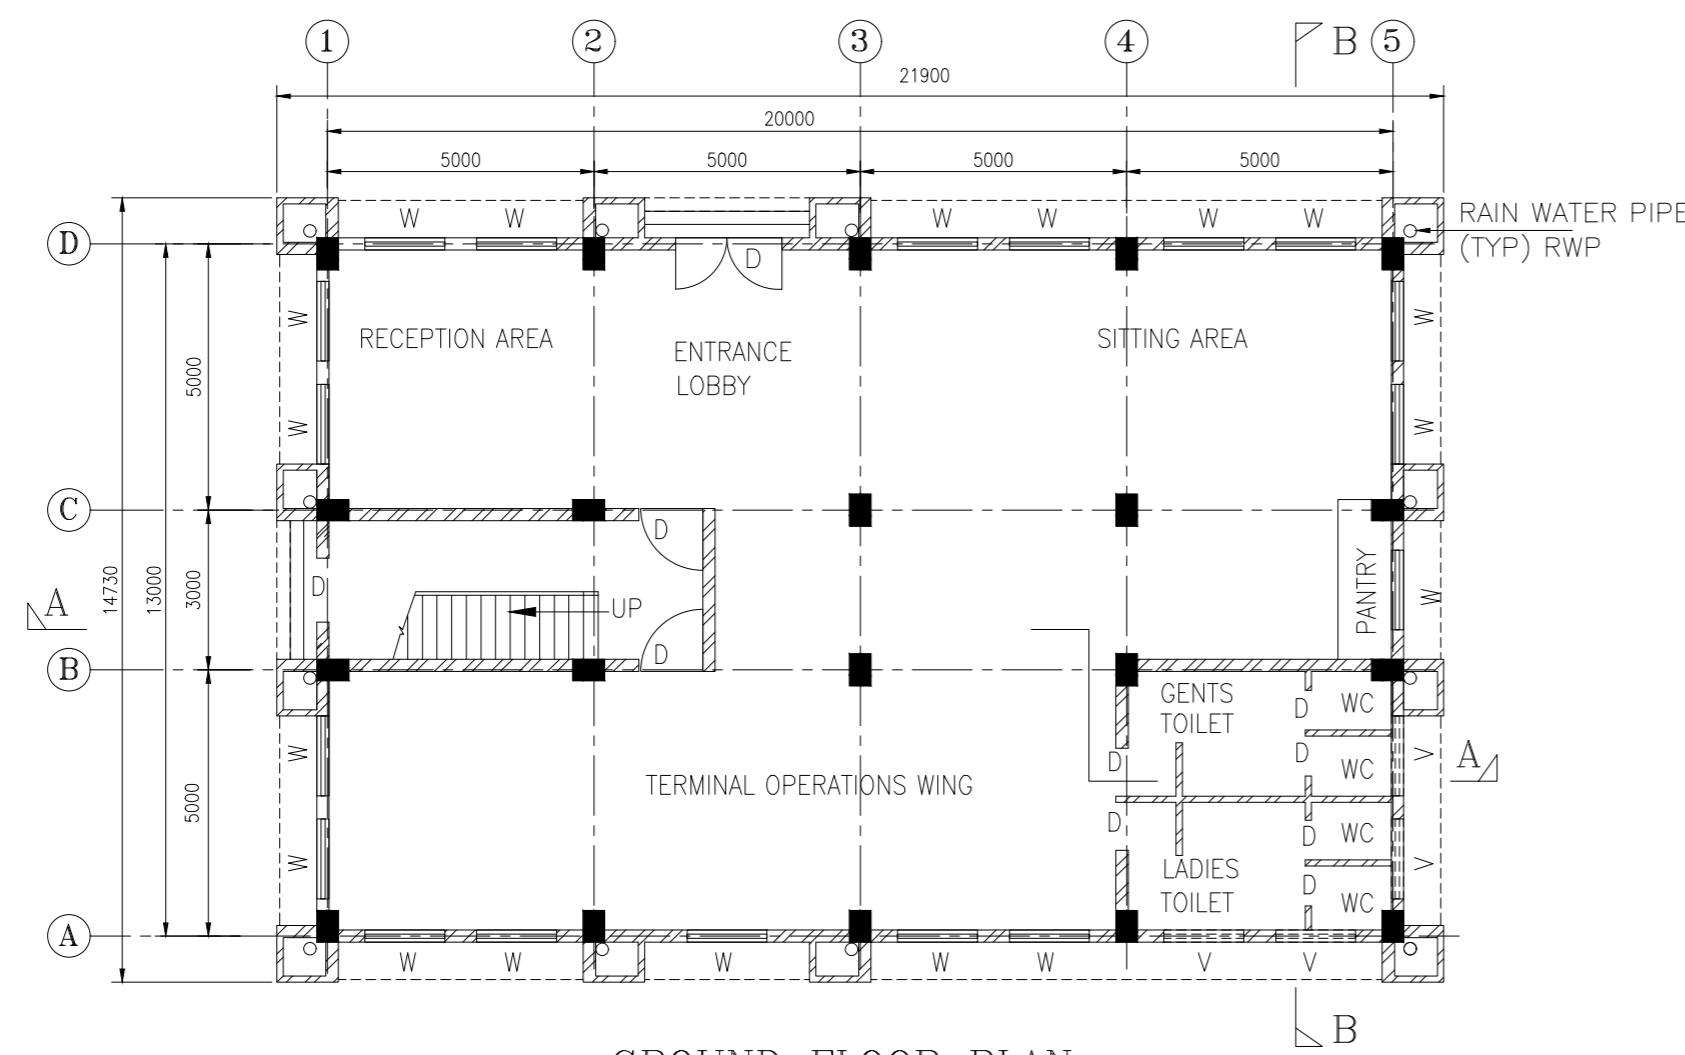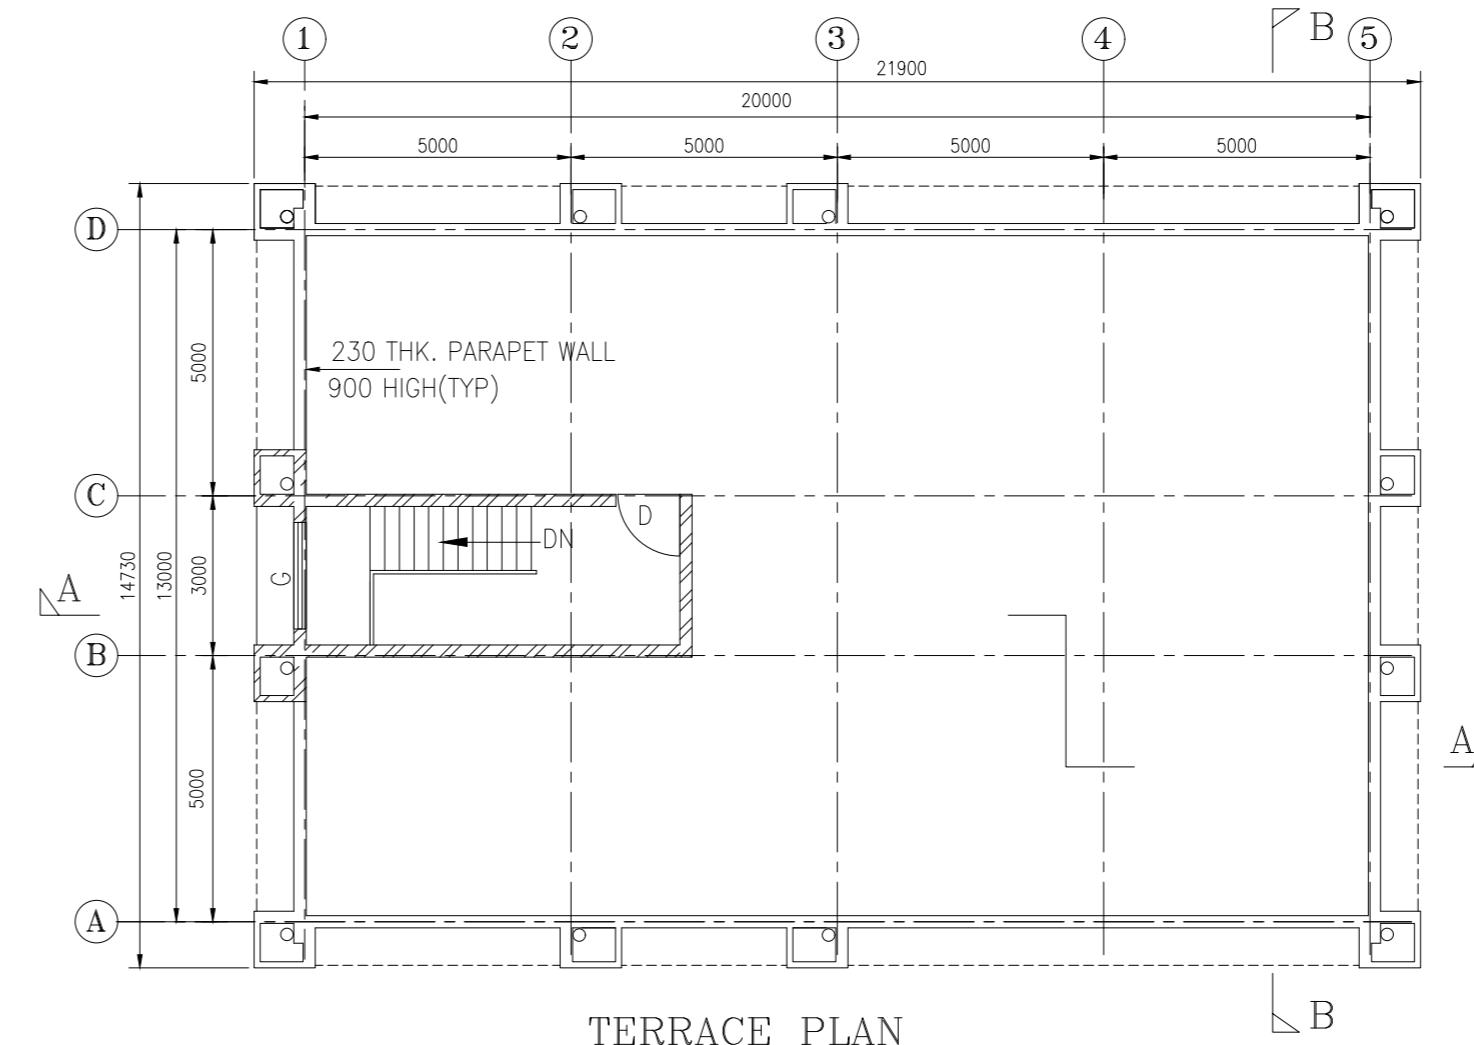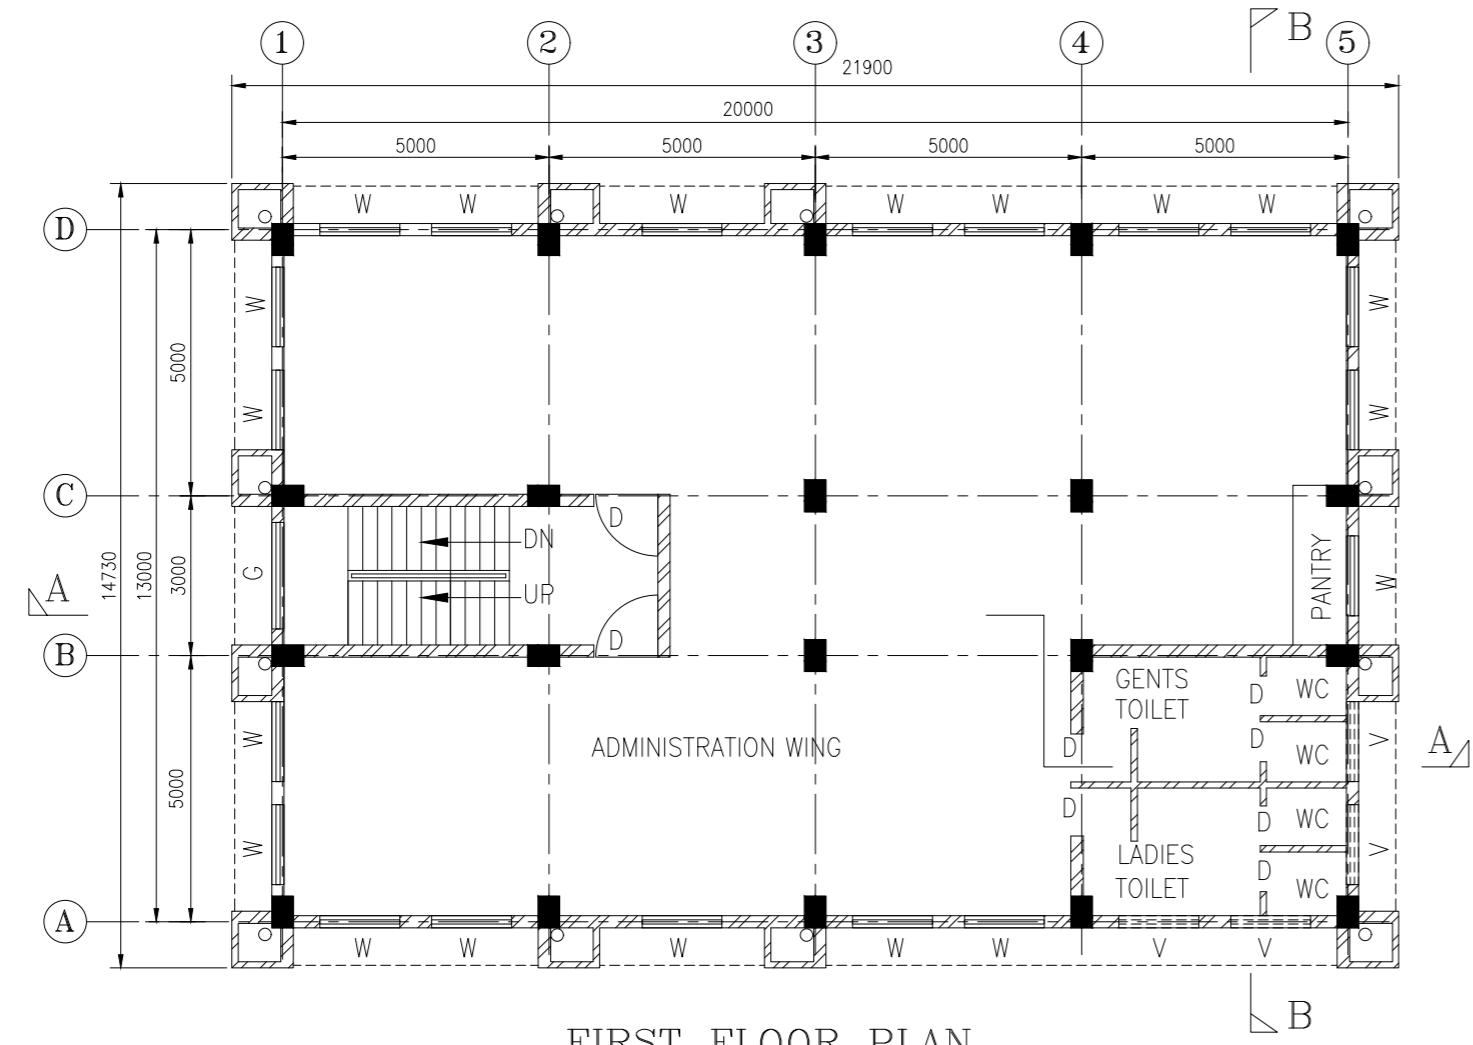

SCHEDULE		
S.NO:	TYPE	DESCRIPTION
1.	D	DOOR
2.	W	WINDOW
3.	V	VENTILATOR
4.	G	GLASS WINDOW
5.	WC	WATER CLOSET

E.G.L.—EXISTING GROUND LEVEL
F.F.L.—FINISH FLOOR LEVEL

NOTES

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INLAND WATERWAYS AUTHORITY OF INDIA

PROJECT DETAILED FEASIBILITY STUDY FOR CAPACITY AUGMENTATION OF NATIONAL WATERWAY-1 AND DETAILED ENGINEERING FOR ITS ANCILLARY WORKS AND PROCESS BETWEEN HALDIA TO ALLAHABAD (JAL VIKAS PROJECT)

CONSULTANT HOWE PMC PROJECTS (INDIA) PRIVATE LIMITED From vision to reality... DRN VAP NAME SIGN DATE 25/09/17 CHD AM 25/09/17 APD SP 25/09/17


TITLE IWT TERMINAL AT VARANASI JOB. NO. DRG. NO. I-525 VTR-211 SHEET 1 OF 2

REV	DATE	DESCRIPTION	VAP	AM	SP	DRN	CHD	APP
0	25/09/17							

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UNIT SCALE - AS SHOWN Size : A1 REV. 0




PLAN
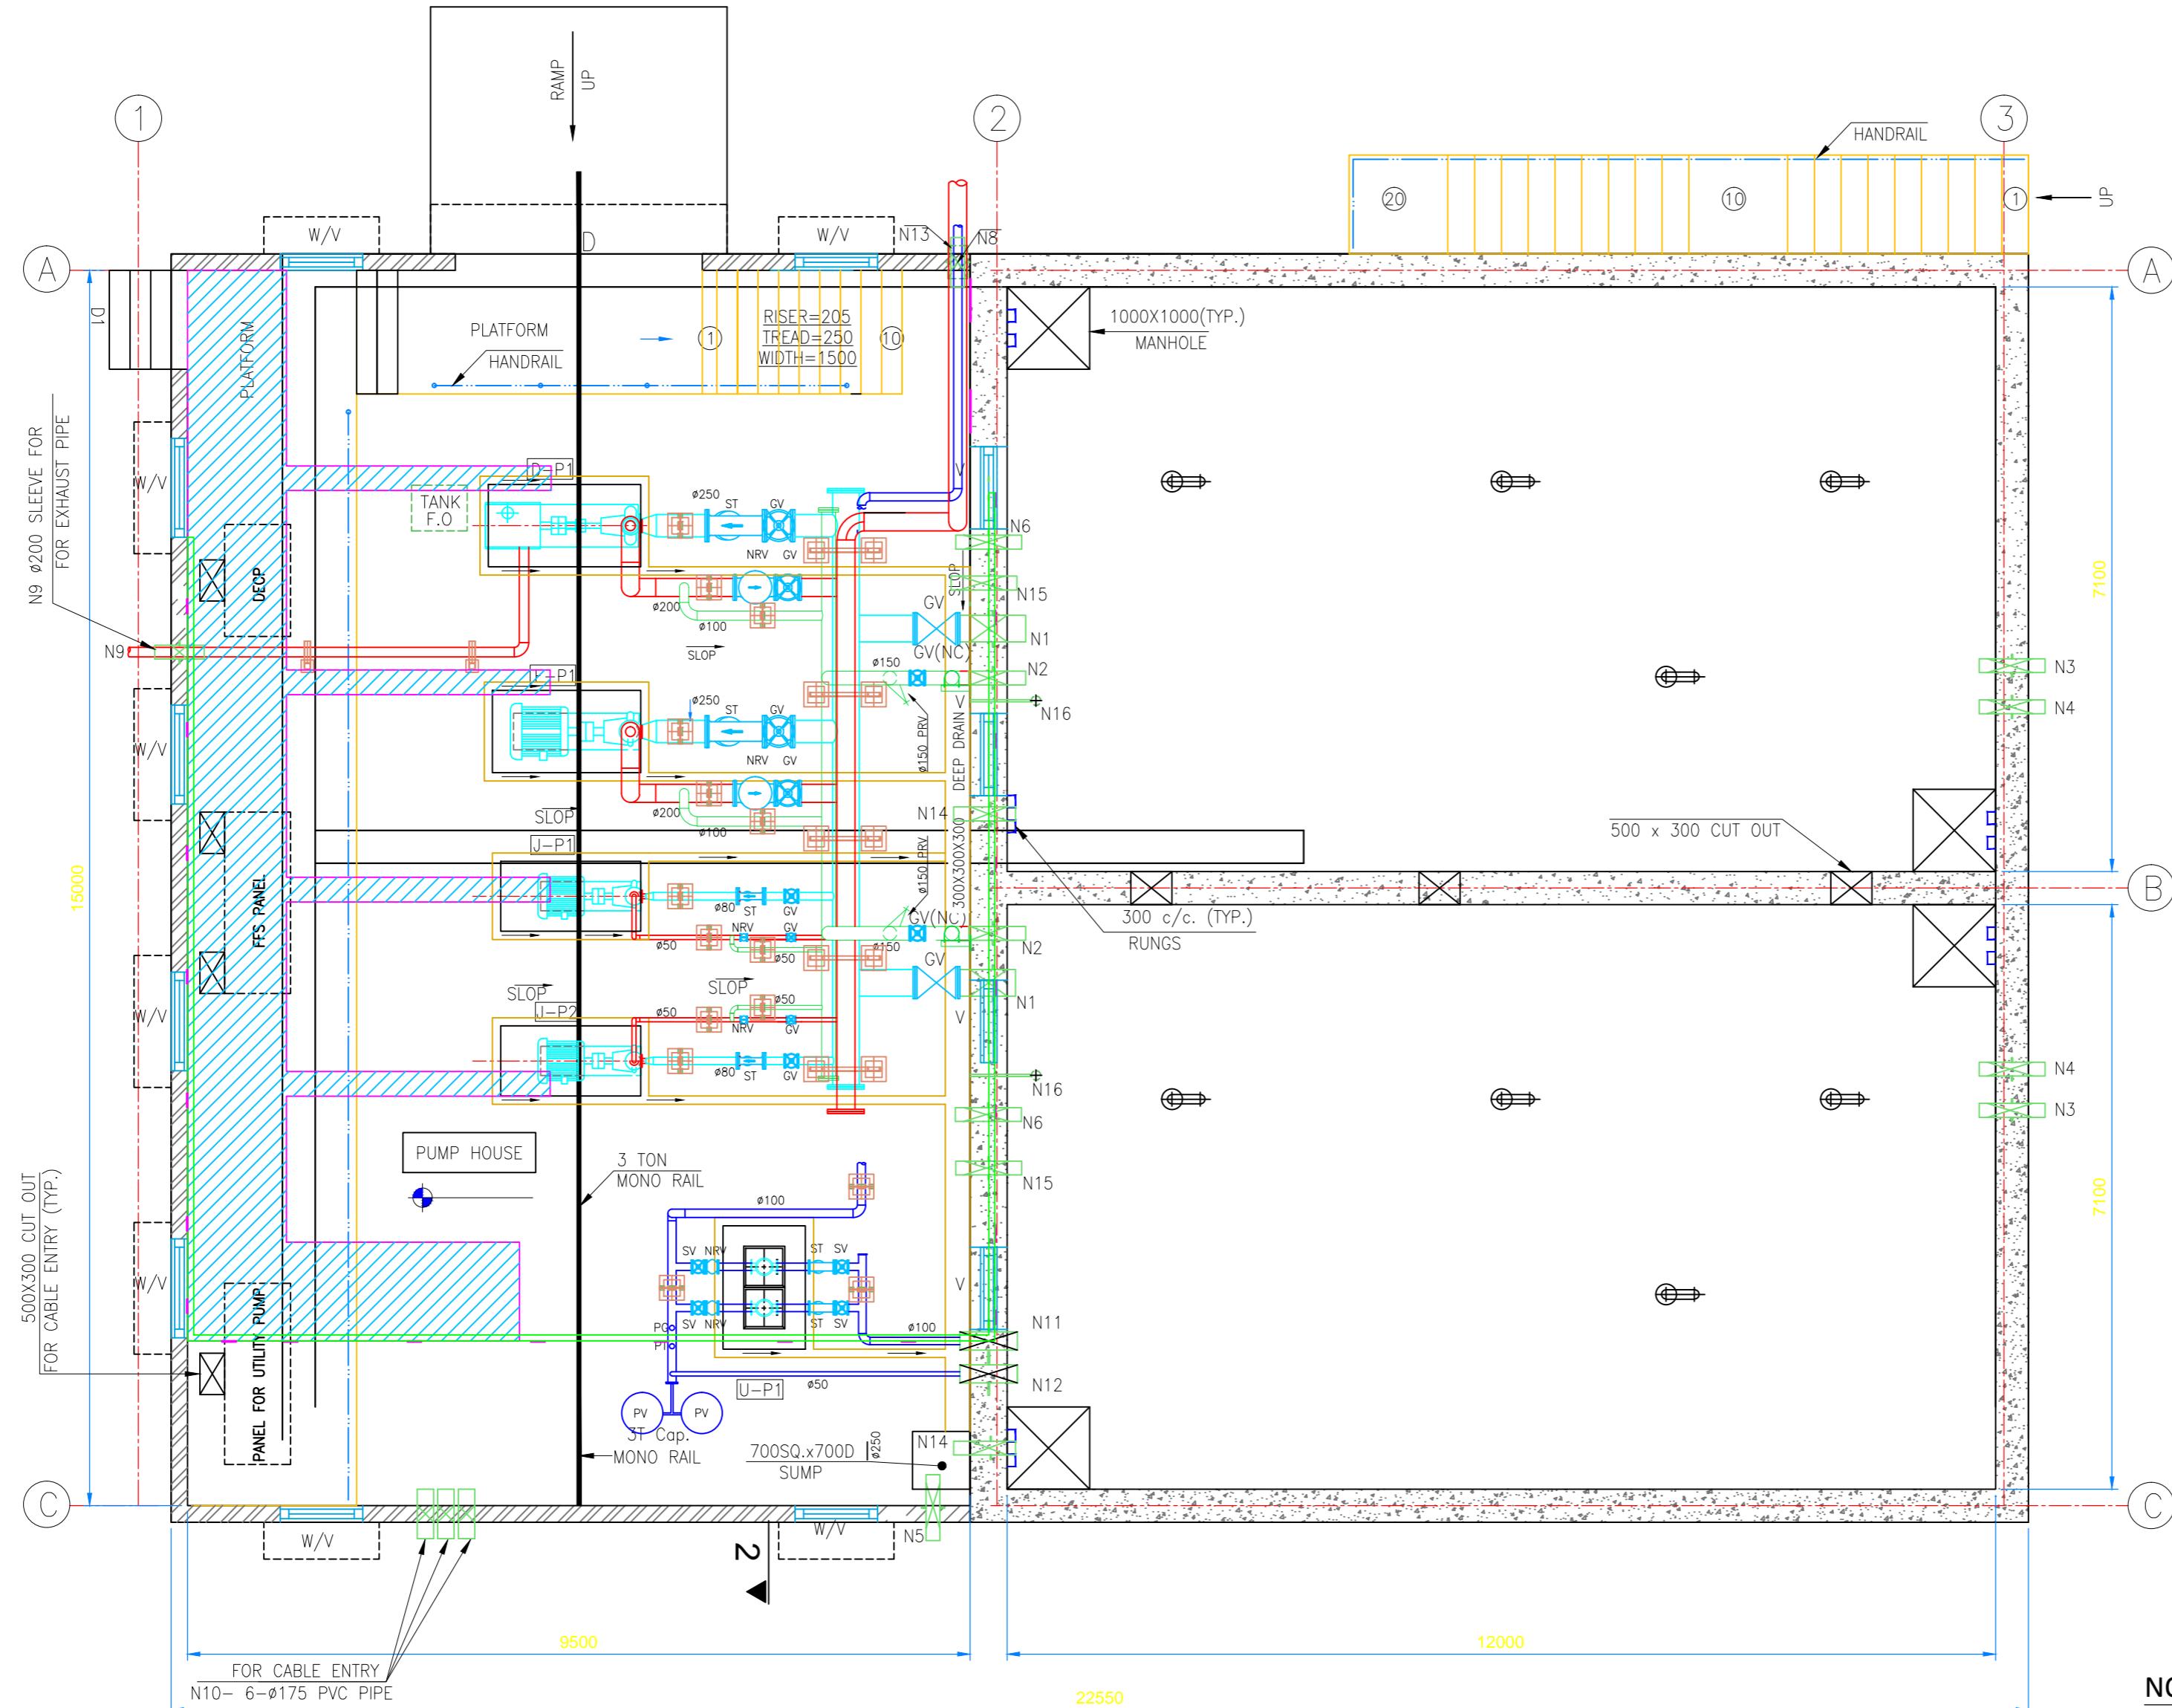
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	INLAND WATERWAYS AUTHORITY OF INDIA		
PROJECT	DETAILED FEASIBILITY STUDY FOR CAPACITY AUGMENTATION OF NATIONAL WATERWAY-1 AND DETAILED ENGINEERING FOR ITS ANCILLARY WORKS AND PROCESS BETWEEN HALDIA TO ALLAHABAD (JAL VIKAS PROJECT)		
CONSULTANT	PMC PROJECTS INDIA PRIVATE LIMITED from vision to reality...		
REV. NO.	DATE	VAP	AM
0	25/09/17		
DRN	CHD	APD	
			25/09/17
		AM	25/09/17
		SP	25/09/17
IT - IWT TERMINAL AT VARANASI LAYOUT OF FIRE FIGHTING PUMP HOUSE (FINAL PHASE)			
JOB. NO. DR. NO.			
I-525 VTR-212			
COORDINATE SYSTEM : JSCD: ENTER CO-ORD SYSTEM HERE			
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UNIT SCALE - AS SHOWN Size : A1 P.P.V. : 0			







PLAN
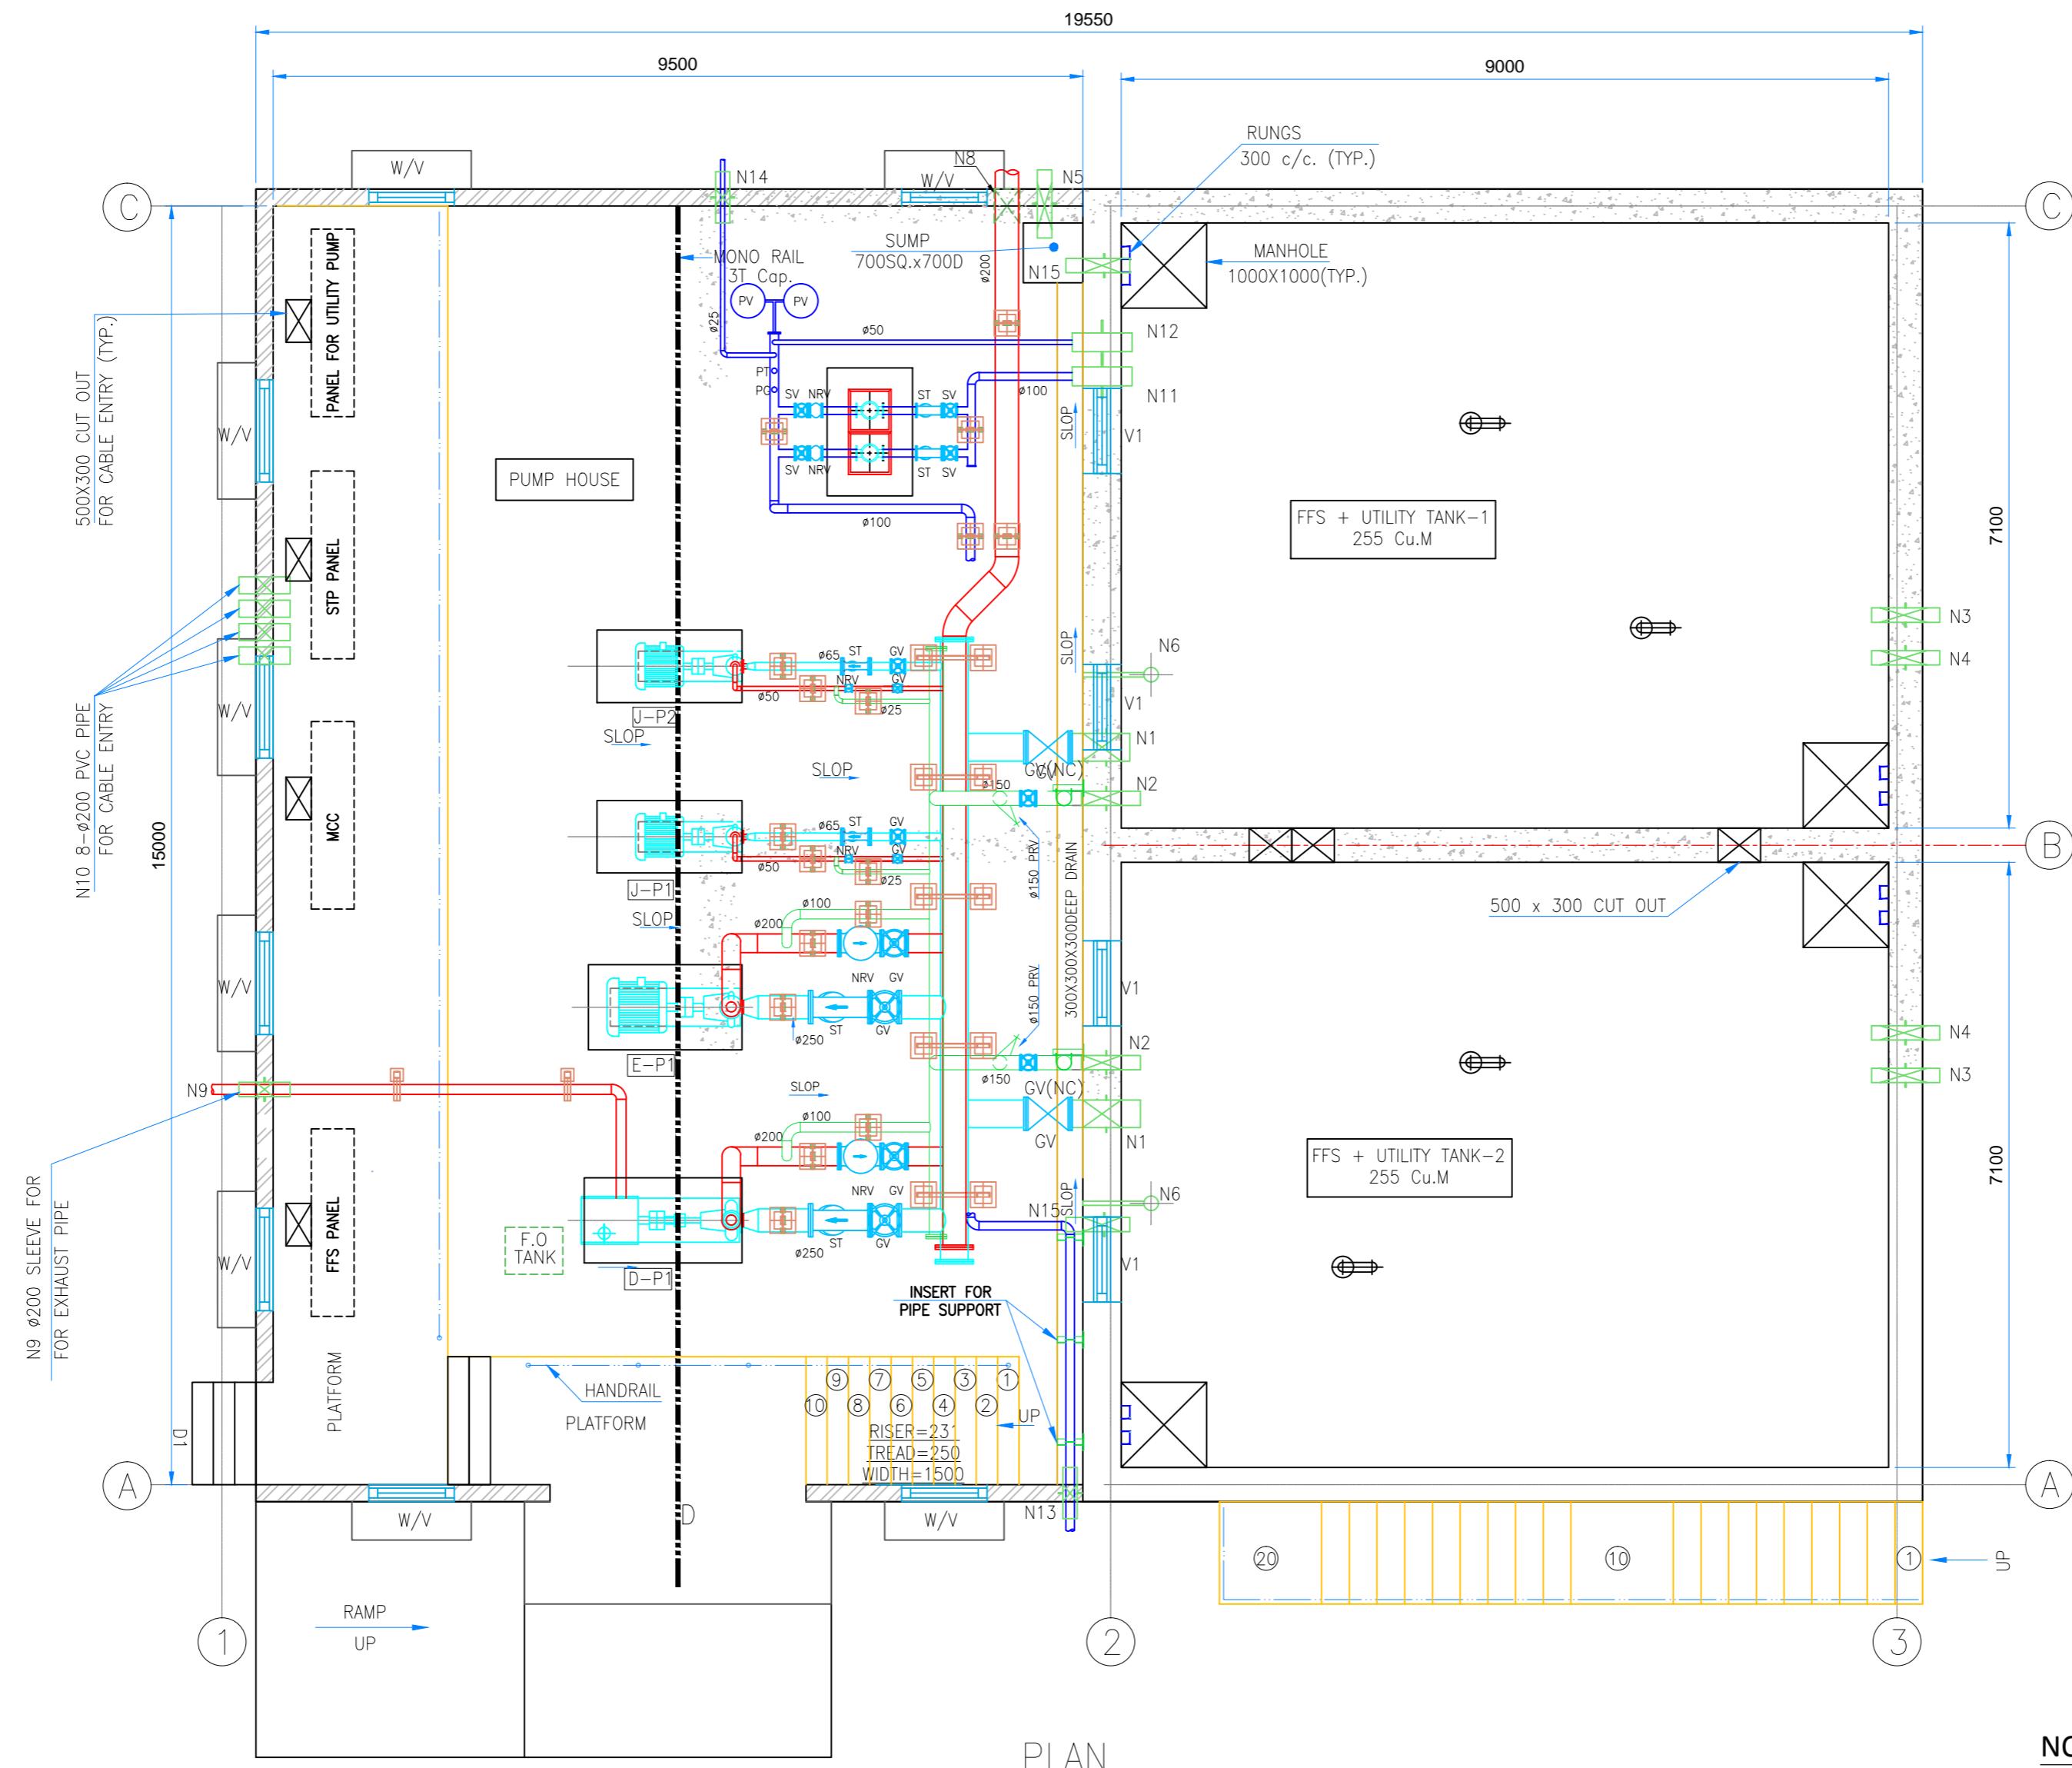
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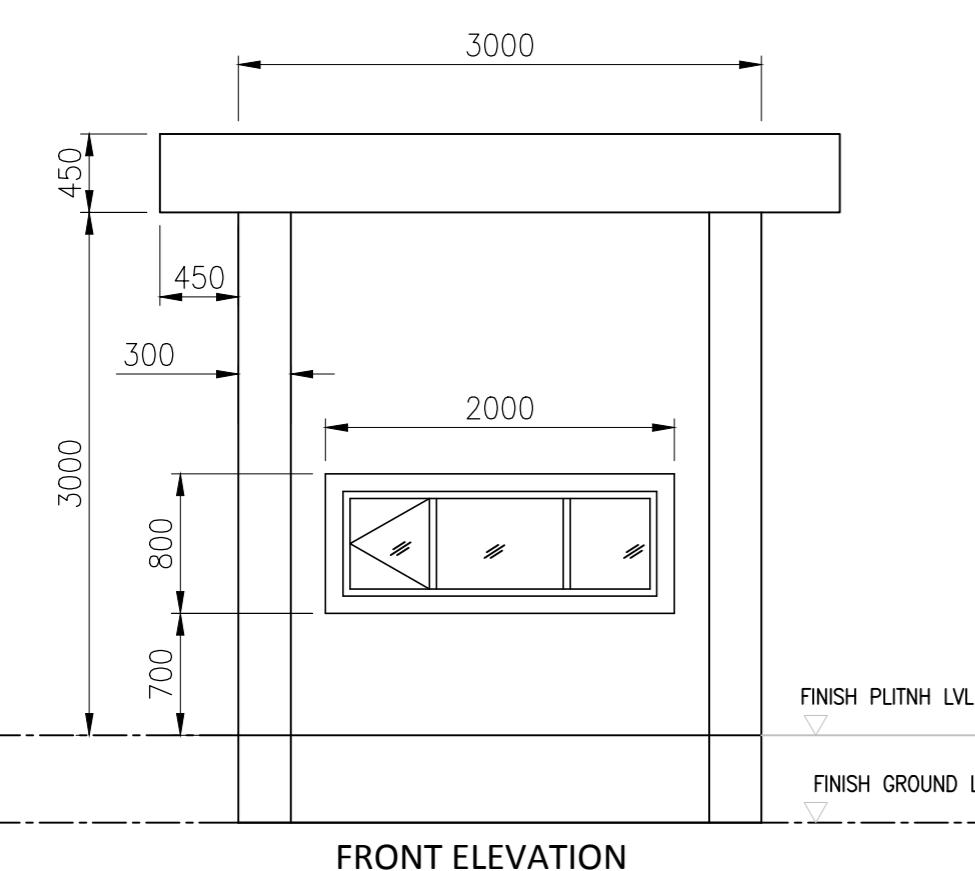
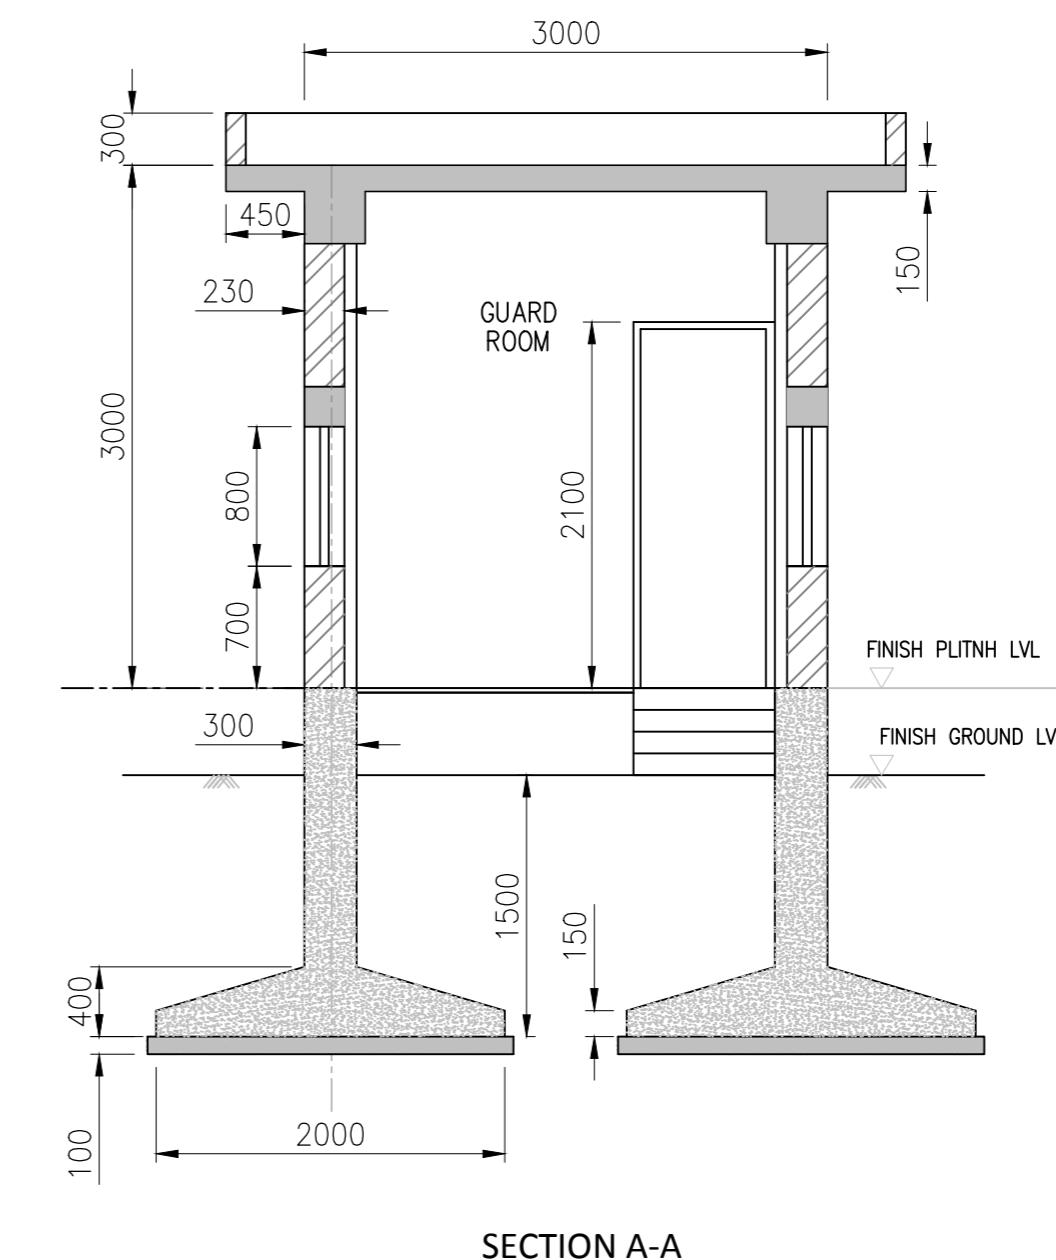
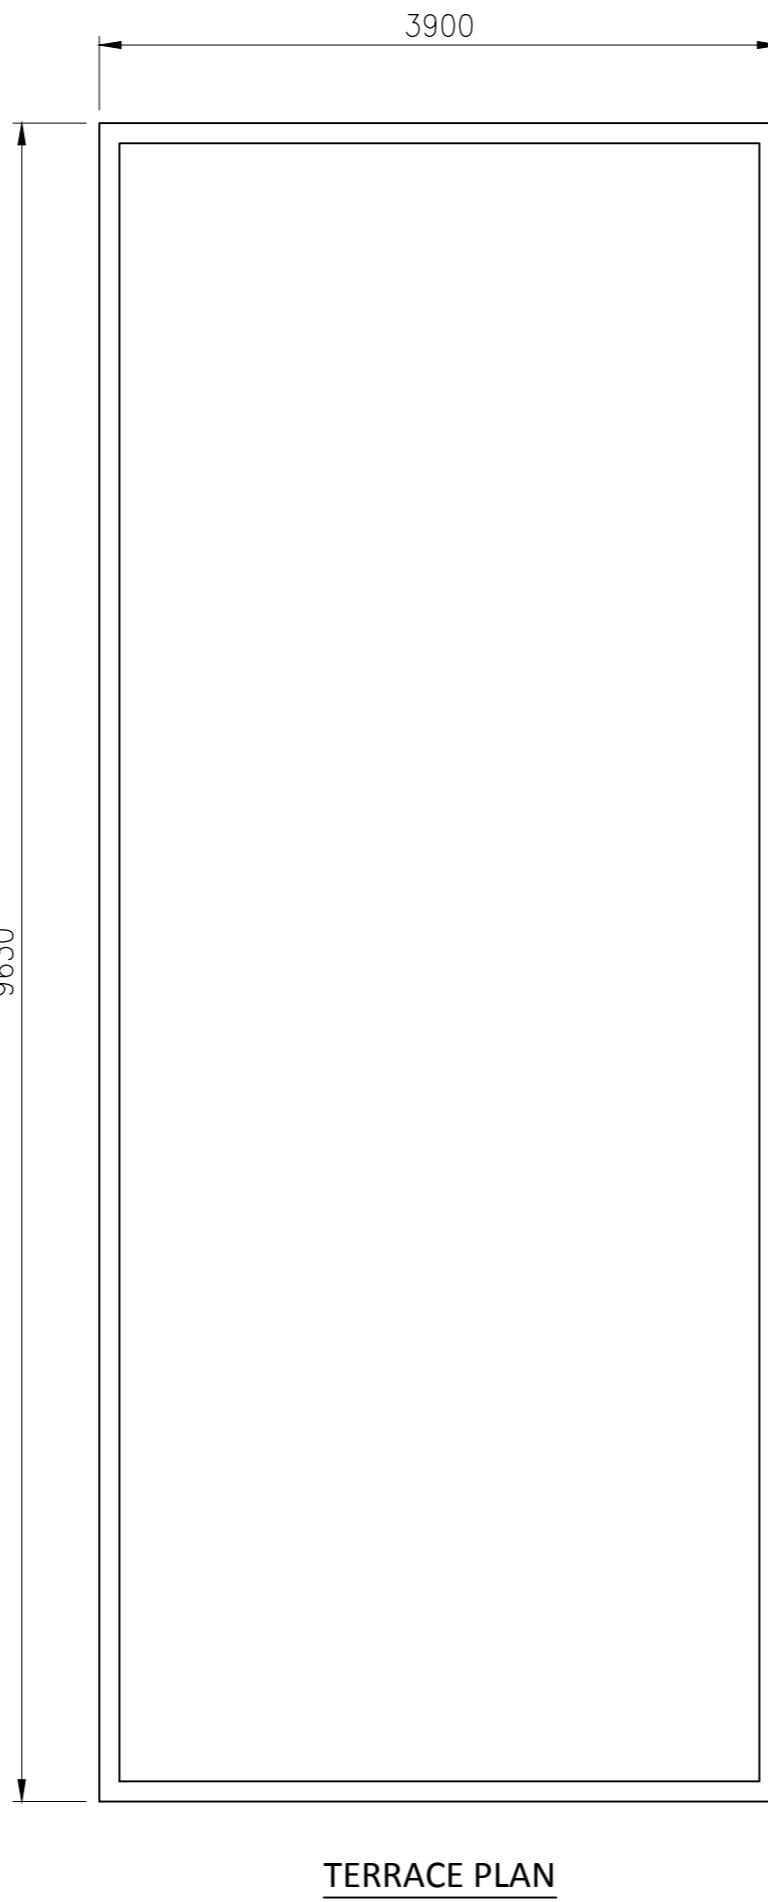
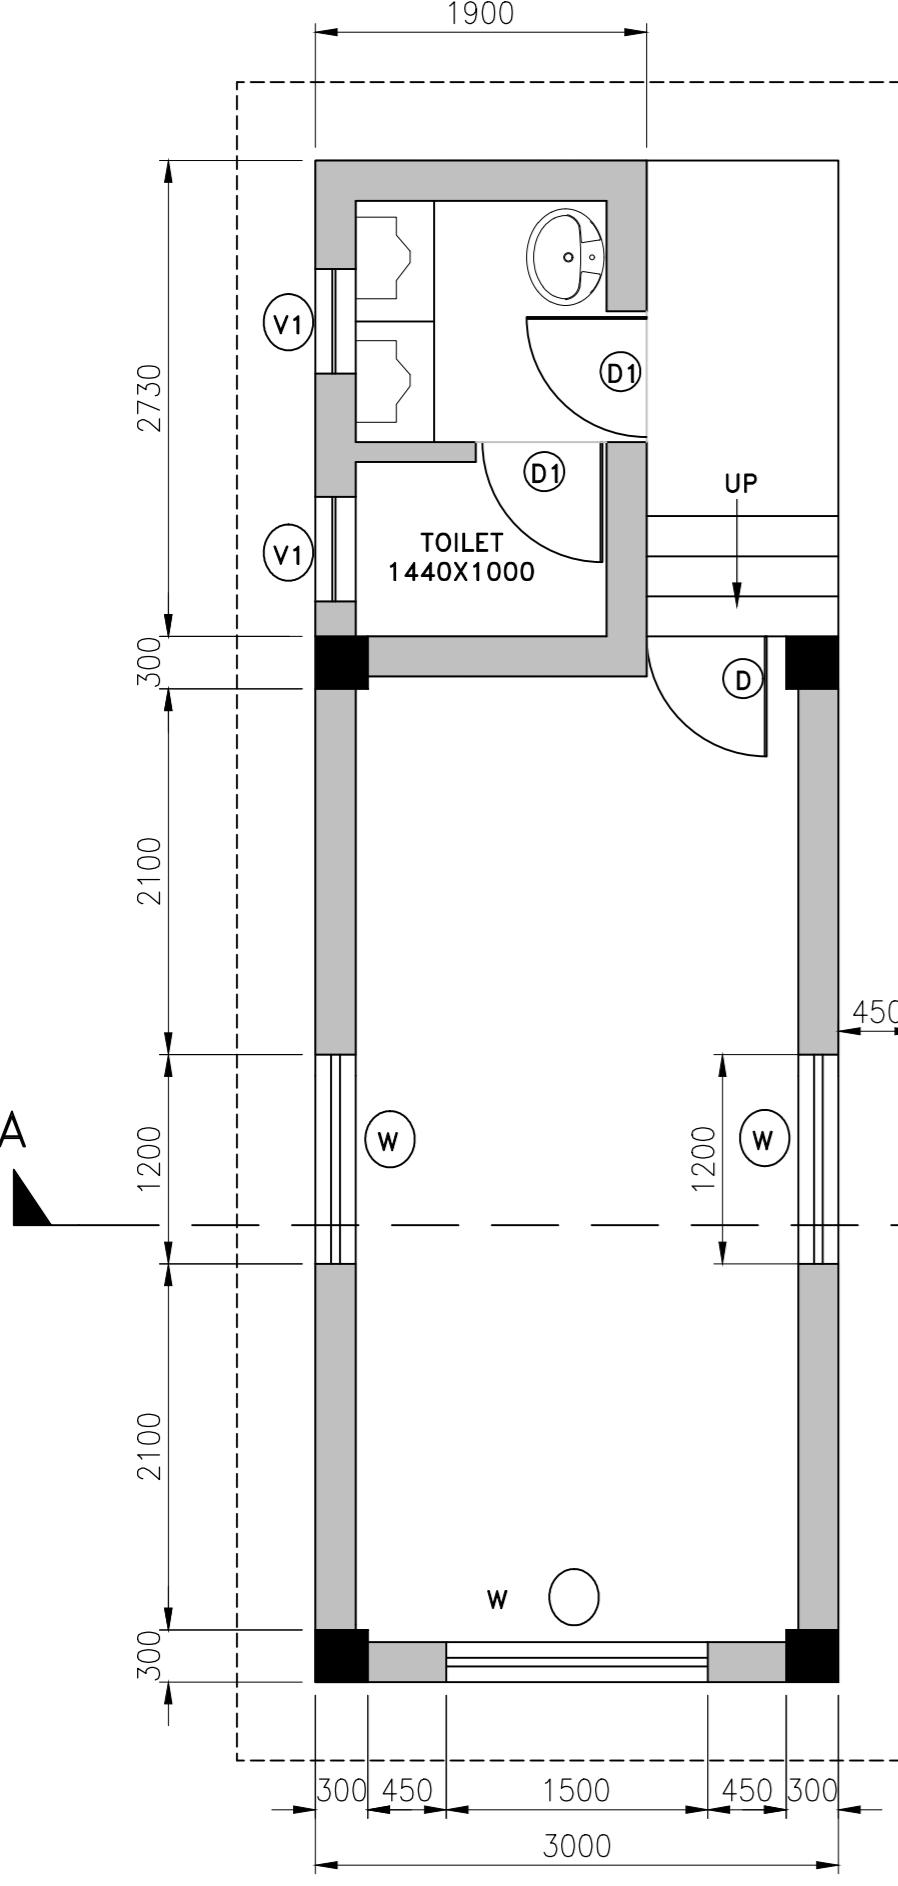
		INLAND WATERWAYS AUTHORITY OF INDIA		
PROJECT DETAILED FEASIBILITY STUDY FOR CAPACITY AUGMENTATION OF NATIONAL WATERWAY-1 AND DETAILED ENGINEERING FOR ITS ANCILLARY WORKS AND PROCESS BETWEEN HALDIA TO ALLAHABAD (JAL VIKAS PROJECT)				
CONSULTANT HOWE		PMC PROJECTS INDIA PRIVATE LIMITED from vision to reality...	REV. NO.	DATE
0	29/09/17	VAP	AM	SP
DRN	CHD	APD		
IT - IWT TERMINAL AT VARANASI LAYOUT OF FIRE FIGHTING PUMP HOUSE (PHASE-1B)				
JOB. NO. DR. NO. I-525 VTR- 212A				
COORDINATE SYSTEM JSCD: ENTER CO-ORD SYSTEM HERE				
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Scale : A1 Page No. 0				



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PROJECT		DETAILED FEASIBILITY STUDY FOR CAPACITY AUGMENTATION OF NATIONAL WATERWAY-1 AND DETAILED ENGINEERING FOR ITS ANCILLARY WORKS AND PROCESS BETWEEN HALDIA TO ALLAHABAD (JAL VIKAS PROJECT)													
CONSULTANT	PMC PROJECTS INDIA PRIVATE LIMITED from vision to reality...	NAME		SIGN		DATE									
		DRN	VAP	CHD	AM	APD	SP	25/09/17							
TITLE		IWT TERMINAL AT VARANASI GENERAL ARRANGEMENT OF GATE COMPLEX													
REV. DATE		DESCRIPTION		DRN	CHD	APP	I-525								
COORDINATE SYSTEM USED: ENTER CO-ORD SYSTEM HERE															
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SCHEDULE		
S.NO:	TYPE	DESCRIPTION
1.	D	DOOR
2.	W	WINDOW

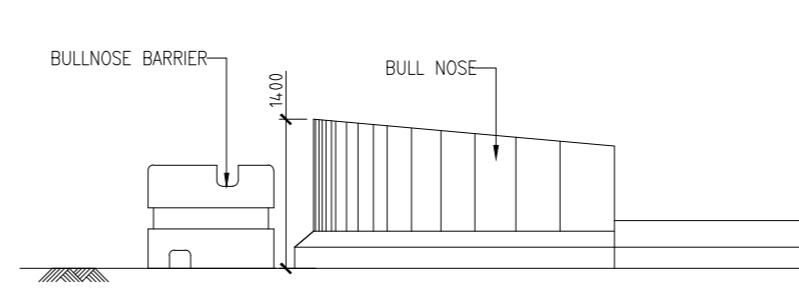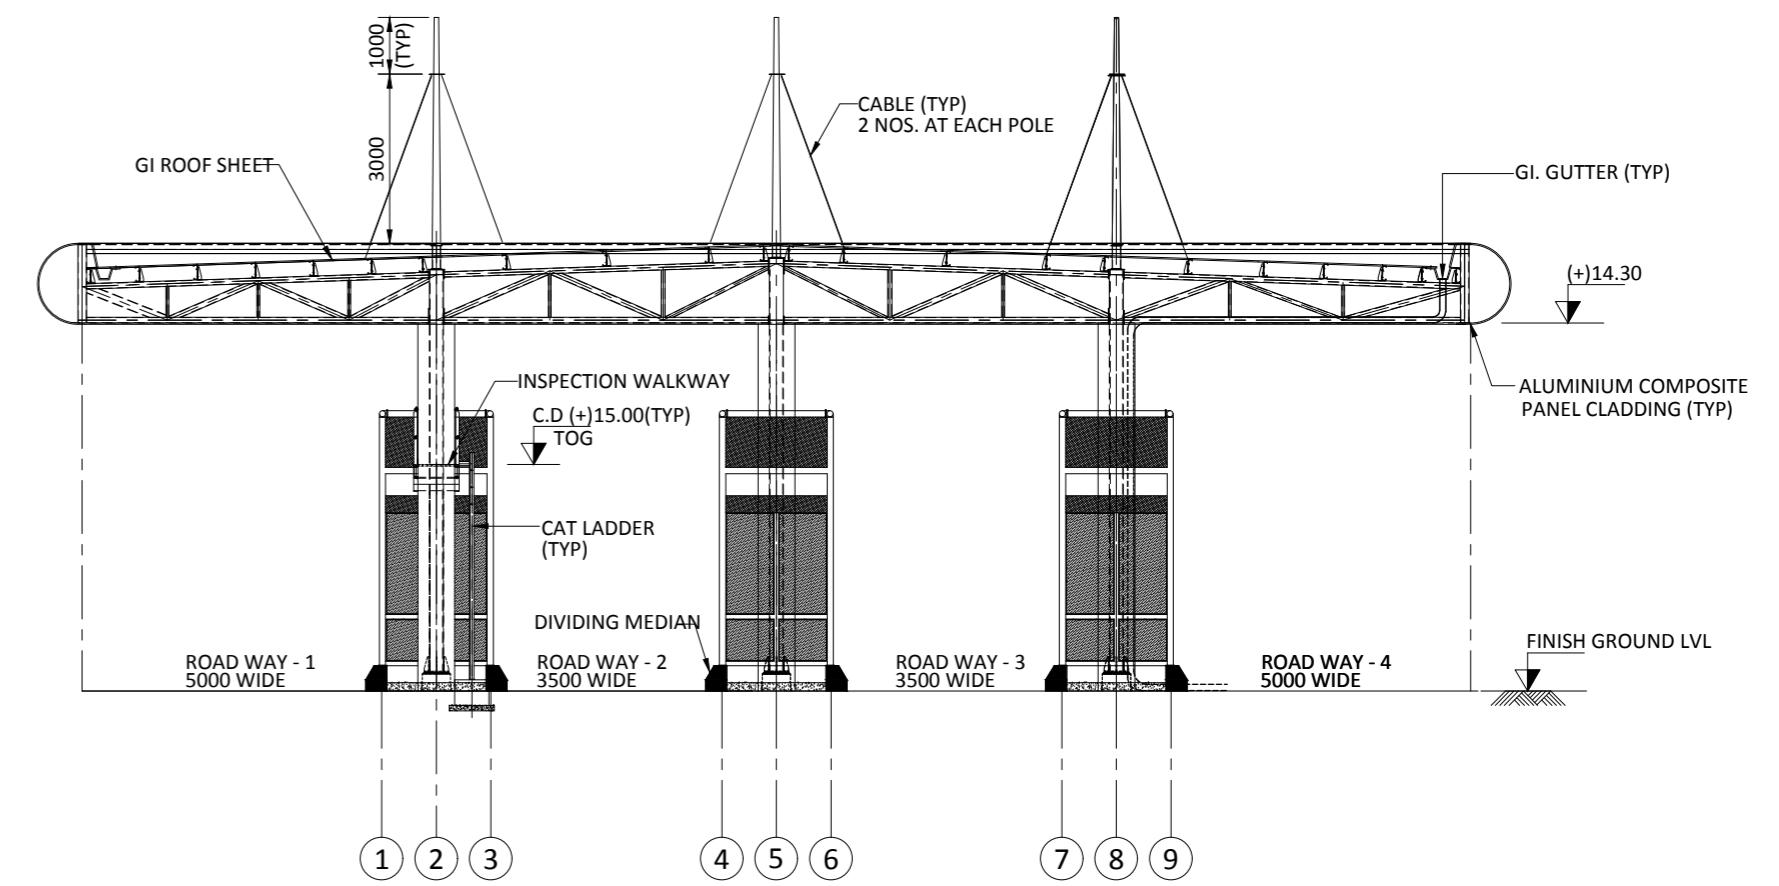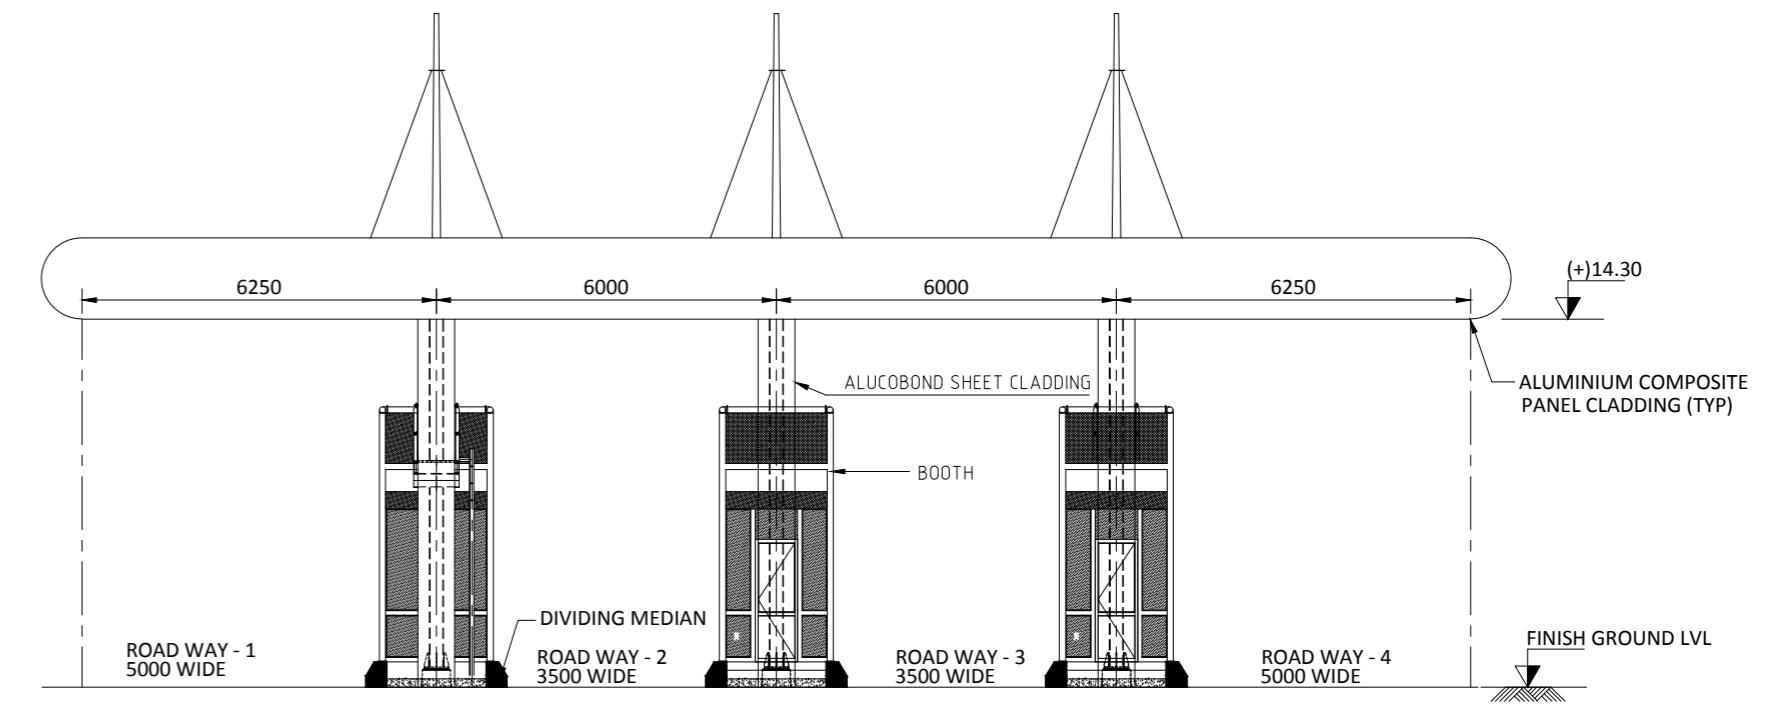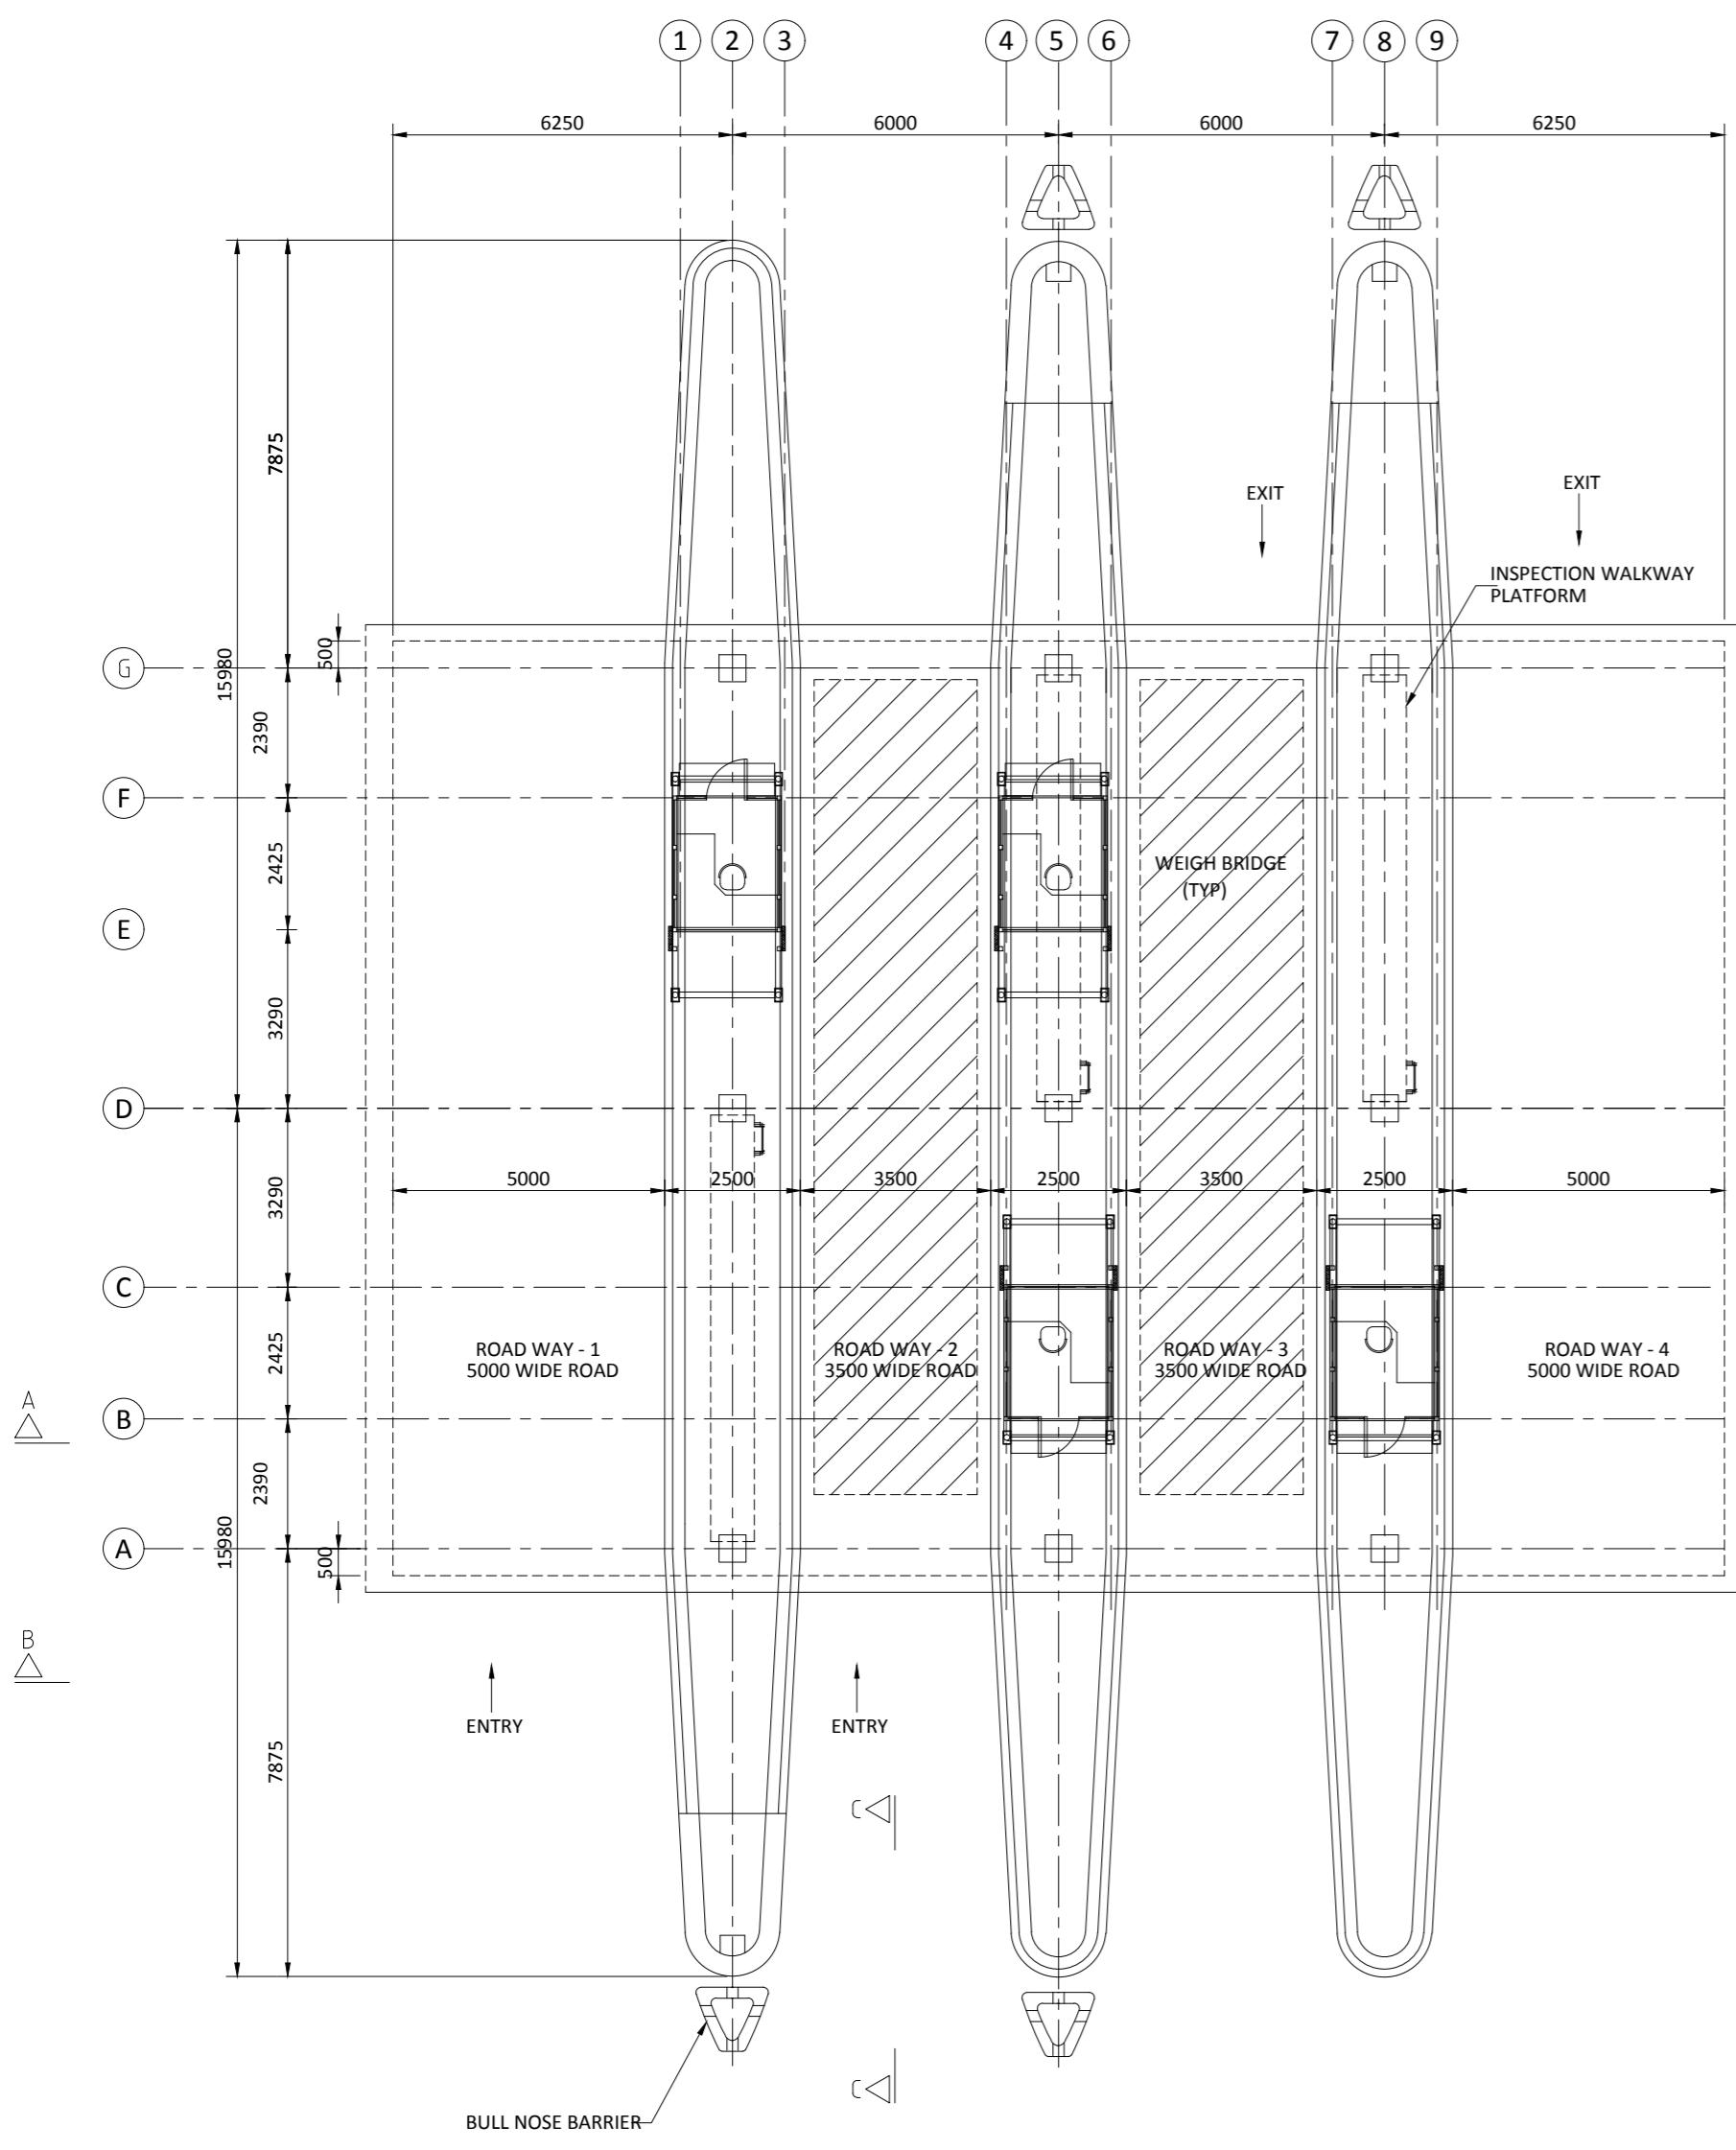E.G.L.-EXISTING GROUND LEVEL
F.F.L.-FINISH FLOOR LEVEL

NOTES

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PROJECT DETAILED FEASIBILITY STUDY FOR CAPACITY AUGMENTATION OF NATIONAL WATERWAY-1 AND DETAILED ENGINEERING FOR ITS ANCILLARY WORKS AND PROCESS BETWEEN HALDIA TO ALLAHABAD (JAL VIKAS PROJECT)






CONSULTANT
HOWE **PMC PROJECTS**
from vision to reality...
DRN VAP NAME SIGN DATE
CHD AM 25/09/17
APD SP 25/09/17

TITLE IWT TERMINAL AT VARANASI
SECURITY OFFICE JOB. NO. DRG. NO.
I-525 VTR-214

REV	DATE	DESCRIPTION	VAP	AM	SP	DRN	CHD	APD
0	25/09/17							

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 UNIT SCALE - AS SHOWN Size : A1 REV. 0

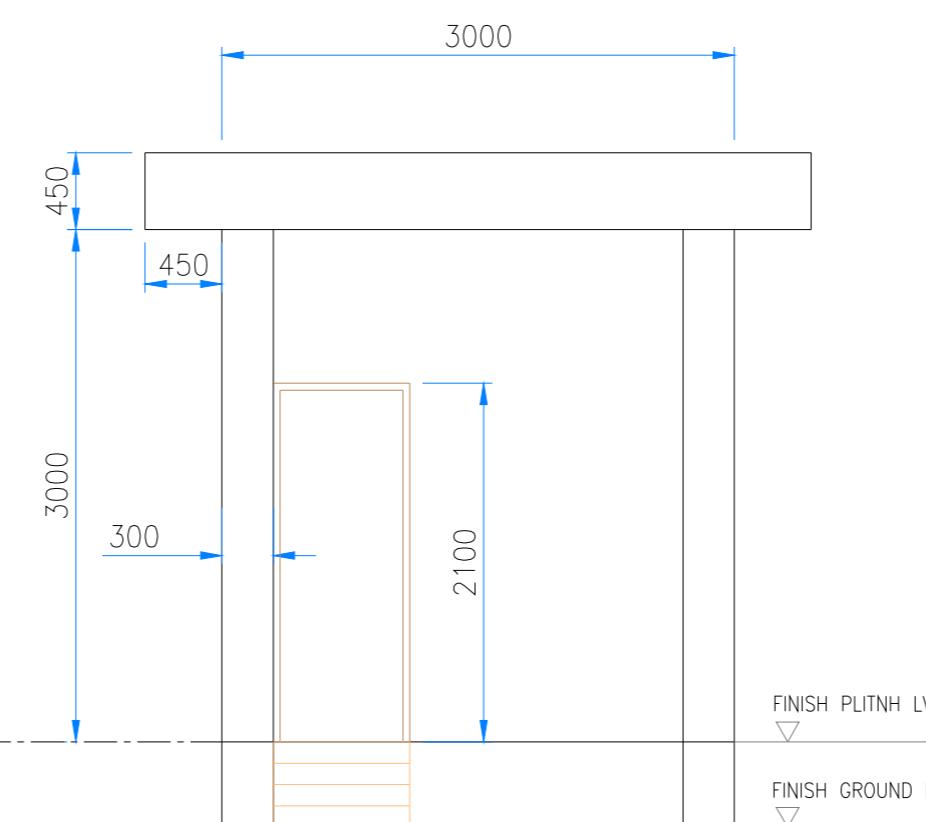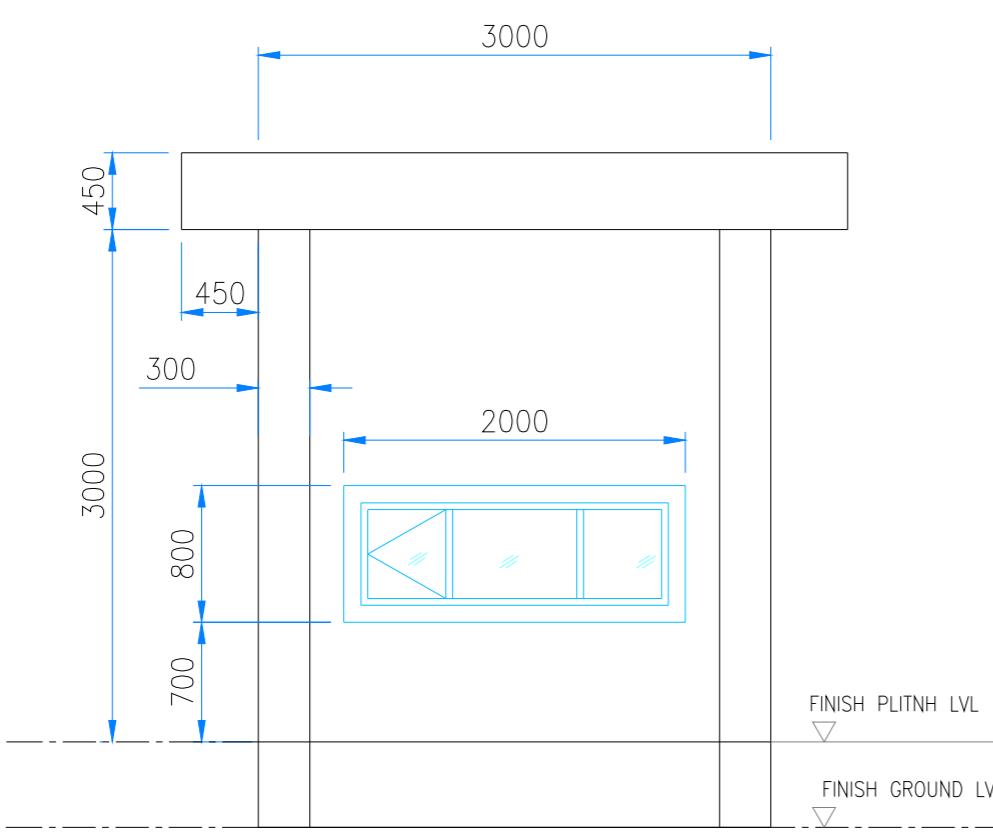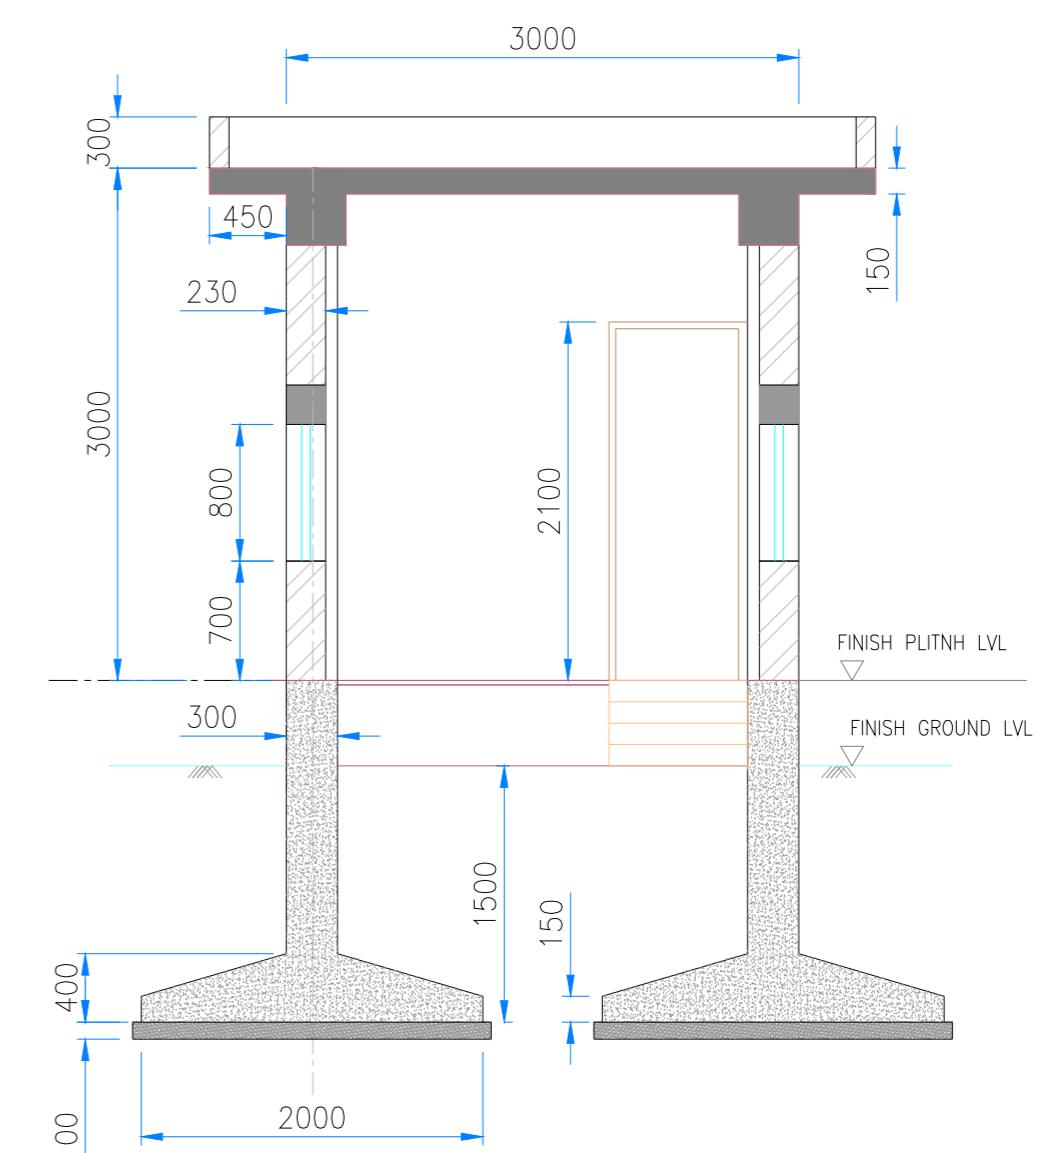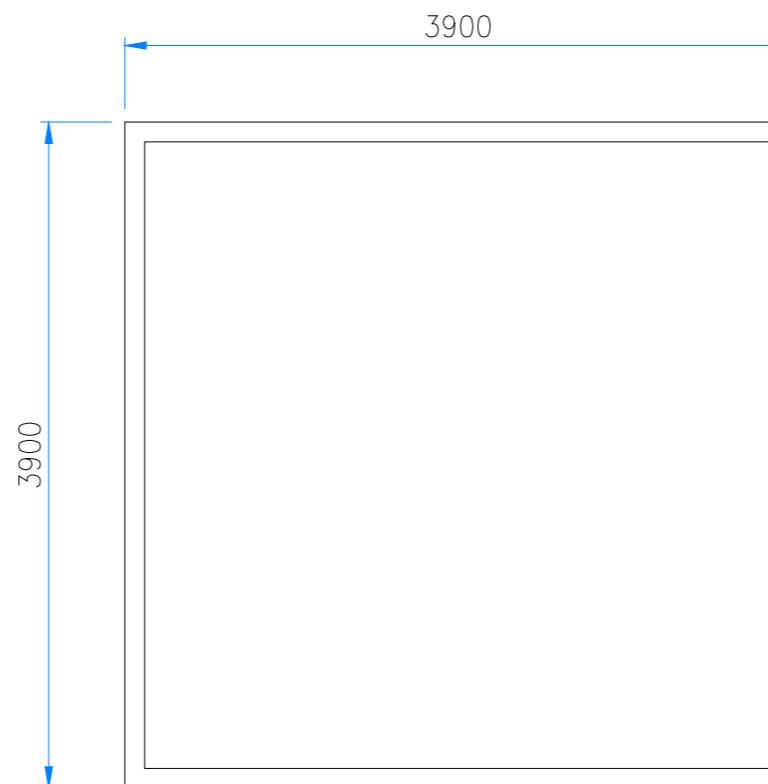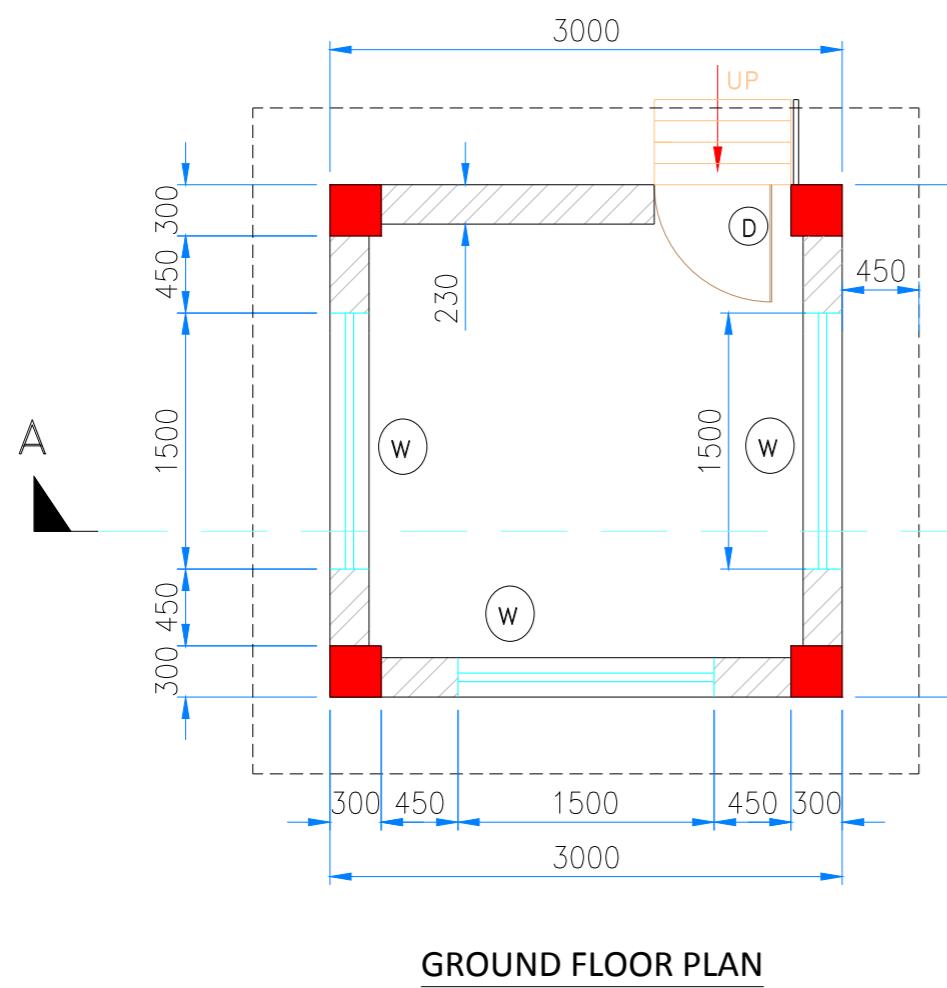

SCHEDULE		
S.NO:	TYPE	DESCRIPTION
1.	D	DOOR
2.	W	WINDOW

E.G.L.—EXISTING GROUND LEVEL
F.F.L.—FINISH FLOOR LEVEL


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INLAND WATERWAYS AUTHORITY OF INDIA		
PROJECT	DETAILED FEASIBILITY STUDY FOR CAPACITY AUGMENTATION OF NATIONAL WATERWAY-1 AND DETAILED ENGINEERING FOR ITS ANCILLARY WORKS AND PROCESS BETWEEN HALDIA TO ALLAHABAD (JAL VIKAS PROJECT)	
CONSULTANT	PMC PROJECTS (INDIA) PRIVATE LIMITED HOWE	NAME SIGN DATE DRN VAP 25/09/17 CHD AM 25/09/17 APD SP 25/09/17
TITLE	IWT TERMINAL AT VARANASI WEIGH BRIDGE CONTROL ROOM	
JOB. NO. DRG. NO. I-525 VTR-215		
COORDINATE SYSTEM USED: ENTER CO-ORD SYSTEM HERE		
 UNIT SCALE - AS SHOWN Size : A1 REV. 0		

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PLAN

NOTE



1. ALL DIMENSIONS ARE IN MM

0	25/09/17	
REV	DATE	DESCRIP
THIS DESIGN OR DRAWING IS THE PROPERTY OF		
 HOWE		
 PMC PROJECTS <small>INDIA PRIVATE LIMITED</small> <small>from vision to reality...</small>		
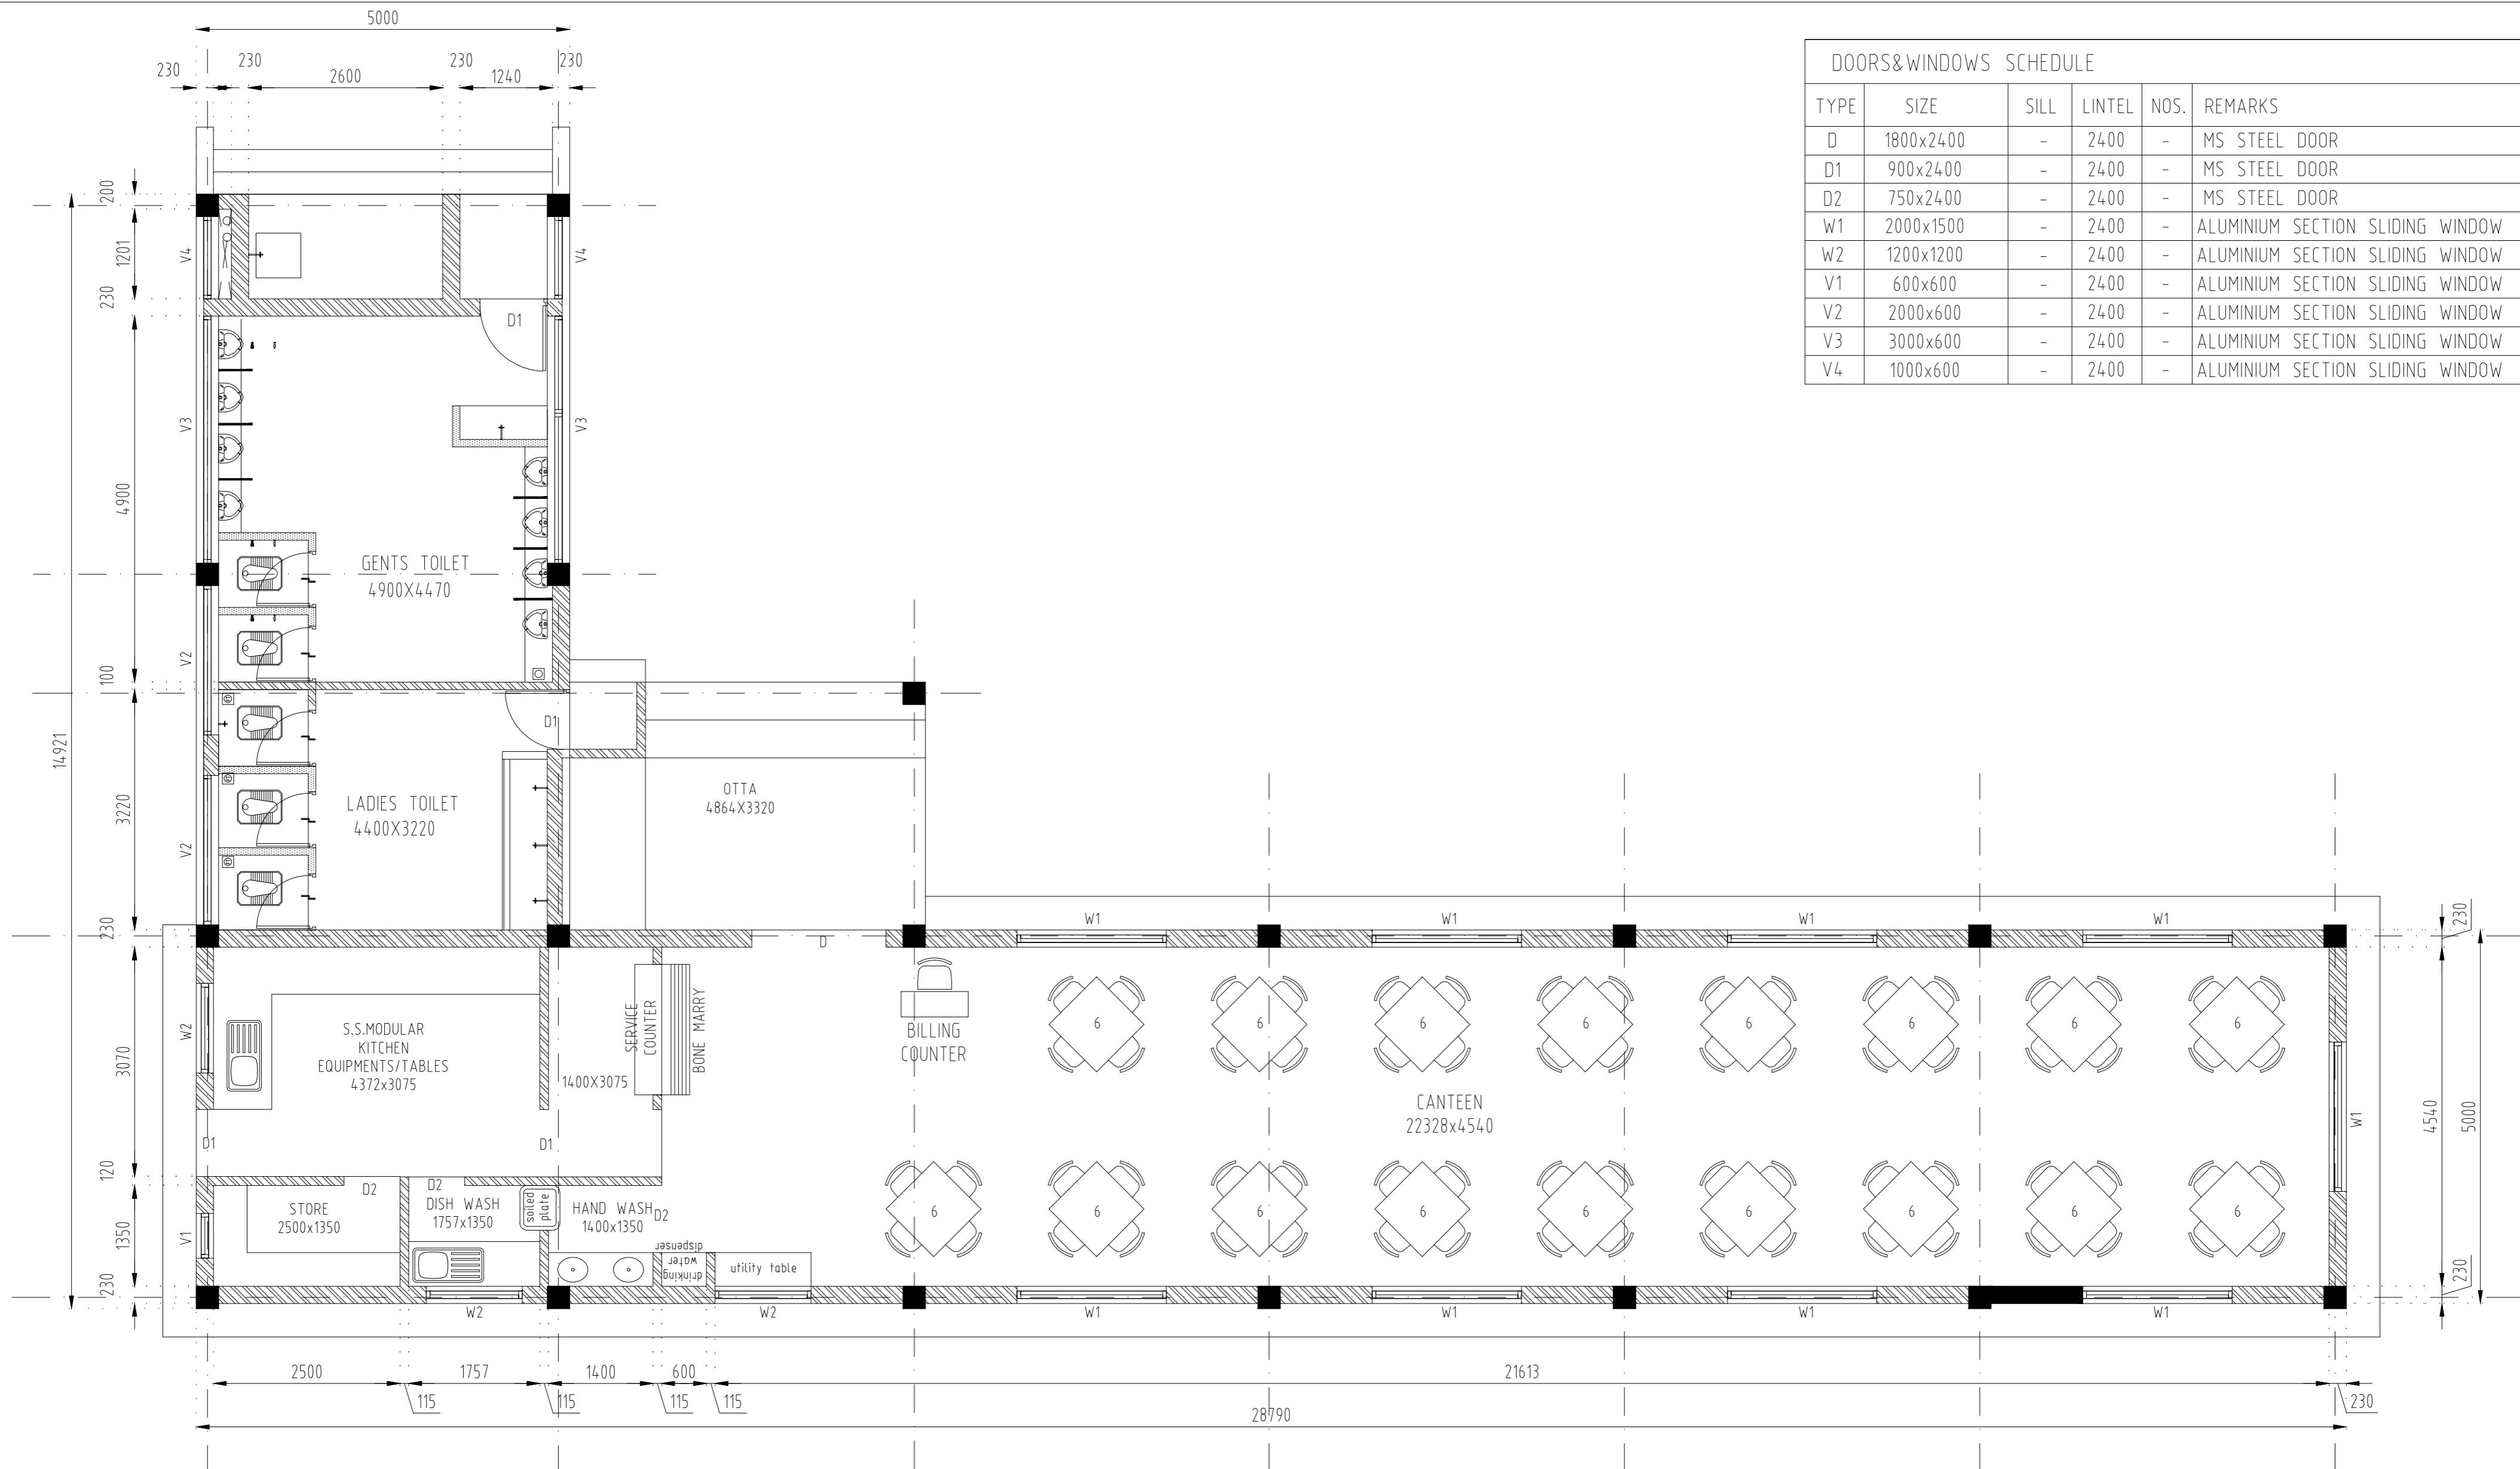
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MUST NOT BE LENT COPIED OR
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PERMISSION.

					PMC PROJECTS (INDIA)PRIVATE LIMITED from vision to reality....	DRN	VAP		25/09/17
						CHD	AM		25/09/17
						APD	SP		25/09/17
TITLE IWT TERMINAL AT VARANASI LAYOUT OF CANTEEN WITH TOILET				JOB. NO.		DRG. NO.			
				I-525		VTR-216			
COORDINATE SYSTEM USED: ENTER CO-ORD SYSTEM HERE									
		UNIT	SCALE - AS SHOWN		Size : A1		REV. 0		
TO THEIR RECALL AND LENT COPIED OR WITHOUT THEIR WRITTEN									


COORDINATE SYSTEM USED:
ENTER CO-ORD SYSTEM HERE

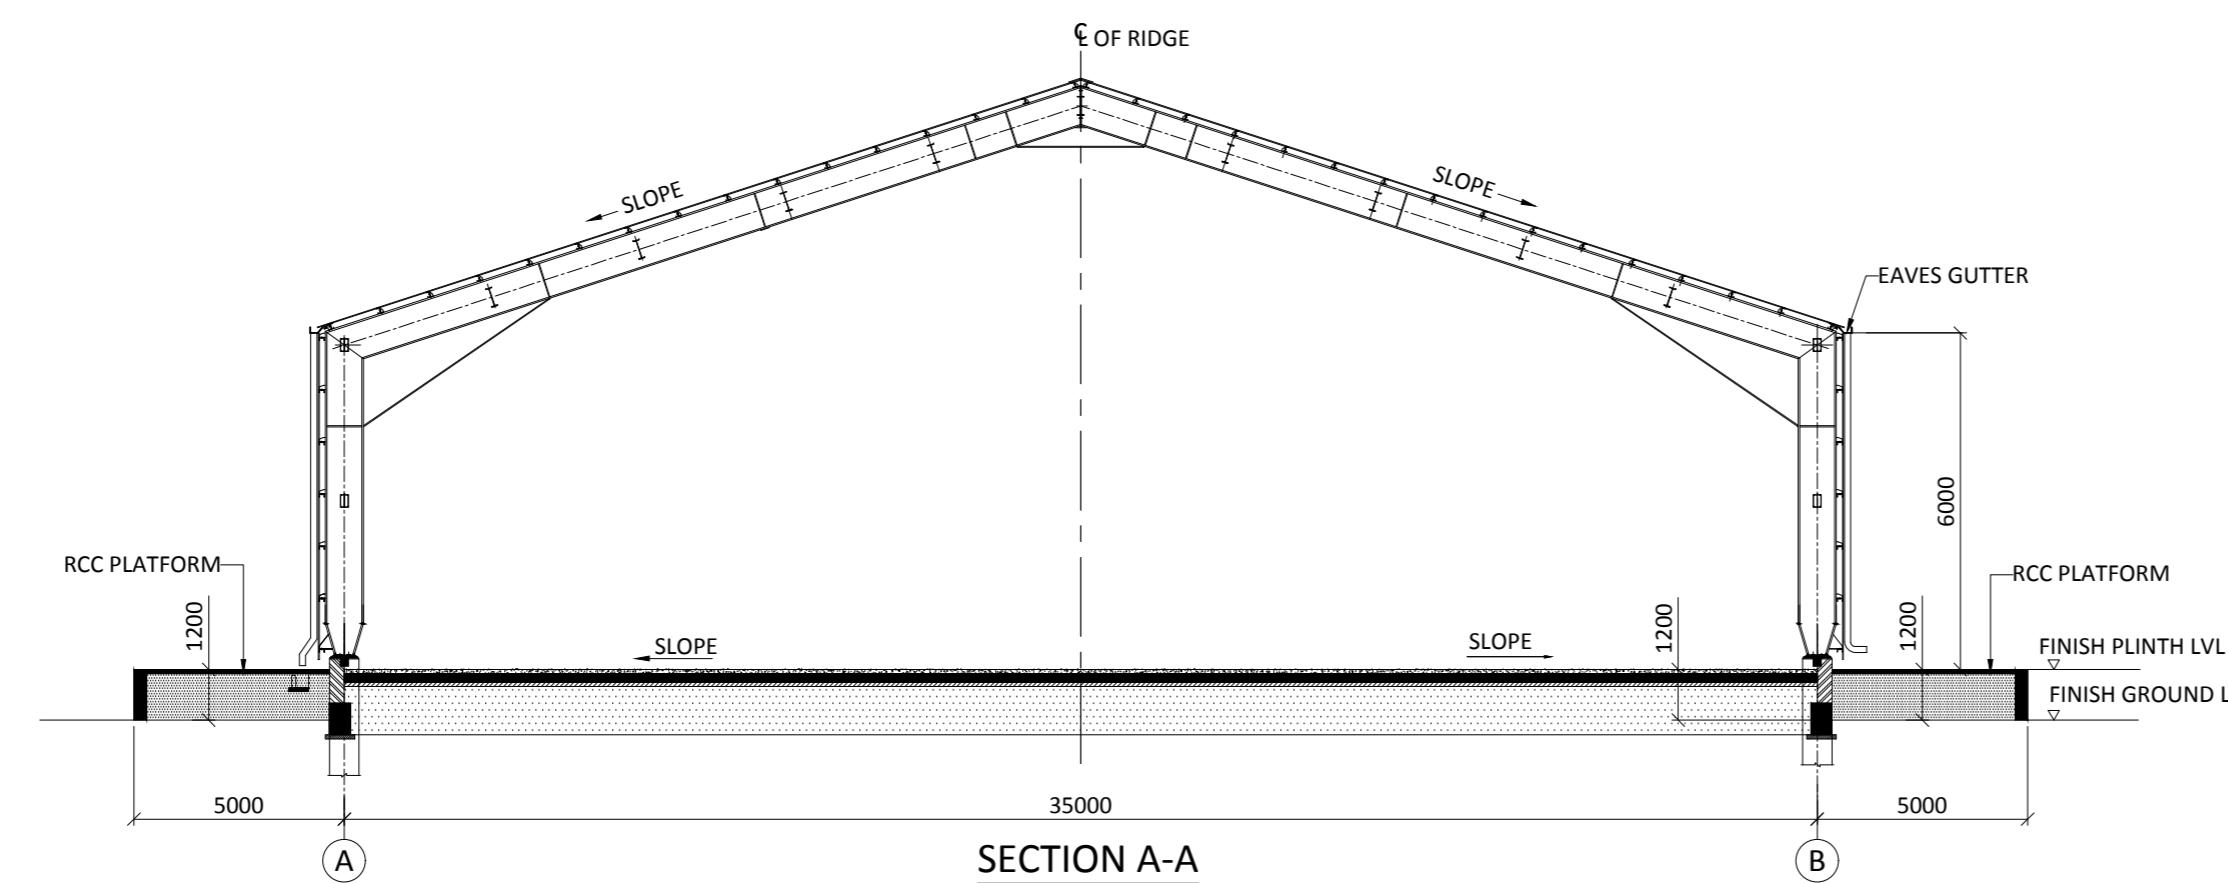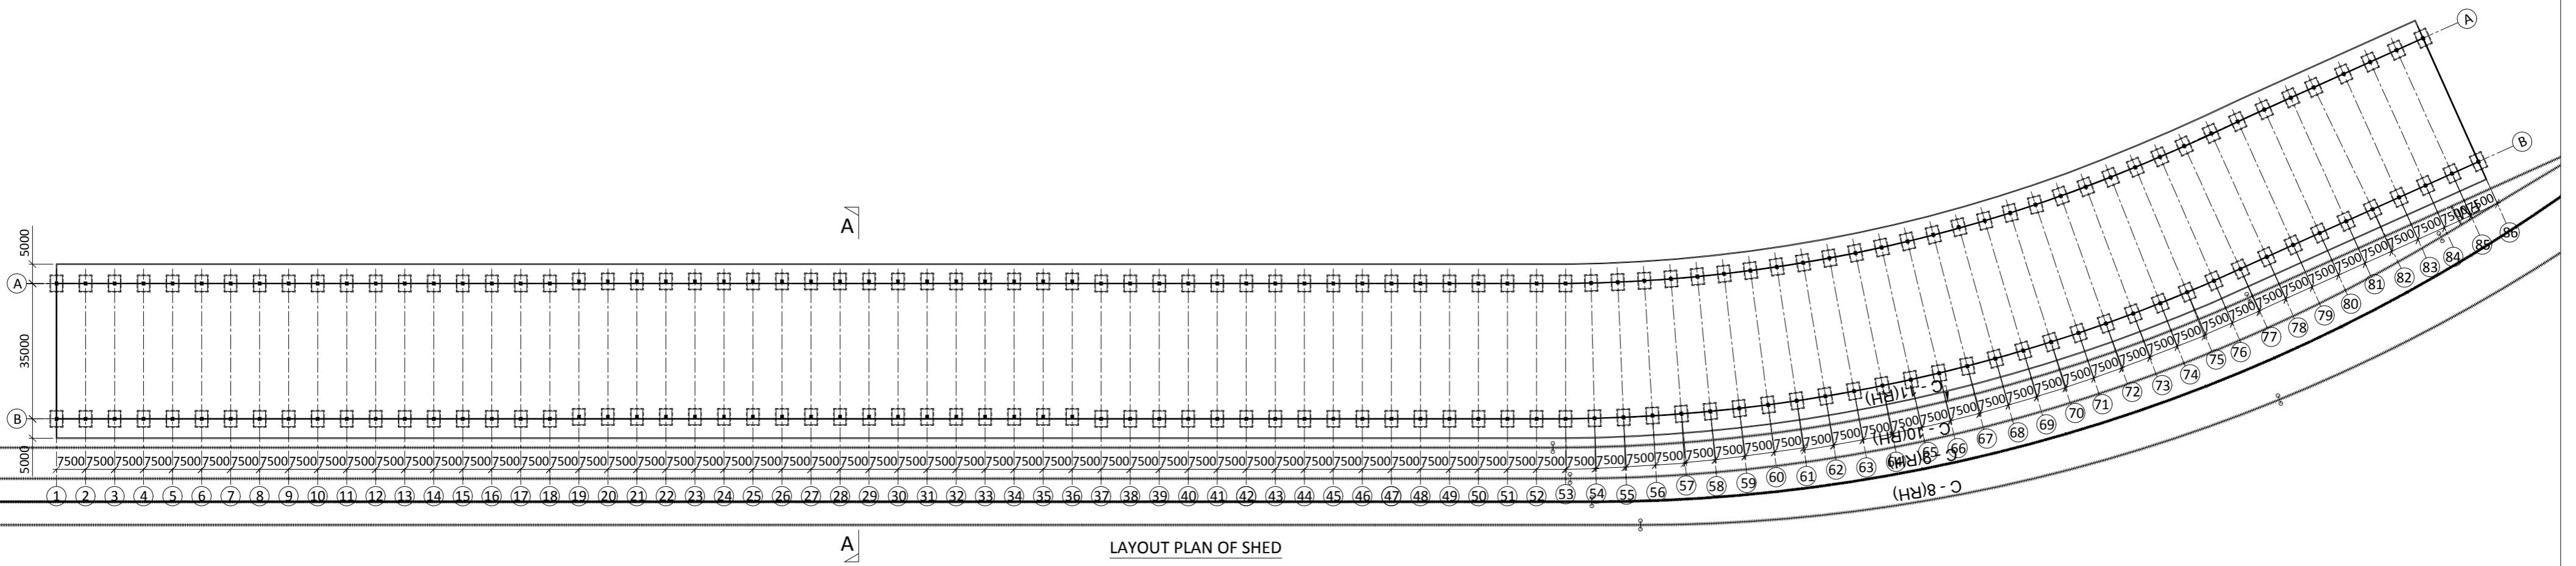

SECTION A-1

NOTES

1. ALL DIMENSIONS ARE IN MILLIMETERS
 2. ALL LEVELS ARE IN METERS & ARE WITH RESPECT TO MSL

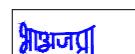


INDIAN WATERWAYS AUTHORITY OF INDIA

PROJECT DETAILED FEASIBILITY STUDY FOR CAPACITY AUGMENTATION OF NATIONAL WATERWAY-1 AND DETAILED ENGINEERING FOR ITS ANCILLARY WORKS AND PROCESS BETWEEN HALDIA TO ALLAHABAD (JAL VIKAS PROJECT)


AND PROCESS BETWEEN HALDIA TO ALLAHABAD (AJL VIKAS PROJECT)					
CONSULTANT	 HOWE	NAME		SIGN	DATE
		DRN	VAP		25/09/17
	 PMC PROJECTS (INDIA) PRIVATE LIMITED from vision to reality...	CHD	AM		25/09/17
		MRP	SP		25/09/17

TITLE	IWT TERMINAL AT VARANASI LAYOUT & ELEVATION OF COVERED STORAGE SHED	APD	SP	25/09/17
-------	--	-----	----	----------


COORDINATE SYSTEM USED: ENTER CO-ORD SYSTEM HERE					
	UNIT	SCALE - AS SHOWN	Size : A1	REV.	0

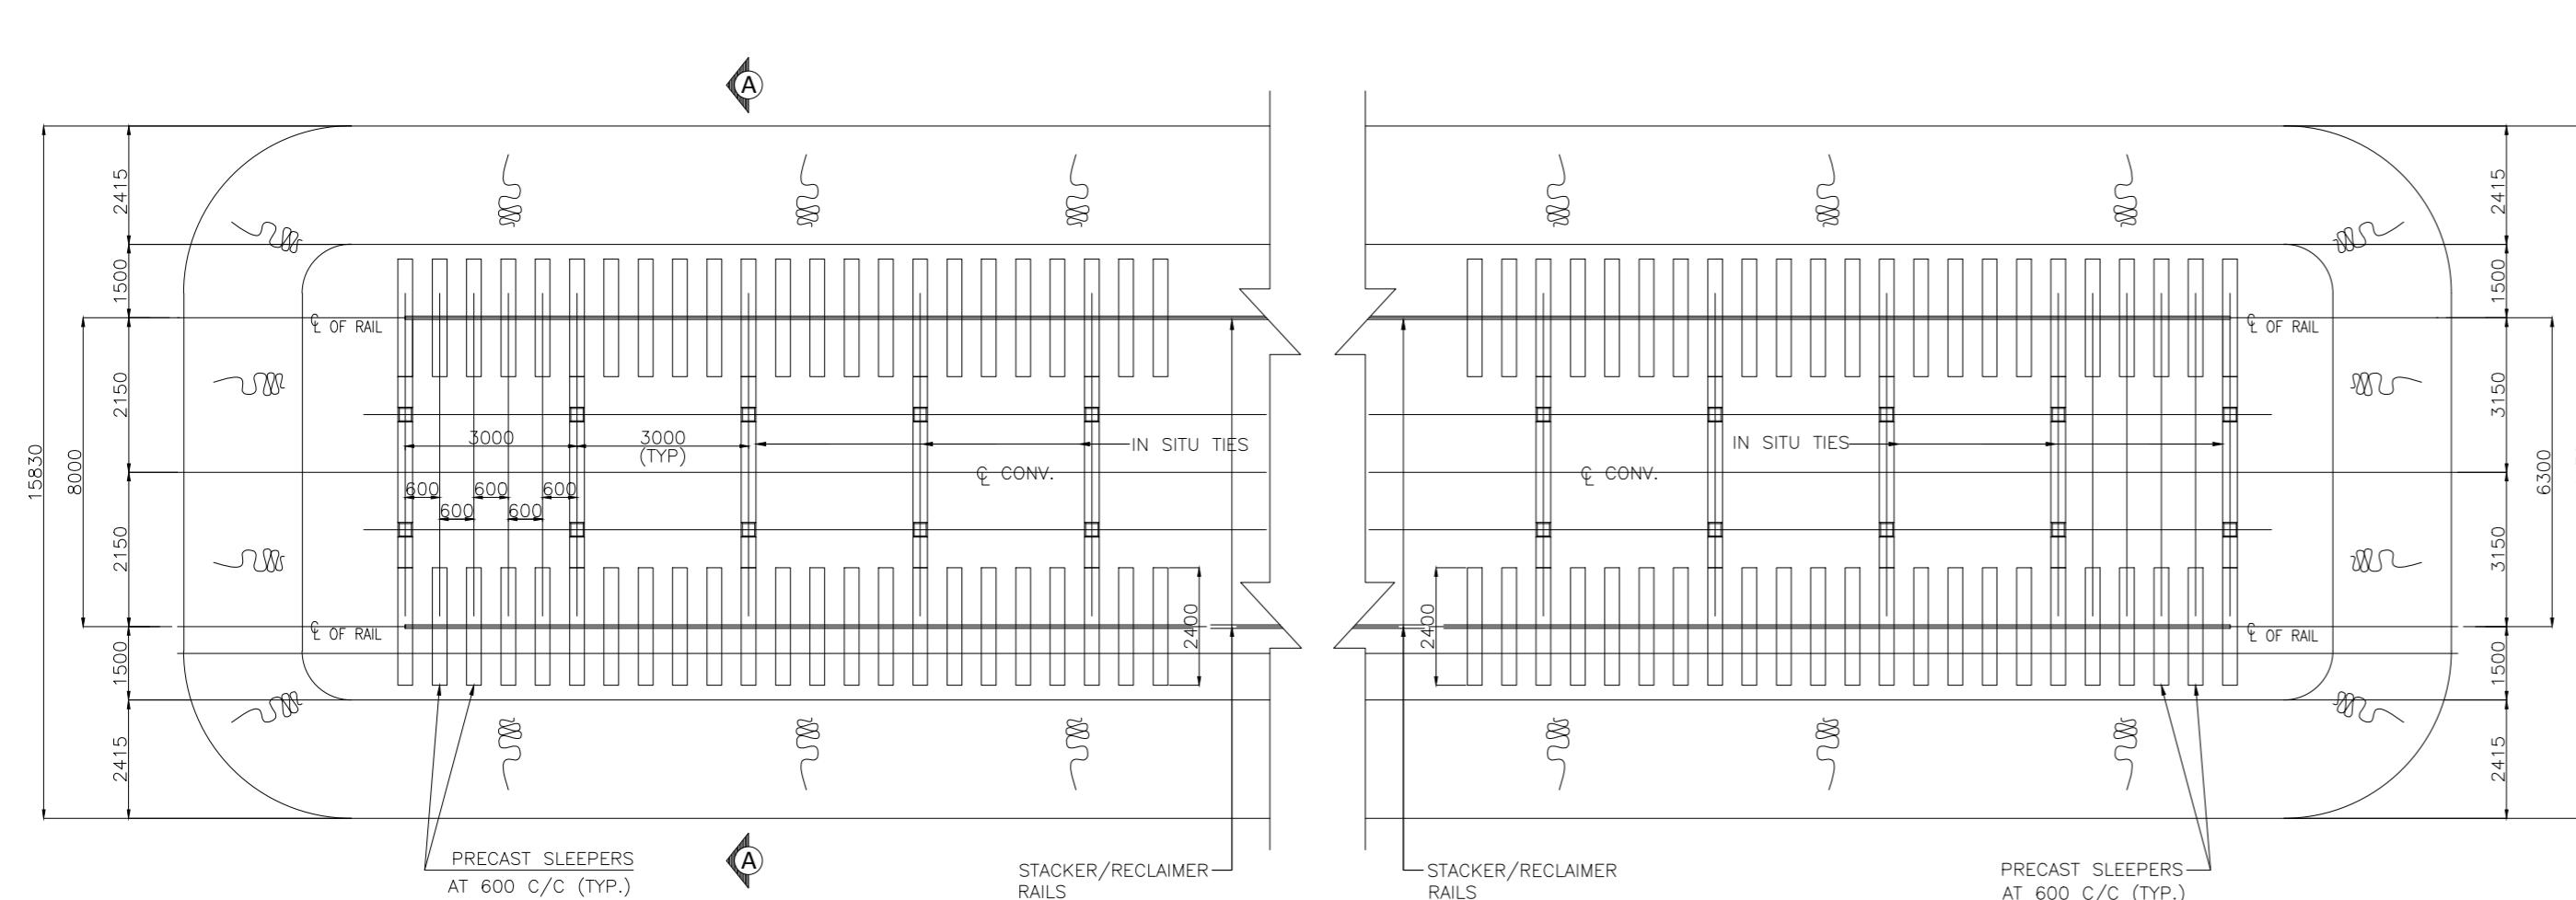


PART PLAN OF STACKER/RECLAIMER TRACK

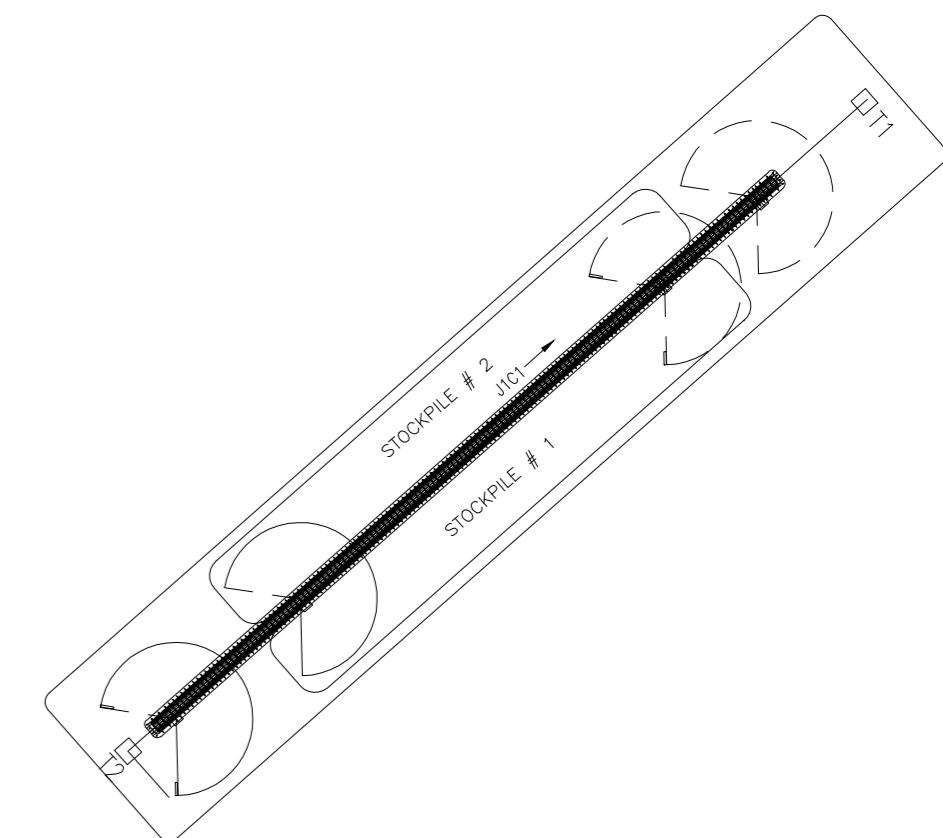


KEY PLAN

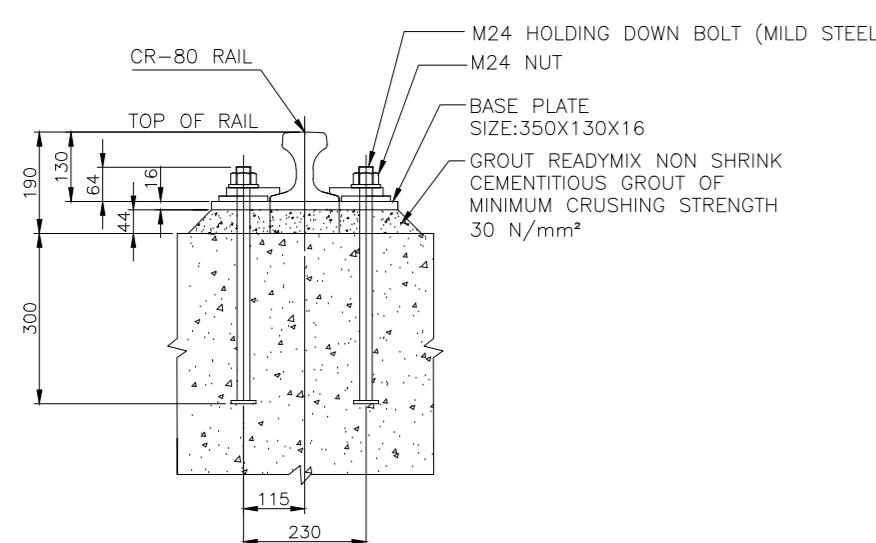


TYP. DETAIL OF RAIL FIXING

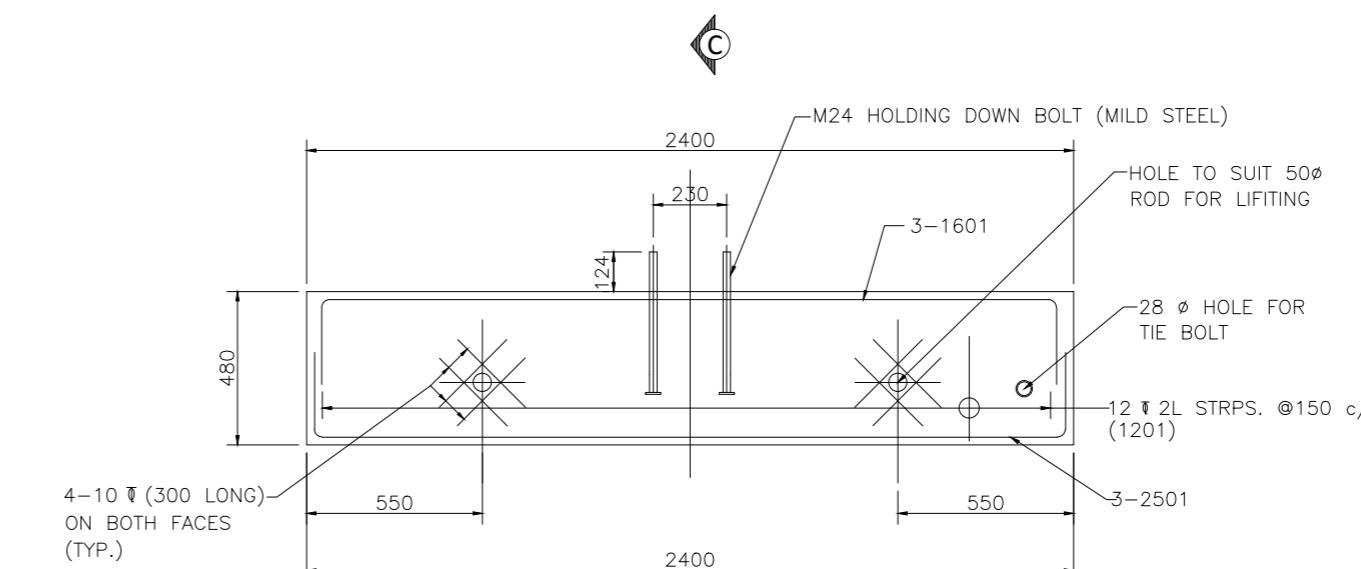

TYP. DETAIL OF PRECAST SLEEPER

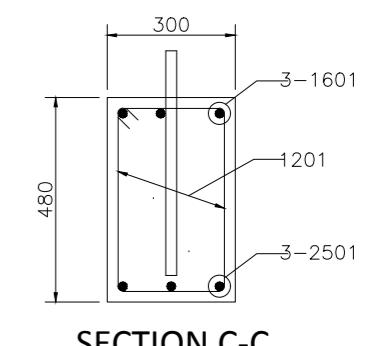

SECTION C-C

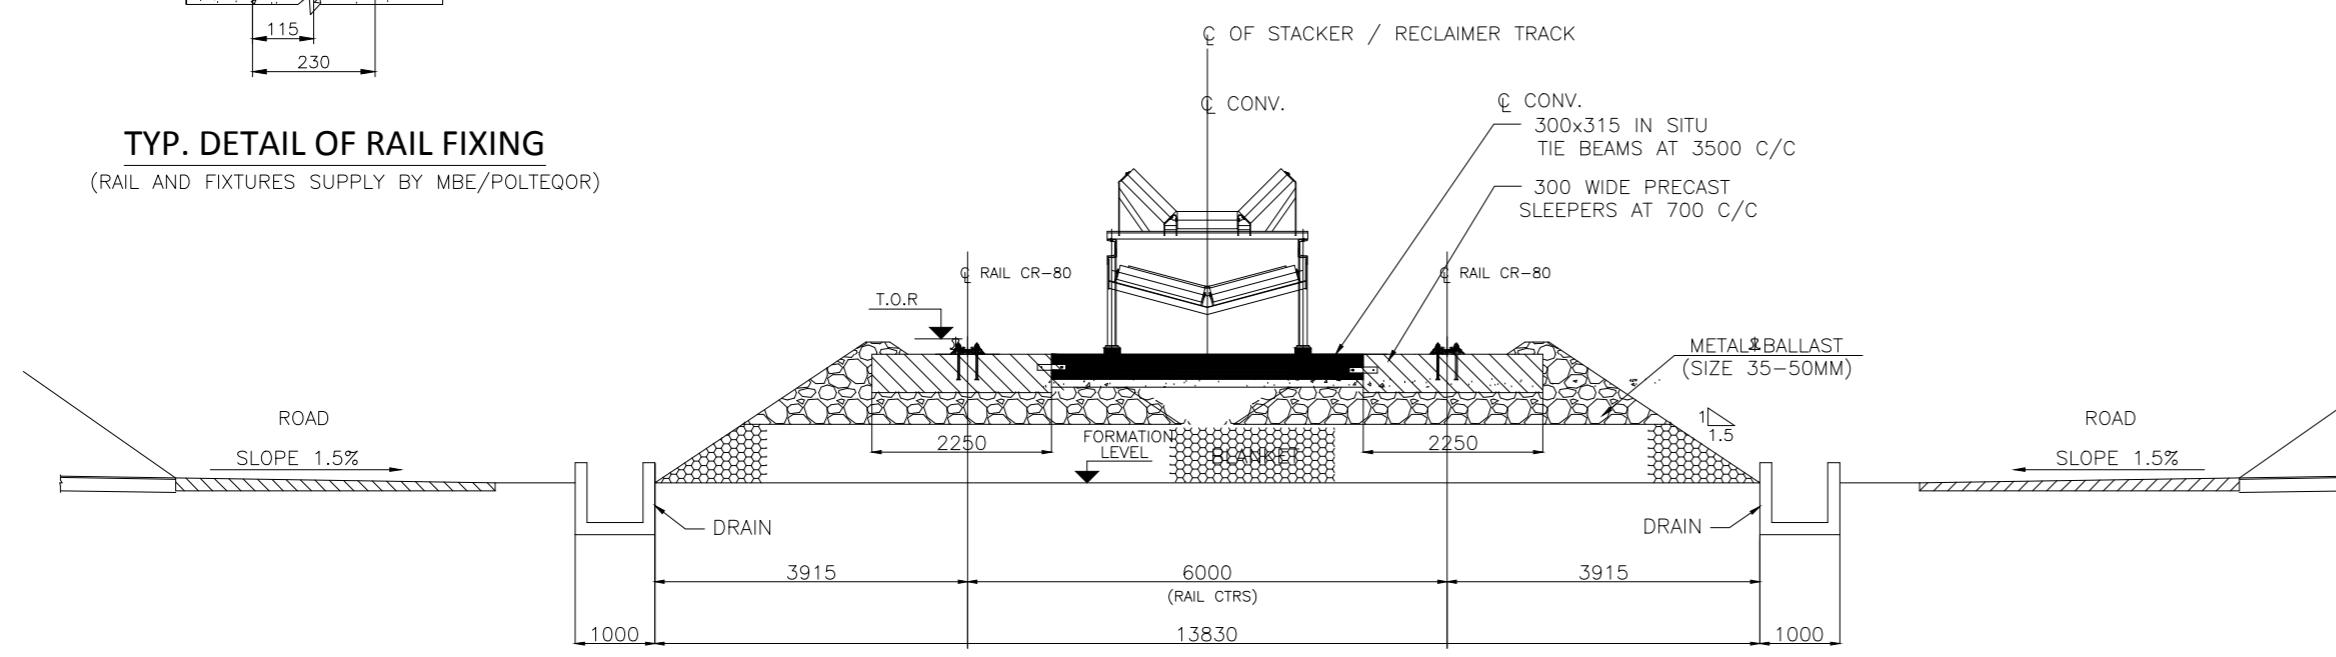

SECTION A-A


NOTE

- #### **1. ALL DIMENSIONS ARE IN MILLIMETERS**




INLAND WATERWAYS AUTHORITY OF INDIA


PROJECT	DETAILED FEASIBILITY STUDY FOR CAPACITY AUGMENTATION OF NATIONAL WATERWAY-1 AND DETAILED ENGINEERING FOR ITS ANCILLARY WORKS AND PROCESS BETWEEN HALDIA TO ALLAHABAD (JAL VIKAS PROJECT)			
CONSULTANT	  PMC PROJECTS (INDIA) PRIVATE LIMITED from vision to reality...		NAME	SIGN
	DRN	VAP	25/09/17	
	CHD	AM	25/09/17	
	APD	SP	25/09/17	
TITLE	IWT TERMINAL AT VARANASI TYPICAL DETAILS OF STOCKYARD		JOB. NO.	DRG. NO.
			I-525	VTR-218
COORDINATE SYSTEM USED:				
ENTER CO-ORD SYSTEM HERE				
	UNIT	SCALE - AS SHOWN	Size : A1	REV. 0

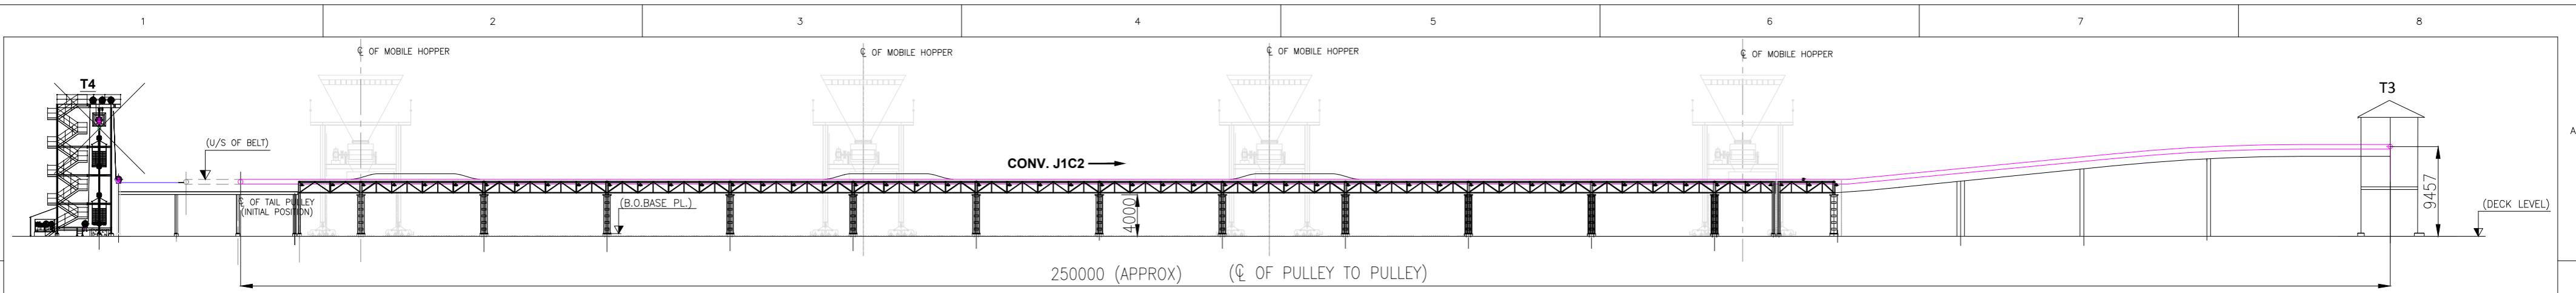


CONVEYOR GEOMETRY FOR CONV. J1C1

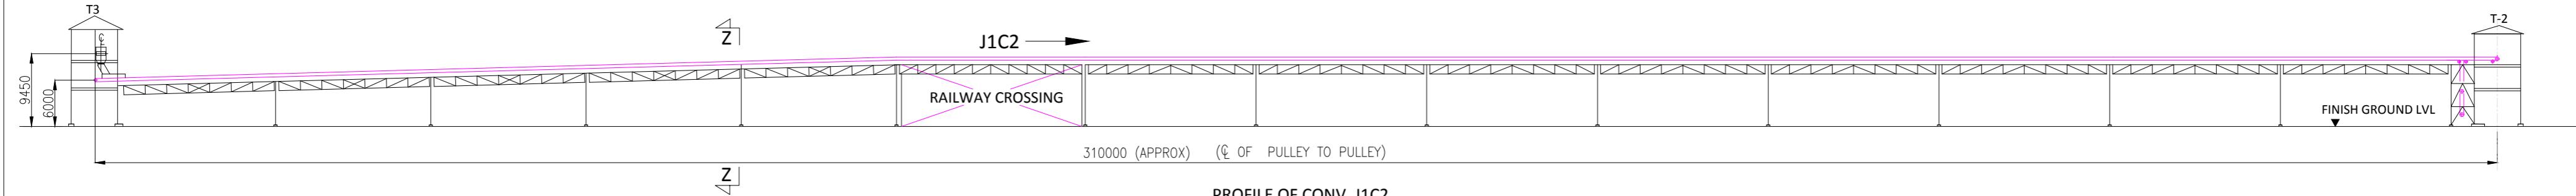


PROFILE OF CONV. J1C2

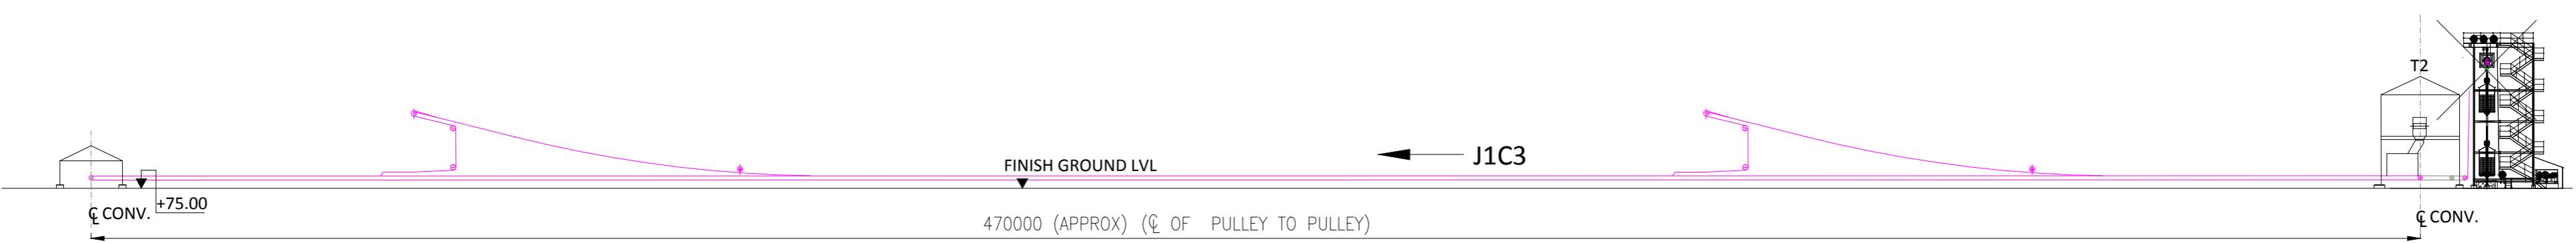

PROFILE OF CONV. J1C3

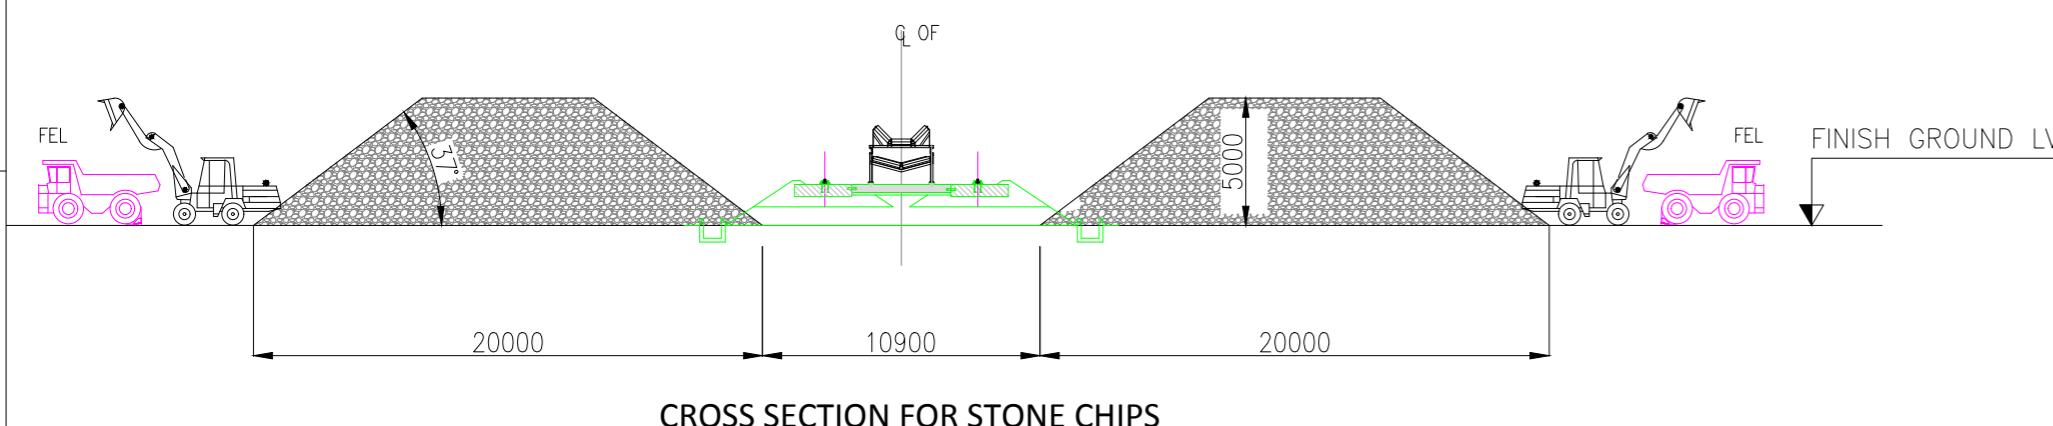

CROSS SECTION FOR STONE CHIPS

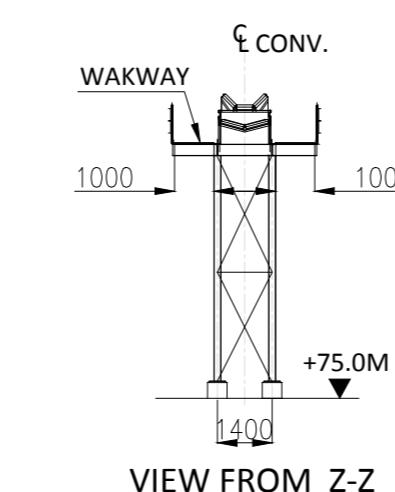


VIEW FROM Z-Z


NOTES

- ALL LEVELS ARE IN METRES AND ARE WITH RESPECT TO MSL.
- ALL DIMENSIONS ARE IN MILLIMETERS


INLAND WATERWAYS AUTHORITY OF INDIA			
PROJECT DETAILED FEASIBILITY STUDY FOR CAPACITY AUGMENTATION OF NATIONAL WATERWAY-1 AND DETAILED ENGINEERING FOR ITS ANCILLARY WORKS AND PROCESS BETWEEN HALDIA TO ALLAHABAD (JAL VIKAS PROJECT)			
CONSULTANT HOWE PMC PROJECTS (INDIA) PRIVATE LIMITED from vision to reality...			
DRN	VAP	SIGN	DATE
CHD	AM		25/09/17
APD	SP		25/09/17
TITLE IWT TERMINAL AT VARANASI CONVEYOR PROFILE			
JOB. NO. I-525 DRG. NO. VTR-219			
COORDINATE SYSTEM USED: ENTER CO-ORD SYSTEM HERE			
REV. 0	25/09/17	VAP AM SP	DRN CHD APD
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TYP. CROSS SECTION OF 4 LANE WIDE PROPOSED ROAD

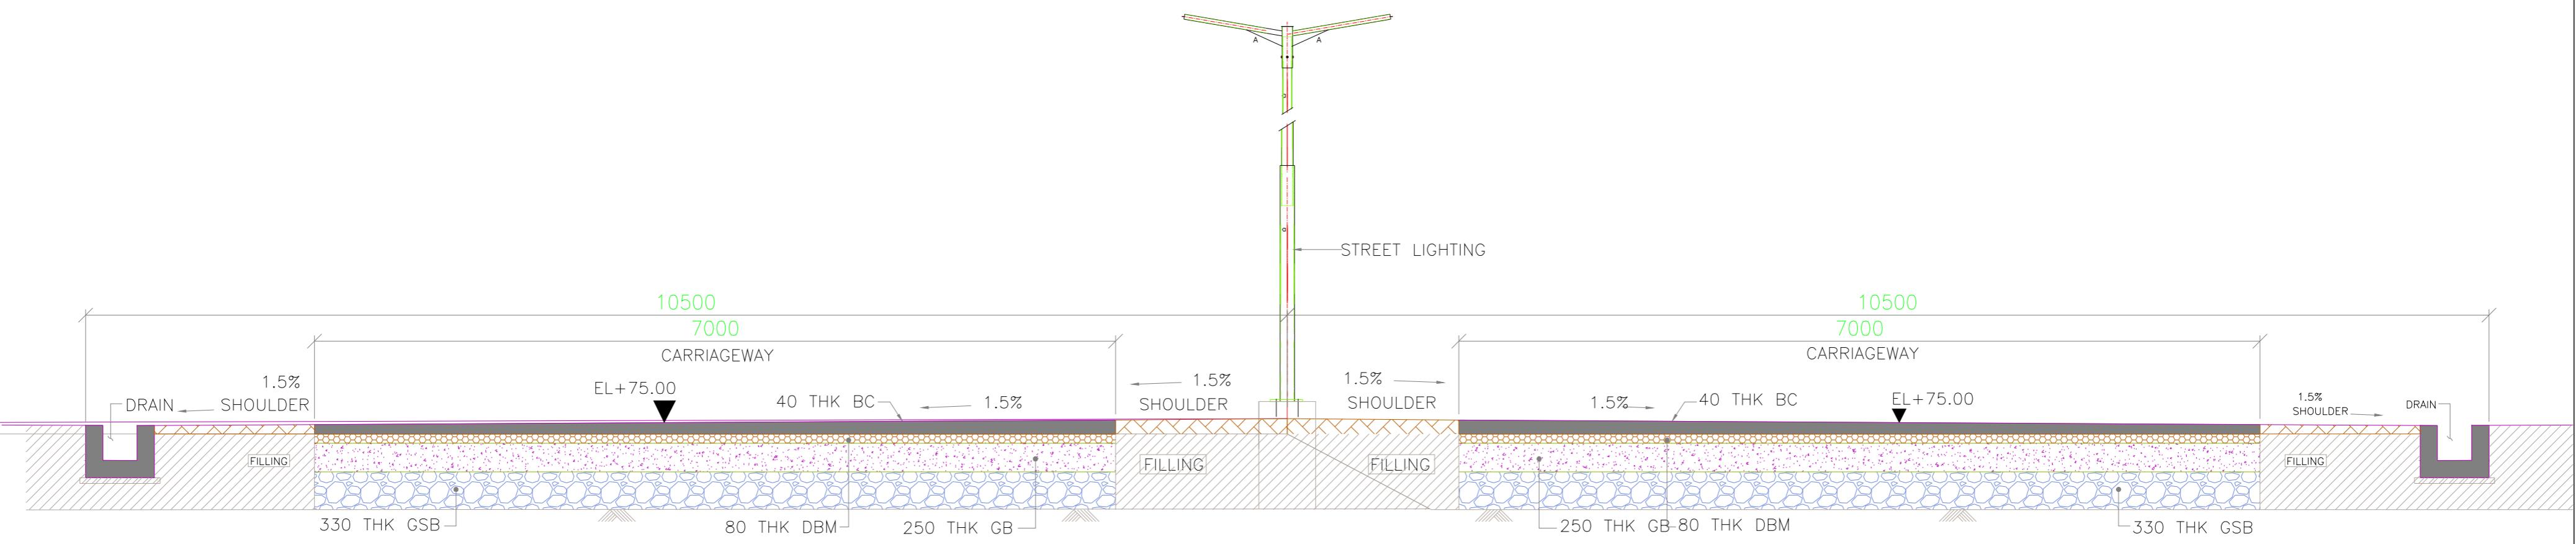


TYP. CROSS SECTION OF 12.0M WIDE PROPOSED ROAD

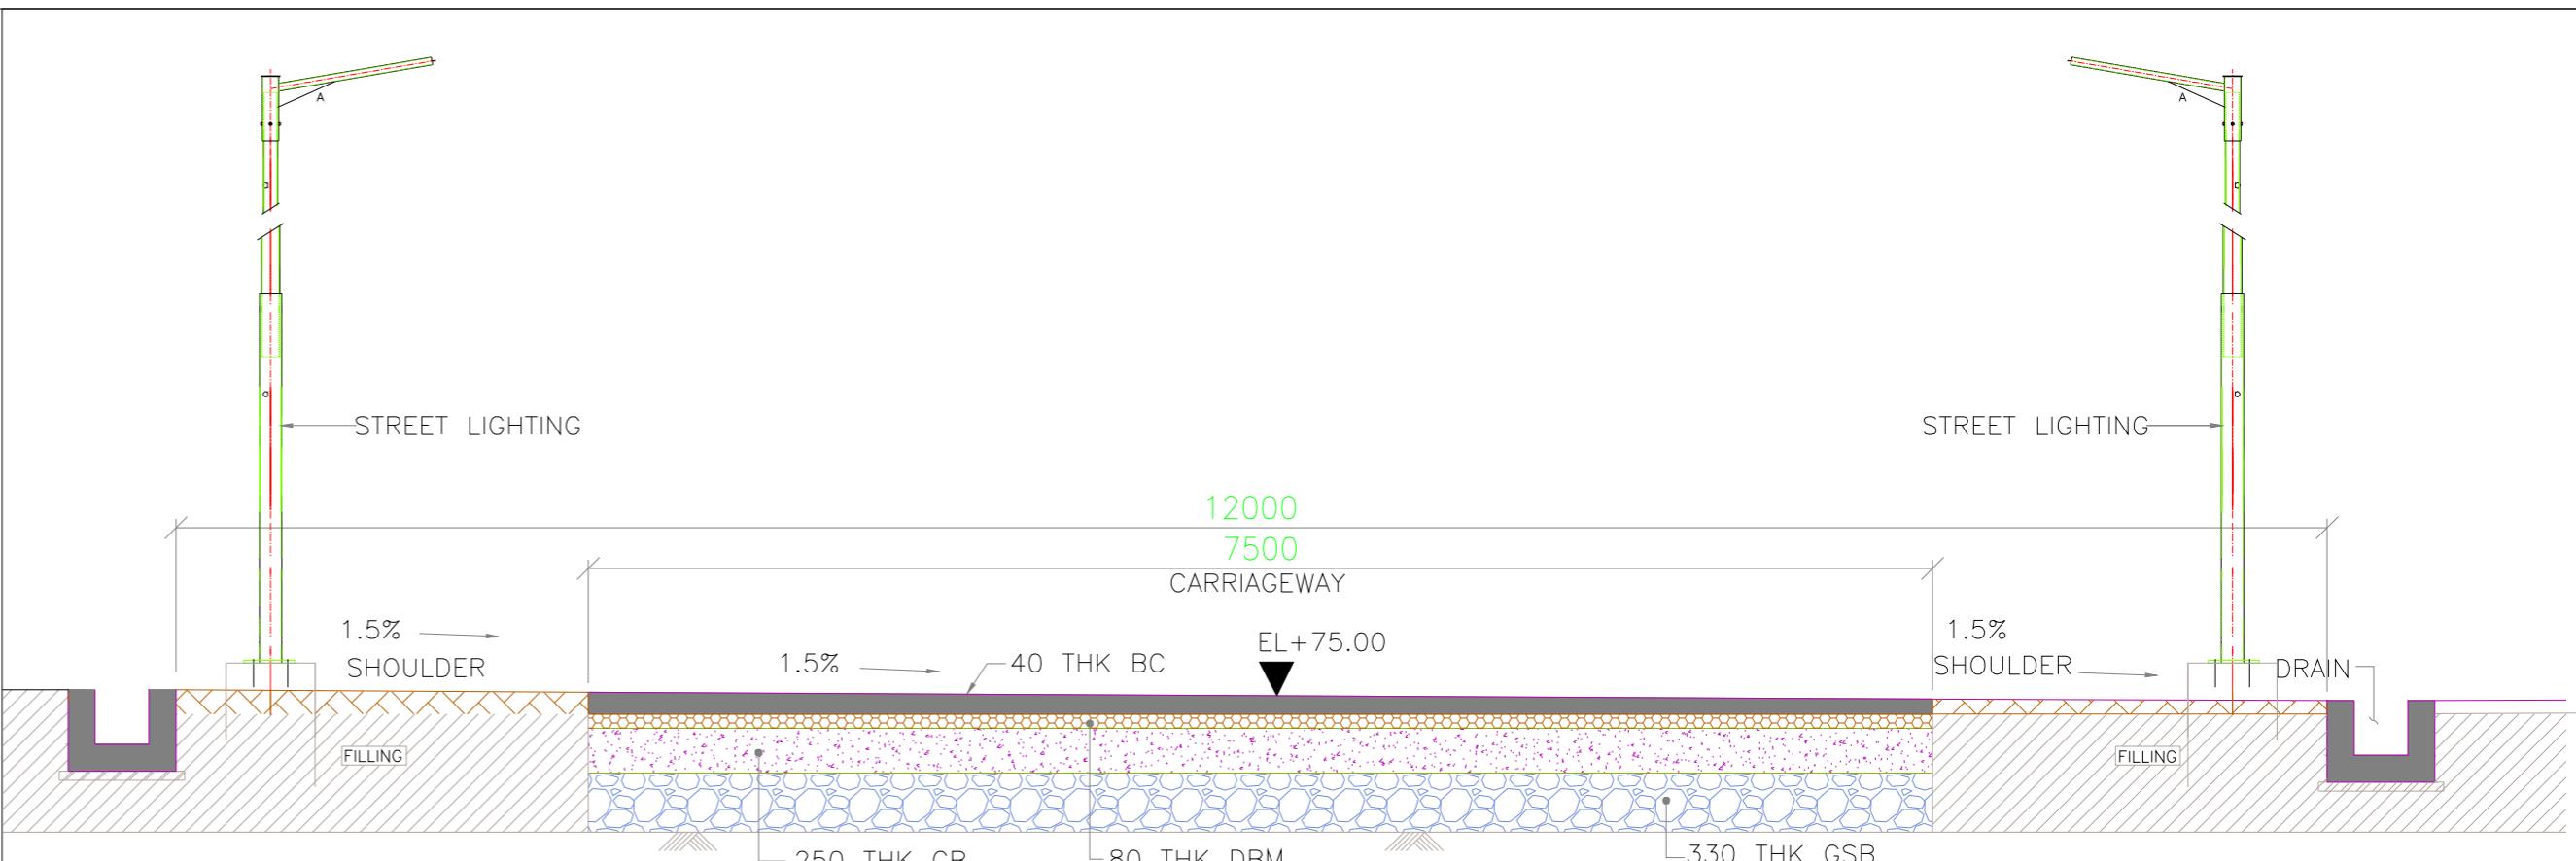


TYP. CROSS SECTION OF 7.50 M WIDE PROPOSED ROAD

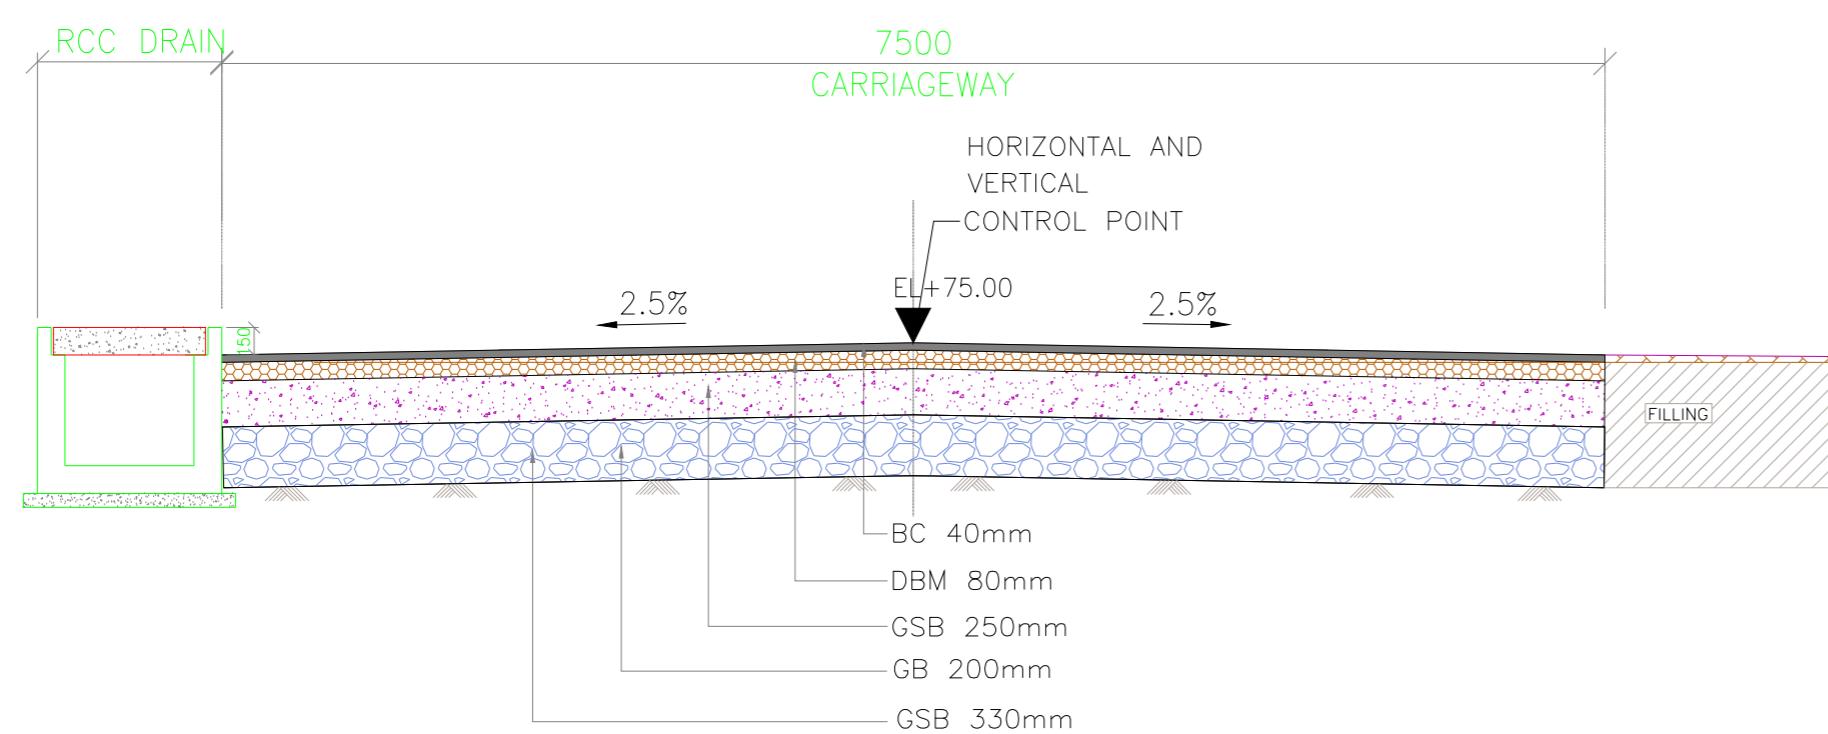NOTES	
1. ALL DIMENSIONS ARE IN MM.	
2. ALL LEVELS ARE IN METRE & ARE WITH RESPECT TO MSL	
INLAND WATERWAYS AUTHORITY OF INDIA	
PROJECT: DETAILED FEASIBILITY STUDY FOR CAPACITY AUGMENTATION OF NATIONAL WATERWAY-1 AND DETAILED ENGINEERING FOR ITS ANCILLARY WORKS AND PROCESS BETWEEN HALDIA TO ALLAHABAD (JAL VIKAS PROJECT)	
CONSULTANT: PMC PROJECTS (INDIA) PRIVATE LIMITED from vision to reality...	
HOWE	
REV. DATE: 0 25/09/17 DRN CHD APD NAME SIGN DATE 25/09/17 VAP AM SP 25/09/17	
TITLE: IWT TERMINAL AT VARANASI TYPICAL CROSS SECTIONS OF ROAD	
JOB. NO. DRG. NO. I-525 VTR-220	
COORDINATE SYSTEM USED: ENTER CO-ORD SYSTEM HERE	
UNIT SCALE - AS SHOWN Size : A1 REV. 0	

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LEGEND

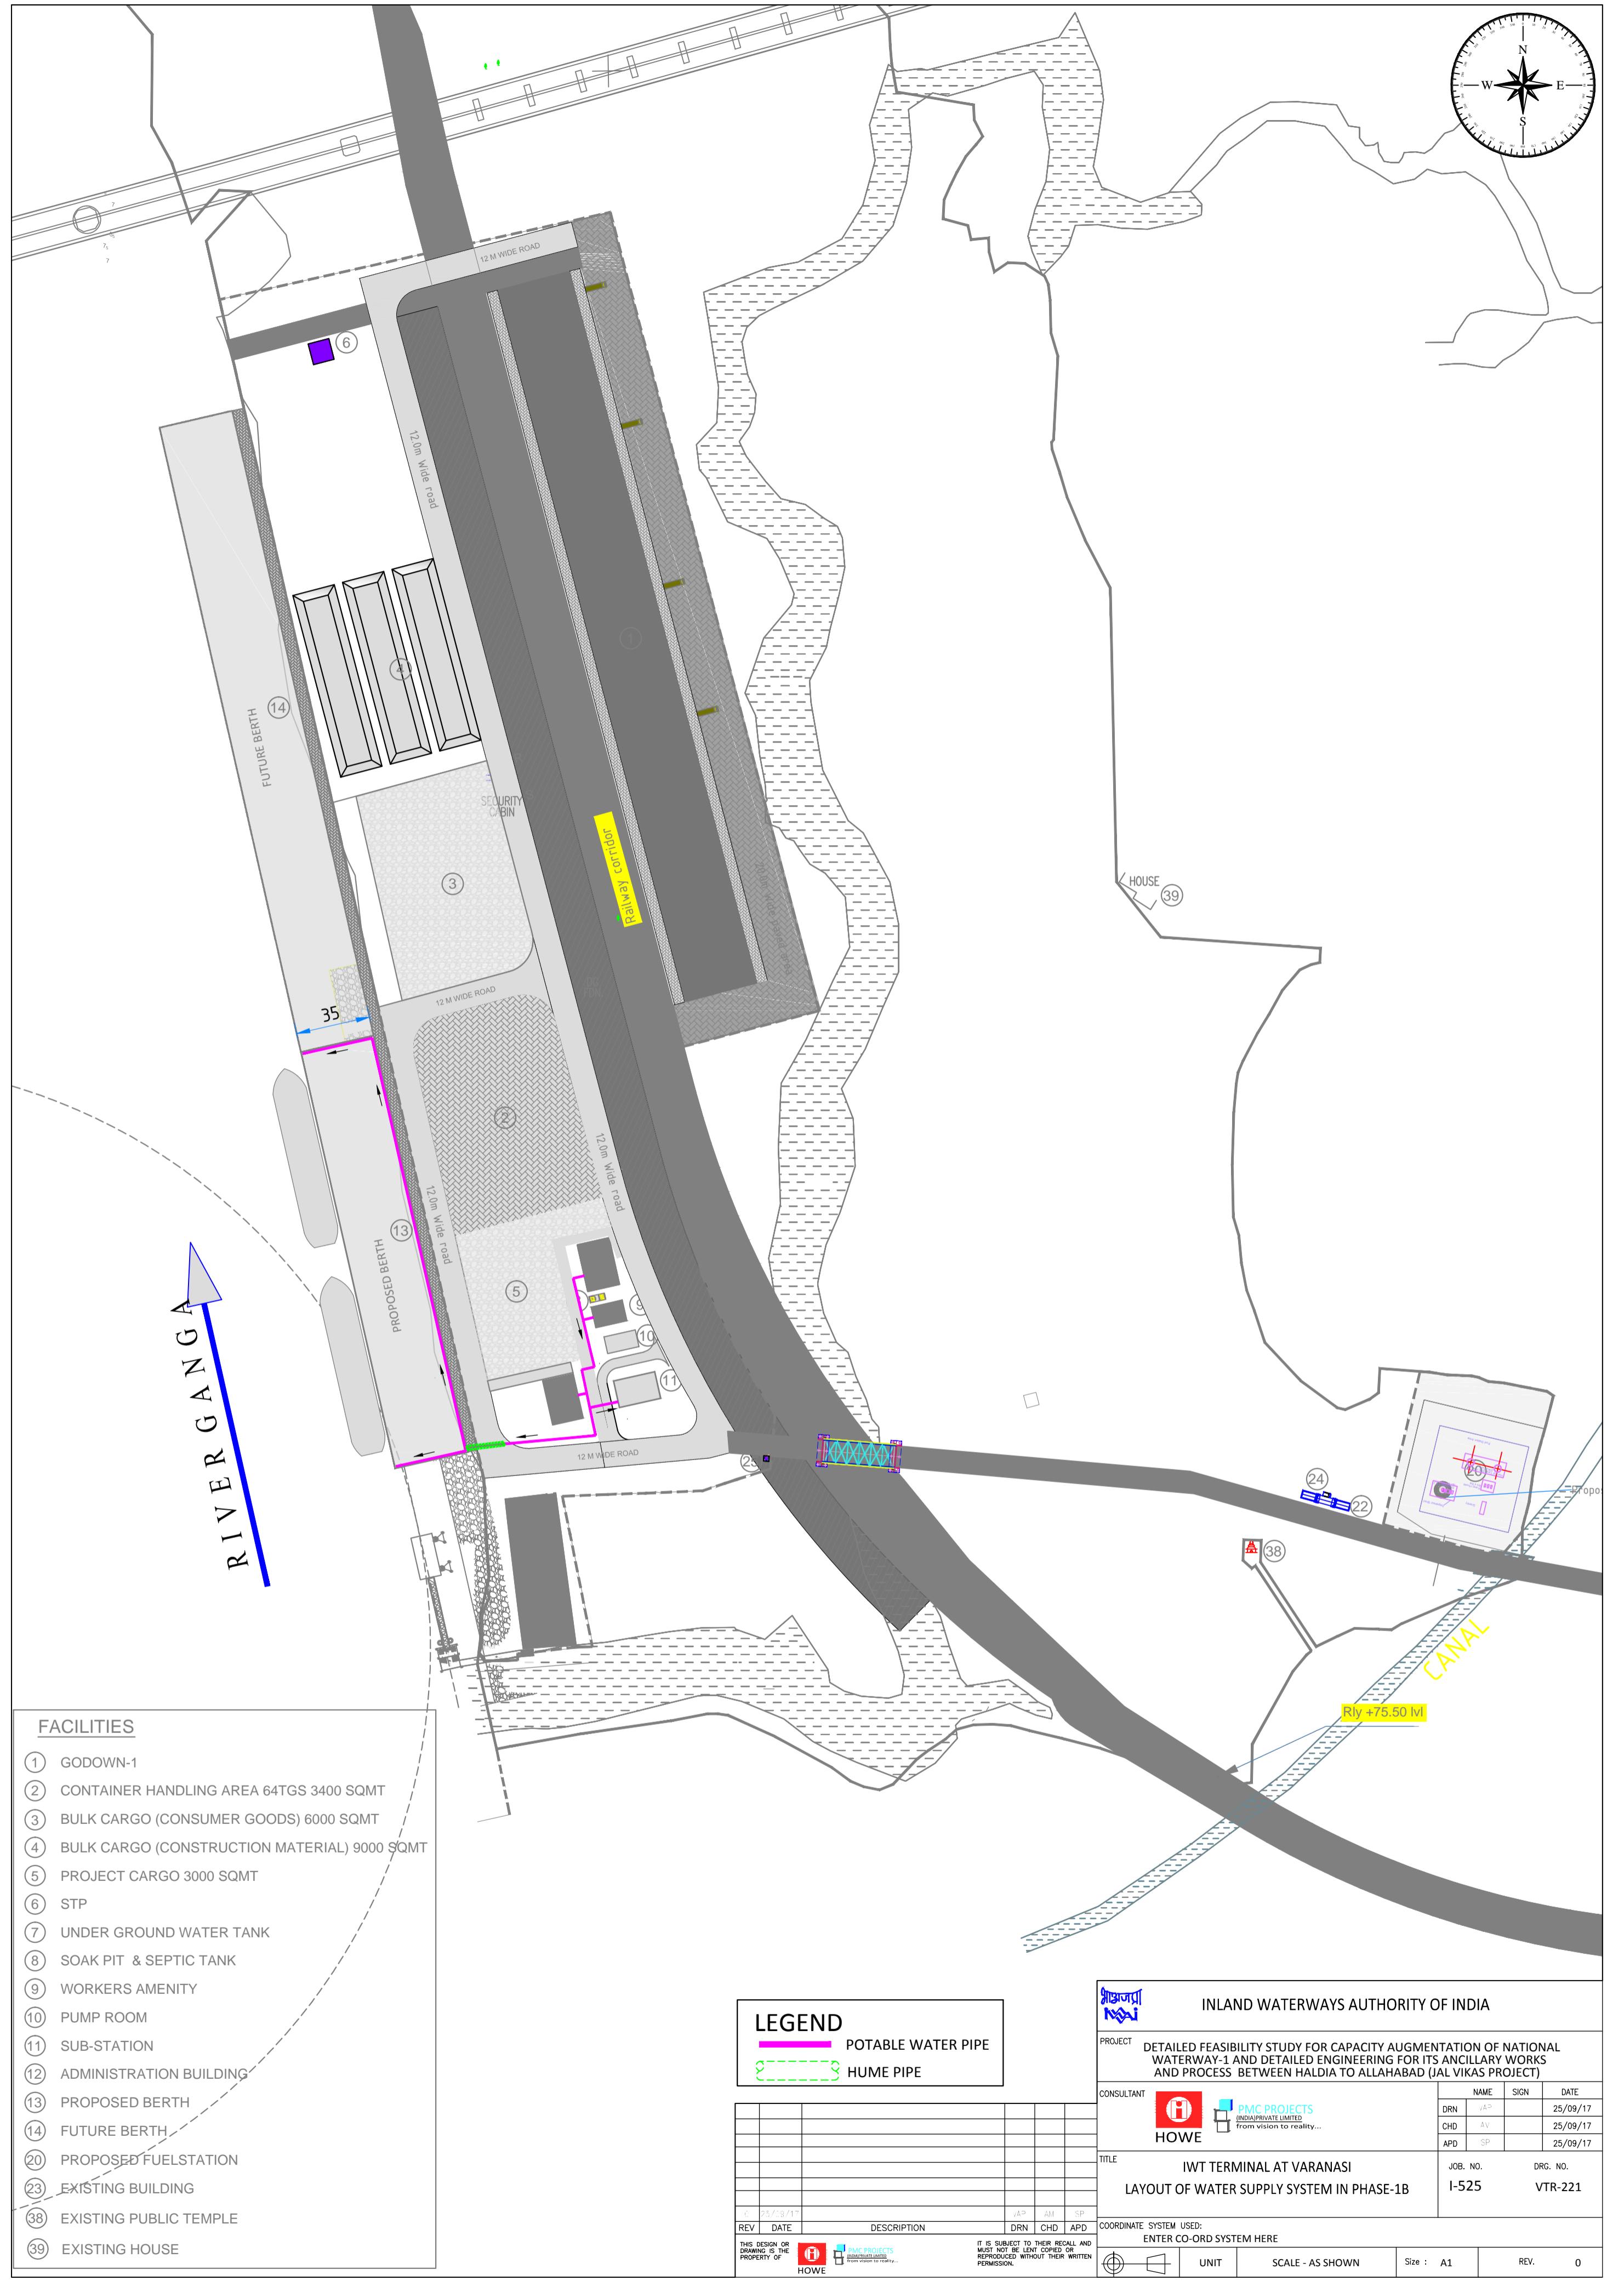- POTABLE WATER PIPE (Solid Magenta Line)
- HUME PIPE (Dashed Green Line)

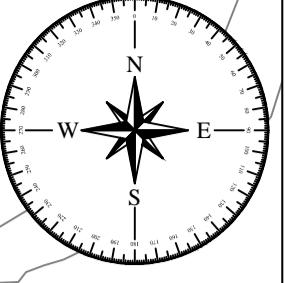
- (1) GODOWN-1
- (2) CONTAINER HANDLING AREA 96TGS 7800 SQMT
- (3) BULK CARGO (CONSUMER GOODS) 6000 SQMT
- (4) BULK CARGO (CONSTRUCTION MATERIAL) 2500 SQMT
- (5) PROJECT CARGO 3600 SQMT
- (6) OVER HEAD WATER TANK
- (7) UNDER GROUND WATER TANK
- (8) SOAK PIT & SEPTIC TANK
- (9) WORKERS AMENITY
- (10) PUMP ROOM
- (11) SUB-STATION
- (12) ADMINISTRATION BUILDING
- (13) LOADING UNLOADING JETTY -PHASE-I
- (14) BERTH - PHASE-II
- (15) BANARASI HAAT
- (16) TOILET BLOCK
- (17) SHOPS / KIOSKS
- (18) JAI YATRI NIWAS (GUEST HOUSE)
- (19) PARKING AREA-20NOS
- (20) PROPOSED FUELSTATION
- (21) GATE COMPLEX
- (22) WEIGH BRIDGE
- (23) EXISTING BUILDING
- (24) WEIGH BRIDGE CABIN
- (25) SECURITY OFFICE
- (26) RAILWAY YARD AREA
- (27) UTILITY AREA
- (28) CONSTRUCTION MATERIAL BULK 22835 SQMT
- (29) CANTEEN & TOILET
- (30) 12NOS-E-RIKSHA STAND
- (31) 2NOS-BUS PARKING
- (32) 180NOS-SCOOTER PARKING
- (33) 45NOS-CYCLE PARKING
- (34) 240NOS-RIKSHA PARKING
- (35) 28NOS-CAR PARKING
- (36) 20NOS-E-RIKSHA STAND
- (37) ETP/UTILITY
- (38) EXISTING PUBLIC TEMPLE
- (39) EXISTING HOUSE


REV	DATE	DESCRIPTION	DRN	CHD	APD
C-25.05.17					

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INLAND WATERWAYS AUTHORITY OF INDIA					
PROJECT DETAILED FEASIBILITY STUDY FOR CAPACITY AUGMENTATION OF NATIONAL WATERWAY-1 AND DETAILED ENGINEERING FOR ITS ANCILLARY WORKS AND PROCESS BETWEEN HALDIA TO ALLAHABAD (JAL VIKAS PROJECT)					
CONSULTANT PMC PROJECTS (INDIA) PRIVATE LIMITED from vision to reality... HOWE					
NAME	SIGN	DATE	DRN	V.A.T.	25/09/17
CHD	APD	25/09/17	CHD	APD	25/09/17
TITLE IWT TERMINAL AT VARANASI LAYOUT OF WATER SUPPLY SYSTEM IN MASTER PLAN					
JOB. NO. DRG. NO. I-525 VTR-222					
COORDINATE SYSTEM USED: ENTER CO-ORD SYSTEM HERE					
UNIT	SCALE - AS SHOWN	Size : A1	REV.	0	





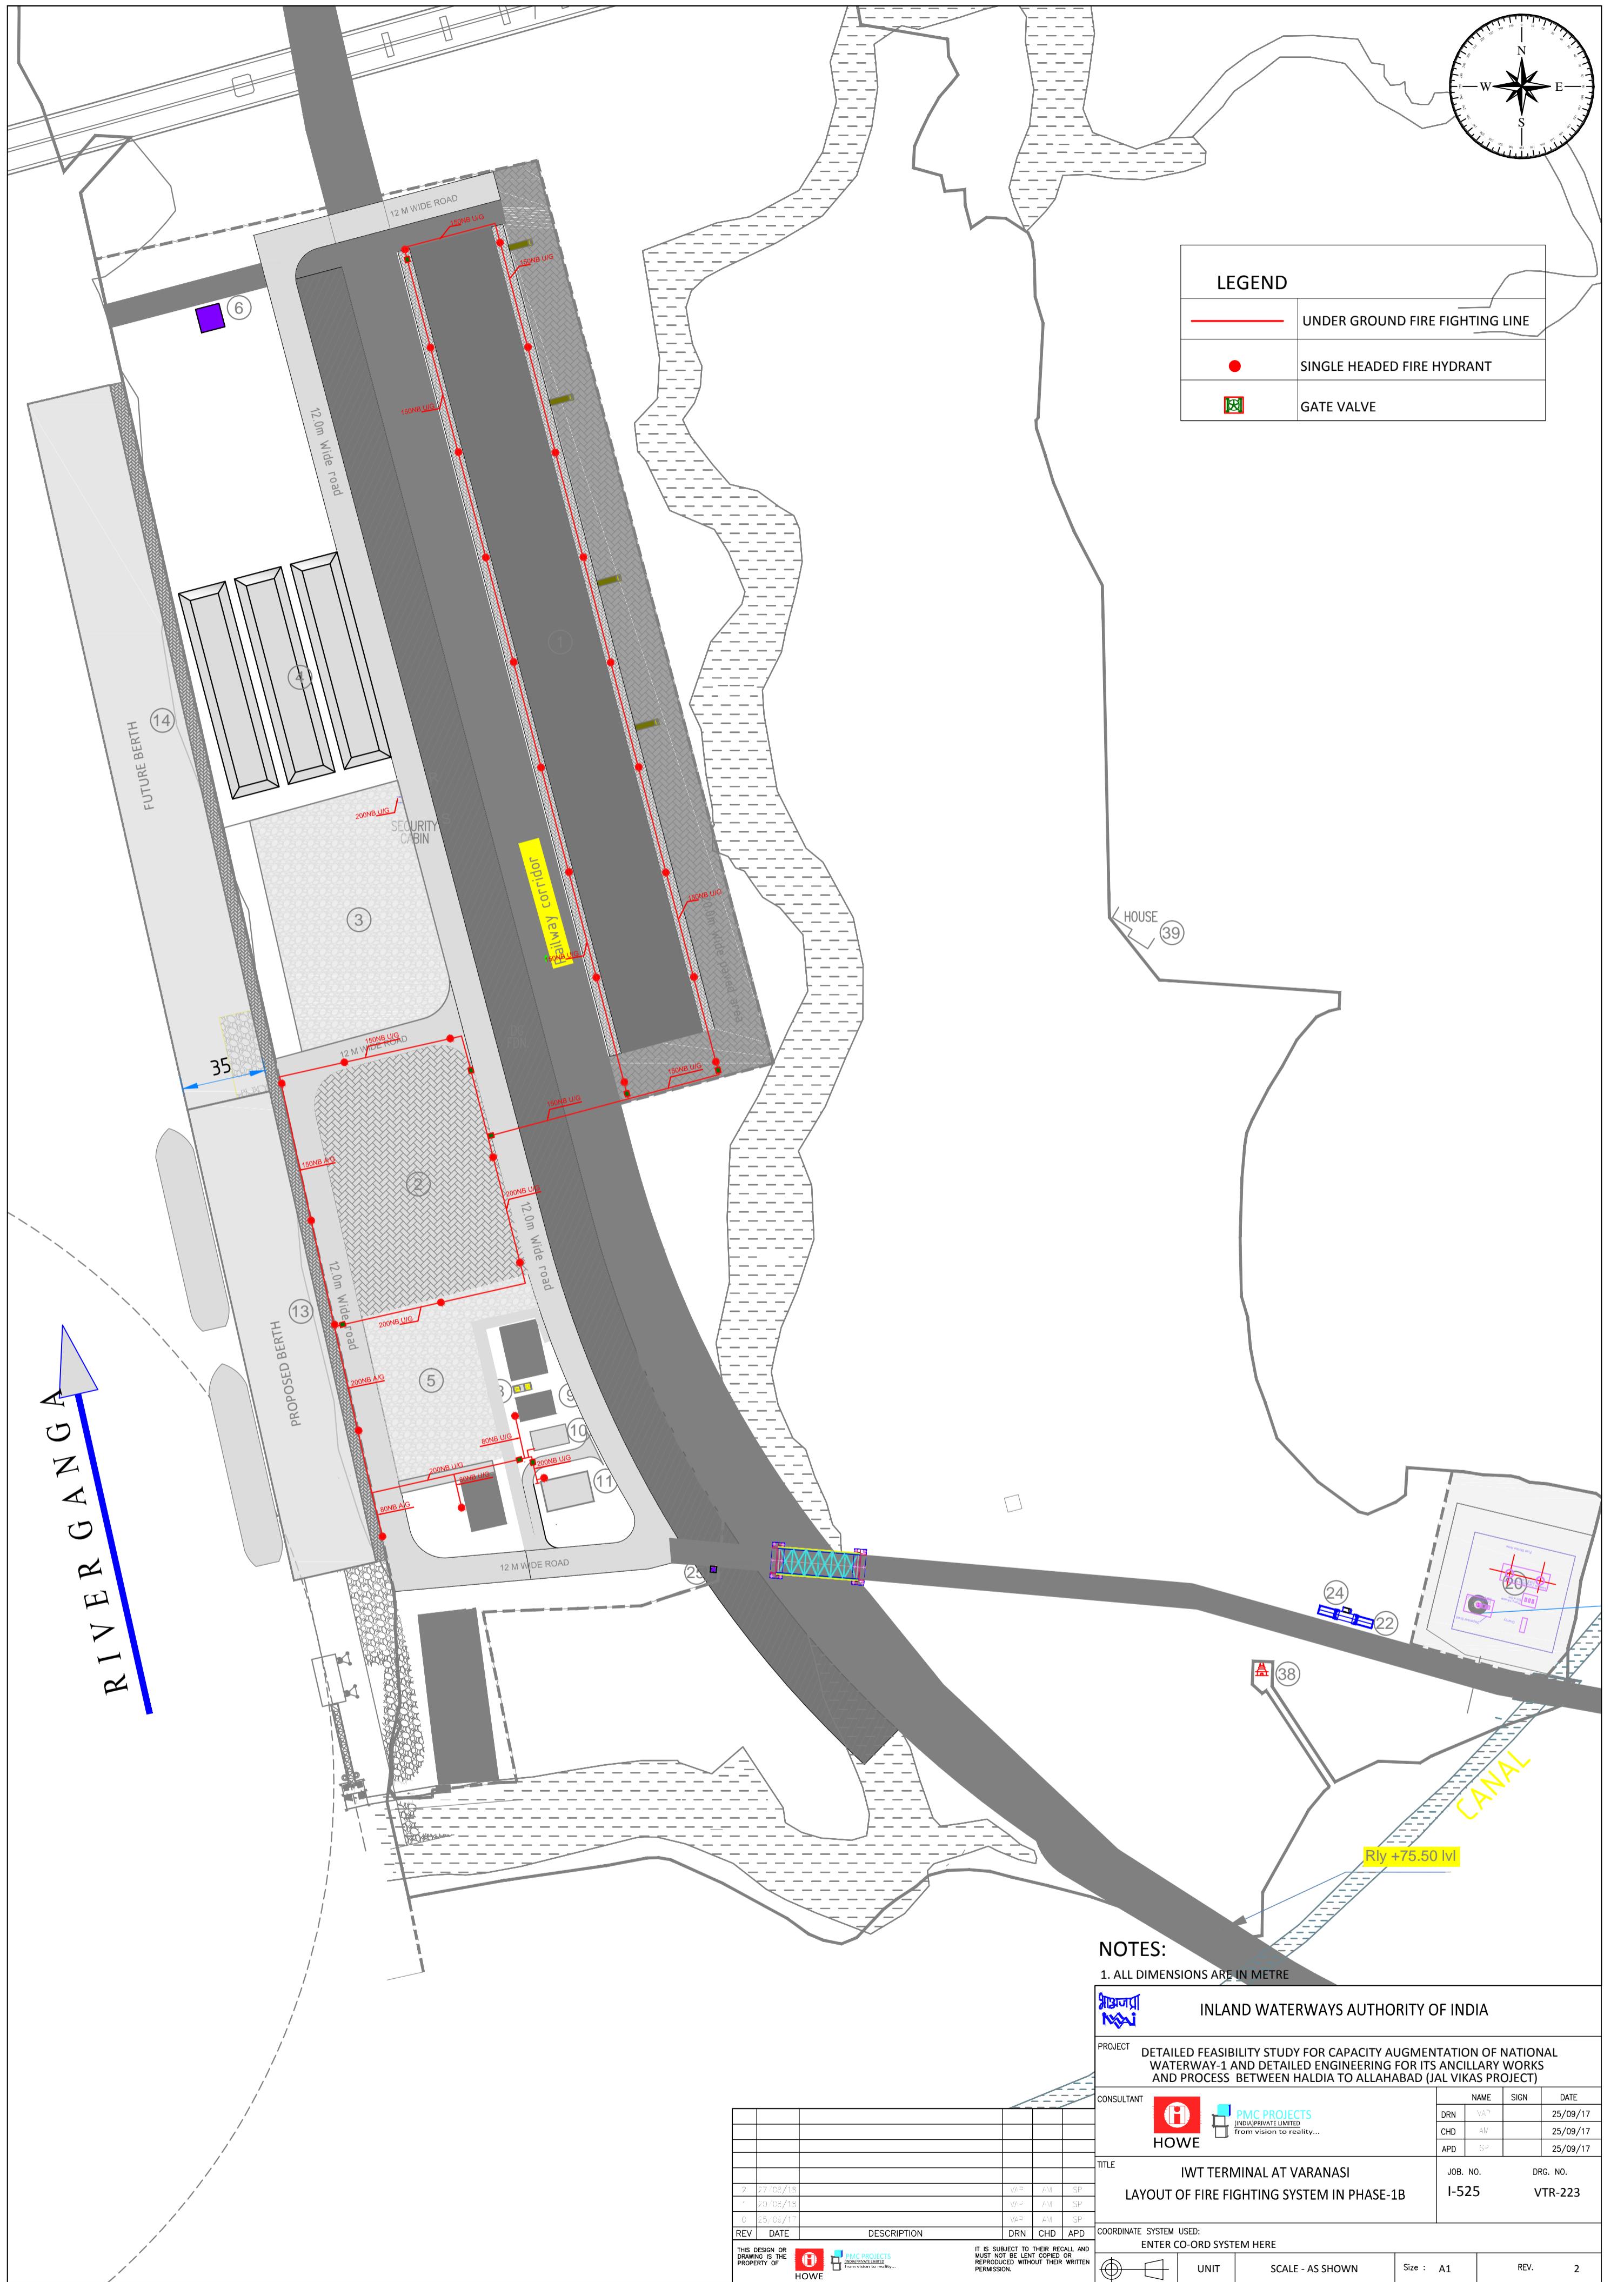

INLAND WATERWAYS AUTHORITY OF INDIA		
PROJECT DETAILED FEASIBILITY STUDY FOR CAPACITY AUGMENTATION OF NATIONAL WATERWAY-1 AND DETAILED ENGINEERING FOR ITS ANCILLARY WORKS AND PROCESS BETWEEN HALDIA TO ALLAHABAD (JAL VIKAS PROJECT)		
CONSULTANT	PMC PROJECTS INDIA PRIVATE LIMITED from vision to reality... HOWE	
REV. 02/09/17	DATE 25/09/17	NAME V-P 25/09/17
CHD 25/09/17	APD 25/09/17	SIGN 25/09/17
TITLE IWT TERMINAL AT VARANASI LAYOUT OF FIRE FIGHTING SYSTEM IN MASTER PLAN		
JOB. NO. DRG. NO.		
I-525 VTR-224		
COORDINATE SYSTEM USED: ENTER CO-ORD SYSTEM HERE		
UNIT SCALE - AS SHOWN Size : A1 REV. 0		
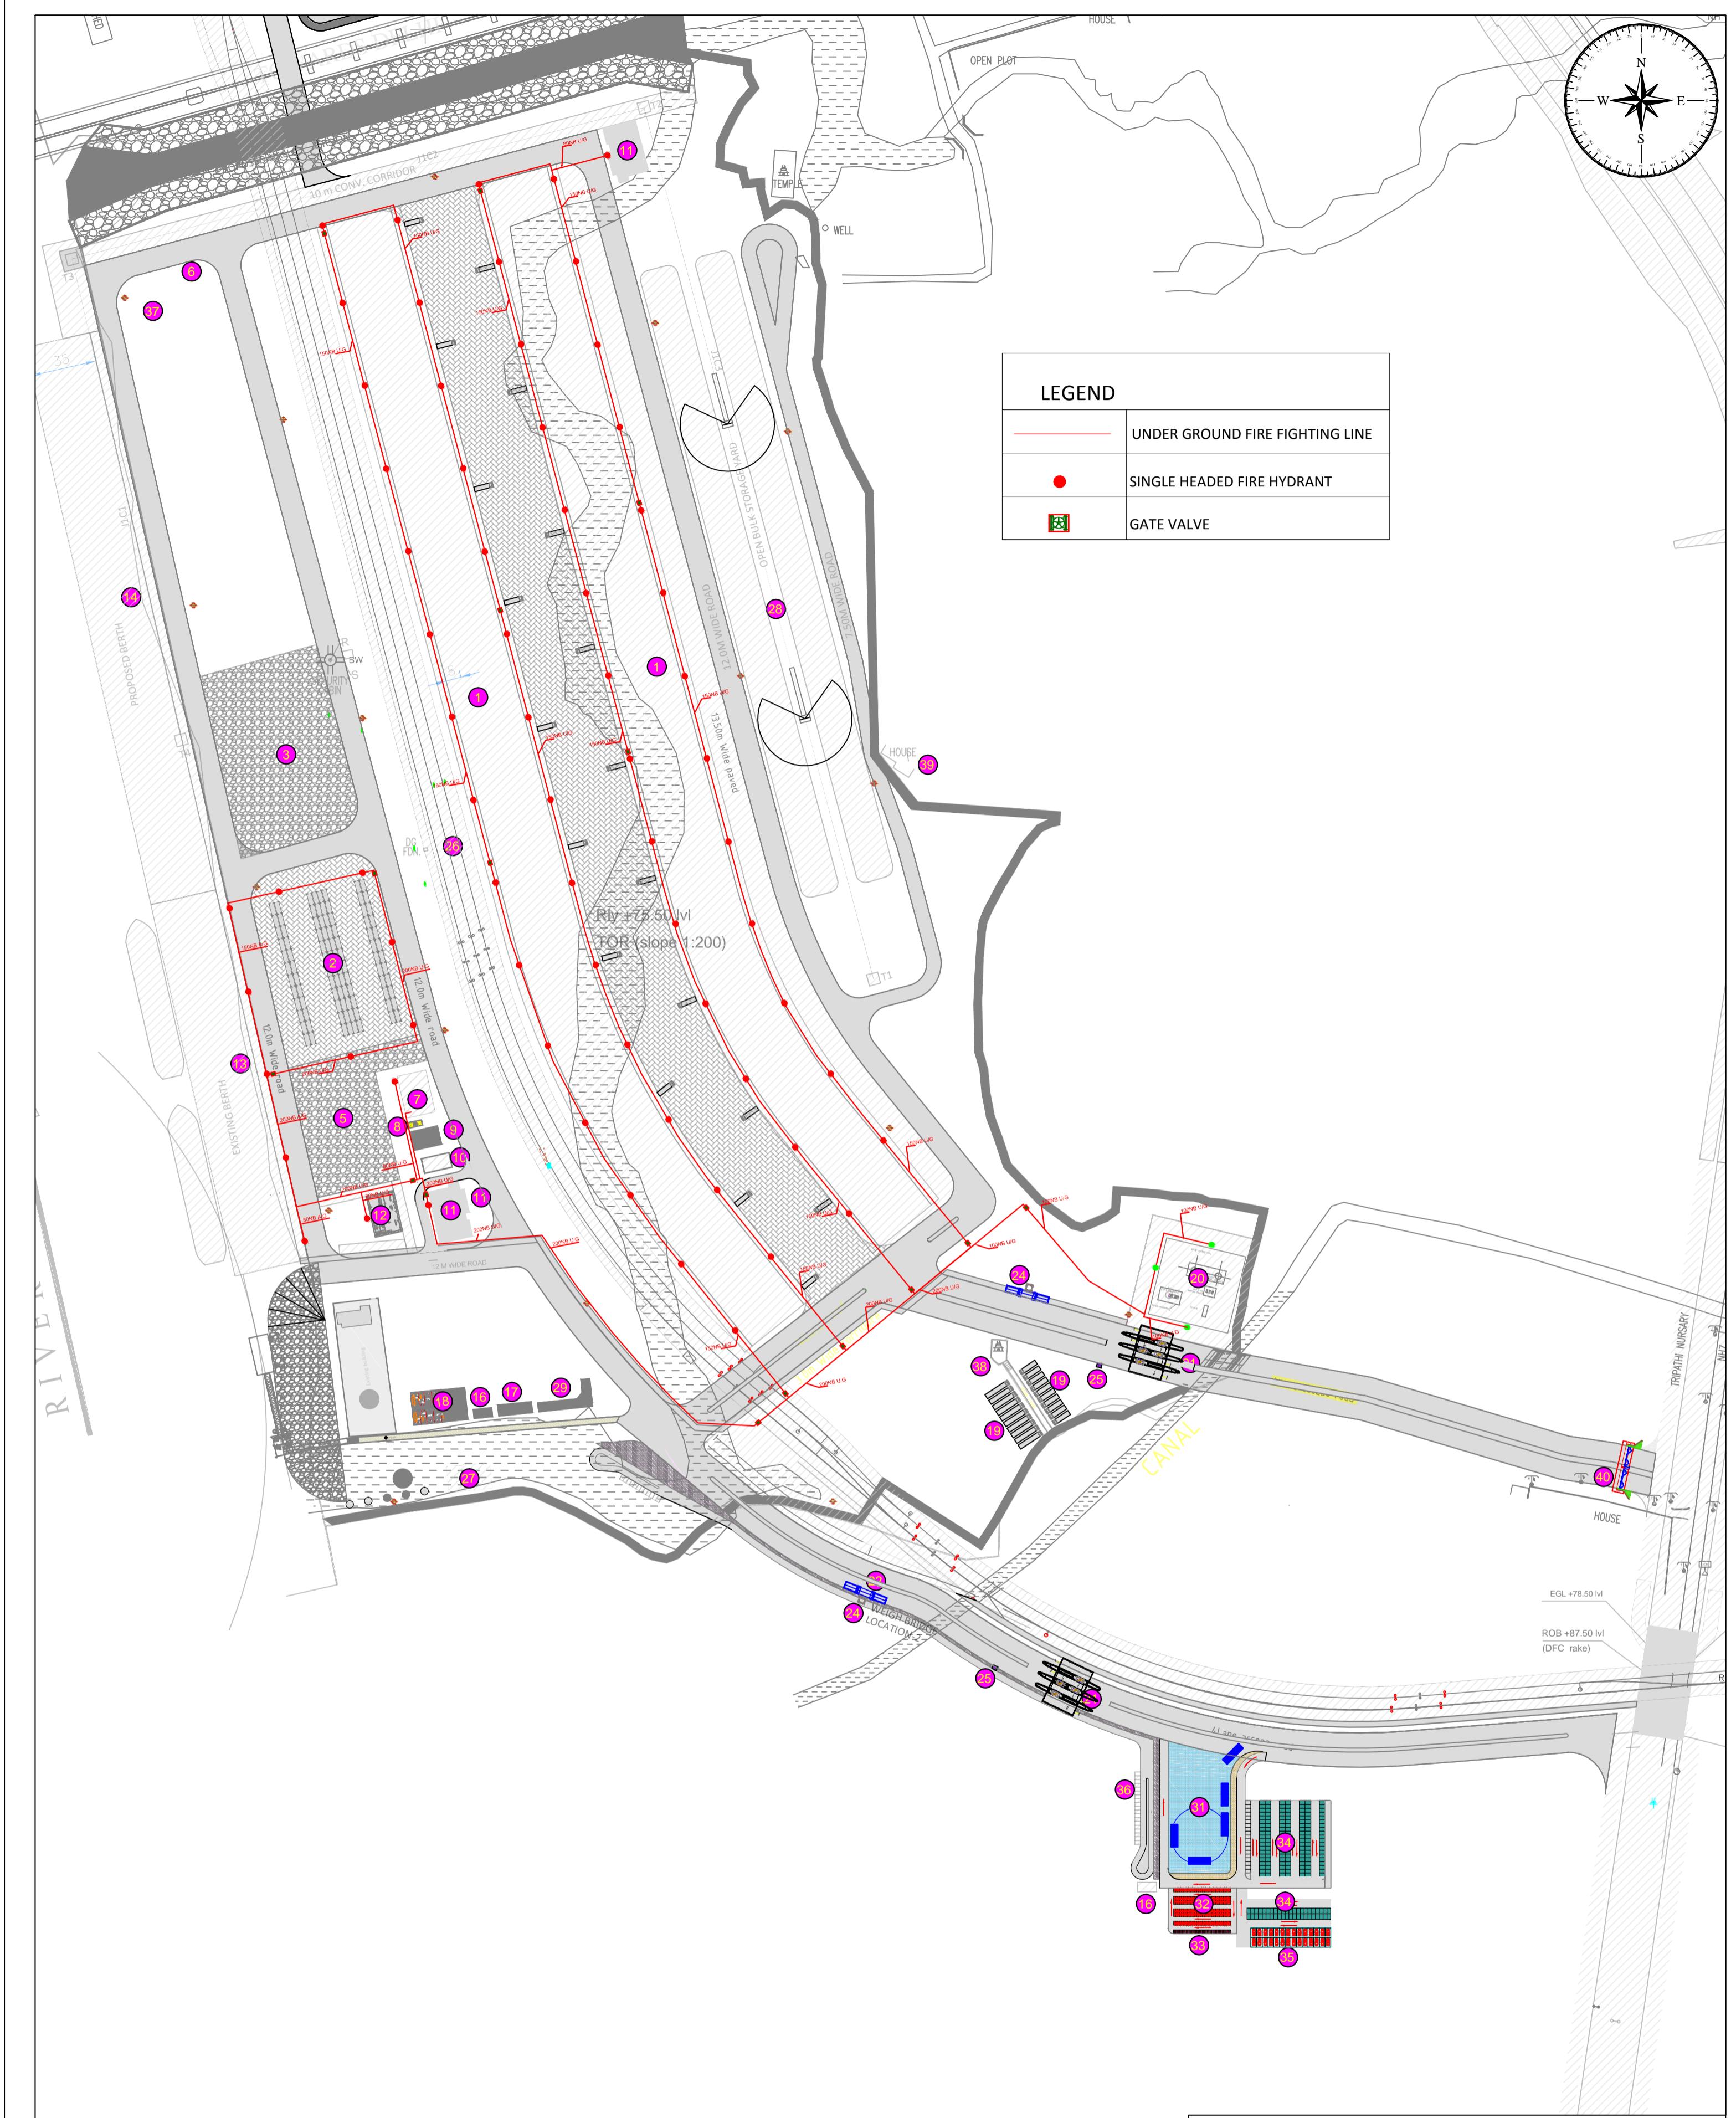
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TIC TANK
ITY
DING JETTY -PHASE-I
STATION
NG
E
C TEMPLE

A cross-sectional diagram of a concrete drain wall. The wall is labeled "R.C.C. DRAIN WALL". A dimension line at the top indicates a width of **0.30**. Another dimension line shows a height of **+75.00** from the base to the top of the wall. A third dimension line shows a height of **+74.50** from the base to an "INVERT LEVEL (VARIES)" indicated by a dashed red horizontal line. The bottom of the wall is supported by a foundation layer labeled "P.C.C. M10 (0.075m THK.)".

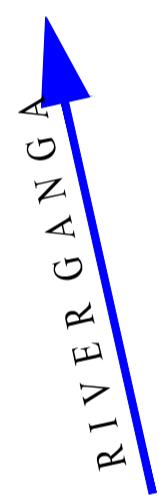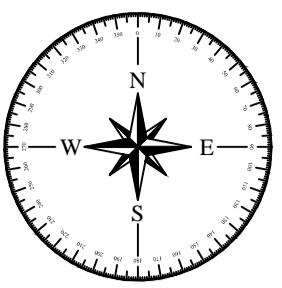TYPICAL DETAIL OF DRAIN

LEGEND

-  OPEN DRAIN
 PIPE DRAIN

NUMIN

PITCHING DRAIN CROSS SECTION

NOTES

1. ALL DIMENSIONS ARE IN METRE
 2. ALL LEVELS ARE IN METRE & ARE WITH RESPECT TO MSL

INLAND WATERWAYS AUTHORITY OF INDIA

PROJECT DETAILED FEASIBILITY STUDY FOR CAPACITY AUGMENTATION OF NATIONAL WATERWAY-1 AND DETAILED ENGINEERING FOR ITS ANCILLARY WORKS AND PROCESS, BETWEEN HAMBIA TO ALI MAHAD (HALYKAS PROJECT)


AND PROCESS BETWEEN HALDIA TO ALLAHABAD (JAL VIKAS PROJECT)					
CONSULTANT	 PMC PROJECTS (INDIA) PRIVATE LIMITED <small>from vision to reality</small>	NAME		SIGN	DATE
		DRN	VAP		25/09/17
		CHD	AVL		25/09/17

RECEIPT BETWEEN HALDIA TO ALLAHABAD (JAL VIKAS PROJECT)


	 HOWE	from vision to reality...	GHD	...	25/09/17
			APD	S2	25/09/17
TITLE	IWT TERMINAL AT VARANASI	JOB. NO.	DRG. NO.		

LAYOUT OF STORM WATER SYSTEM IN PHASE-1A I-525 VTR-225

D E N	COORDINATE SYSTEM USED: ENTER CO-ORD SYSTEM HERE				
	UNIT	SCALE - AS SHOWN	Size : A1	REV.	0

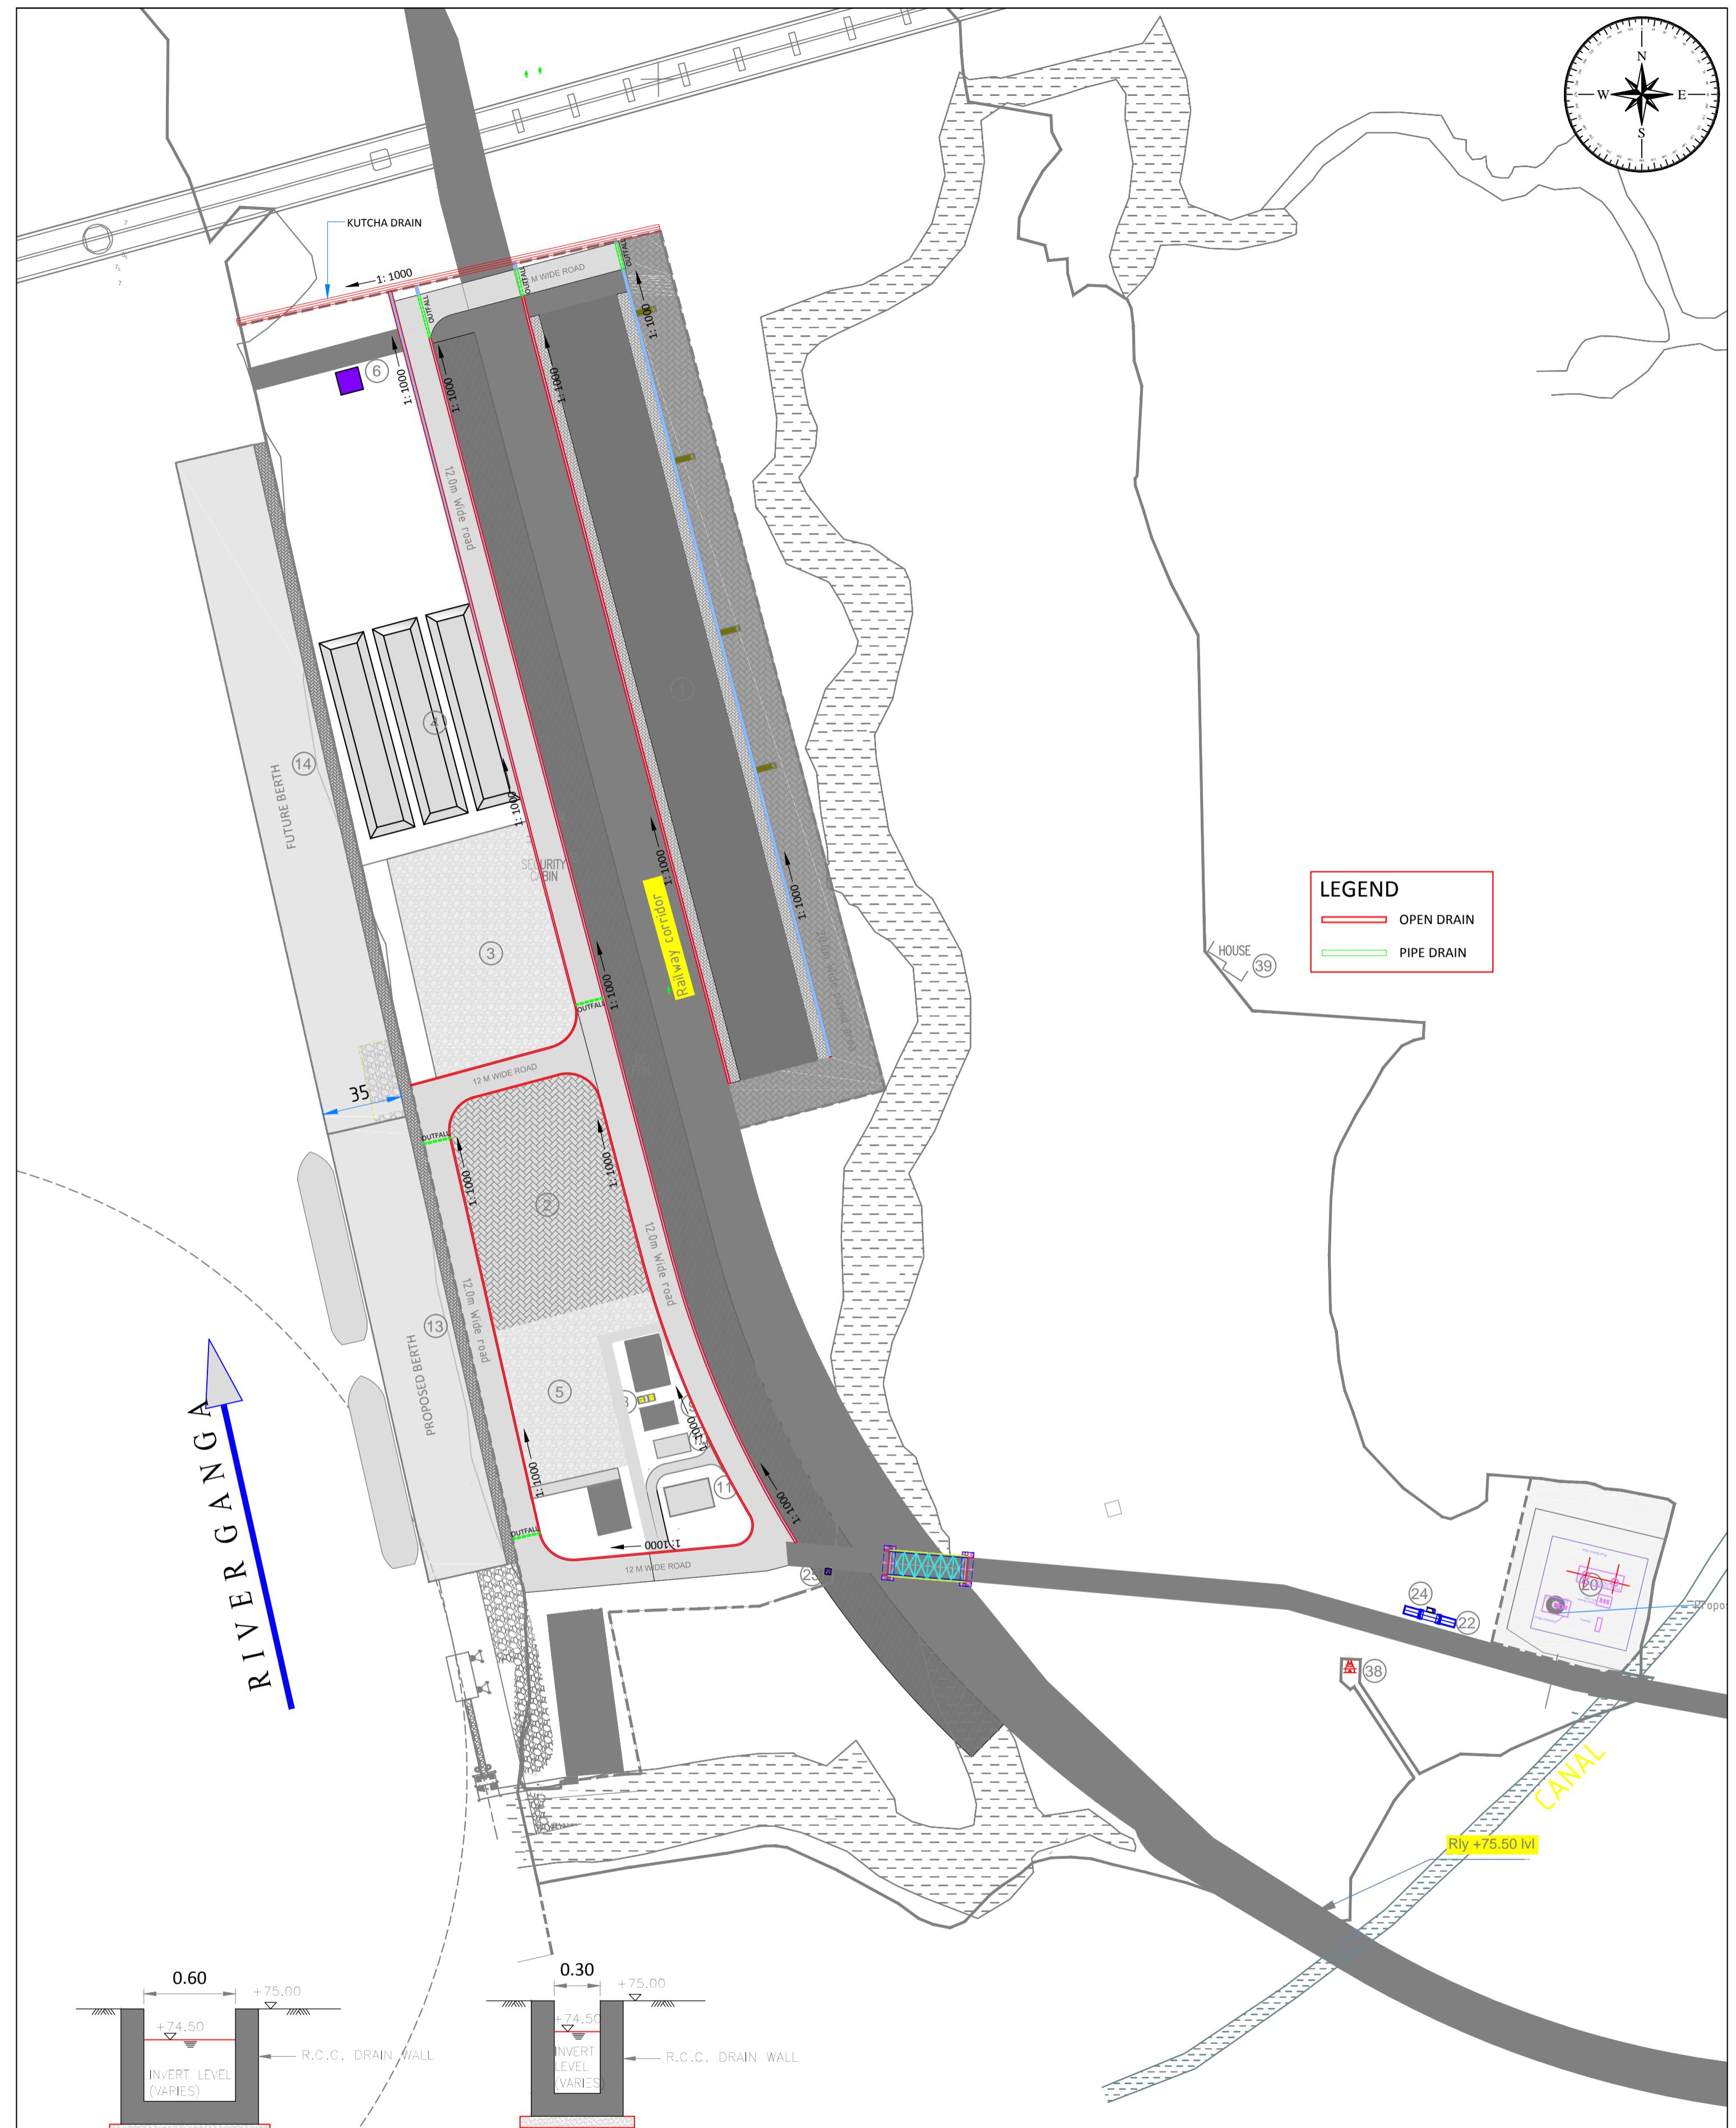

TYPICAL DETAIL OF DRAIN

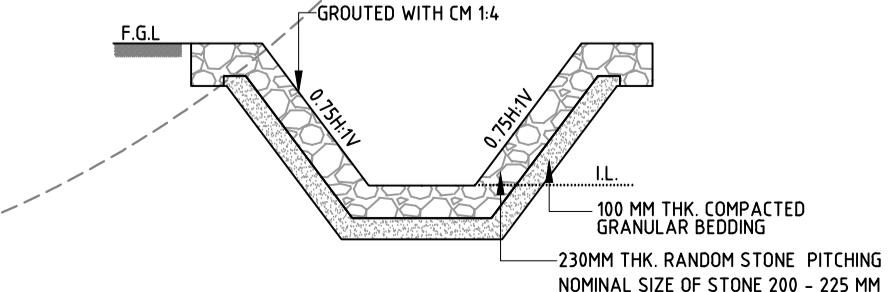

PITCHING DRAIN CROSS SECTION

NOTE:- FOR INVERT LEVEL REF. LAYOUT DRAWING

TYPICAL DETAIL OF DRAIN

NOTES

1. ALL DIMENSIONS ARE IN METRE

2. ALL LEVELS ARE IN METRE & ARE WITH RESPECT TO MSL

REV. 27/09/17

DATE

27/09/17

DESCRIPTION

V+F

AJ

S

DRN CHD APD

REV.

0

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INLAND WATERWAYS AUTHORITY OF INDIA

PROJECT

DETAILED FEASIBILITY STUDY FOR CAPACITY AUGMENTATION OF NATIONAL
WATERWAY-1 AND DETAILED ENGINEERING FOR ITS ANCILLARY WORKS
AND PROCESS BETWEEN HALDIA TO ALLAHABAD (JAL VIKAS PROJECT)

CONSULTANT

PMC PROJECTS
INDIA PRIVATE LIMITED
from vision to reality...
HOWE

NAME

SIGN

DATE

DRN

V+F

25/09/17

CHD

AJ

25/09/17

APD

SJ

25/09/17

TITLE

IWT TERMINAL AT VARANASI

JOB. NO.

I-525

DRG. NO.

VTR-226

COORDINATE SYSTEM USED:




ENTER CO-ORD SYSTEM HERE

UNIT

SCALE - AS SHOWN

Size : A1


REV. 0

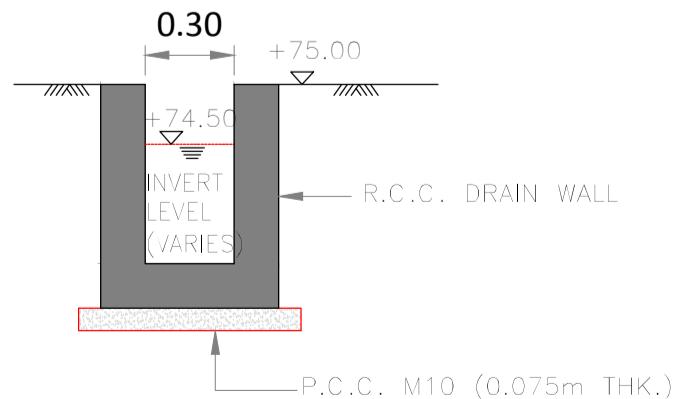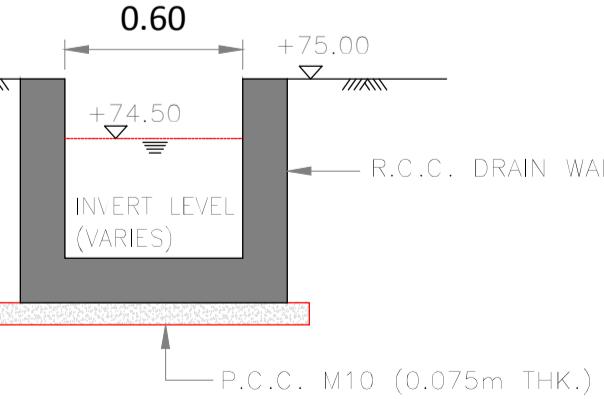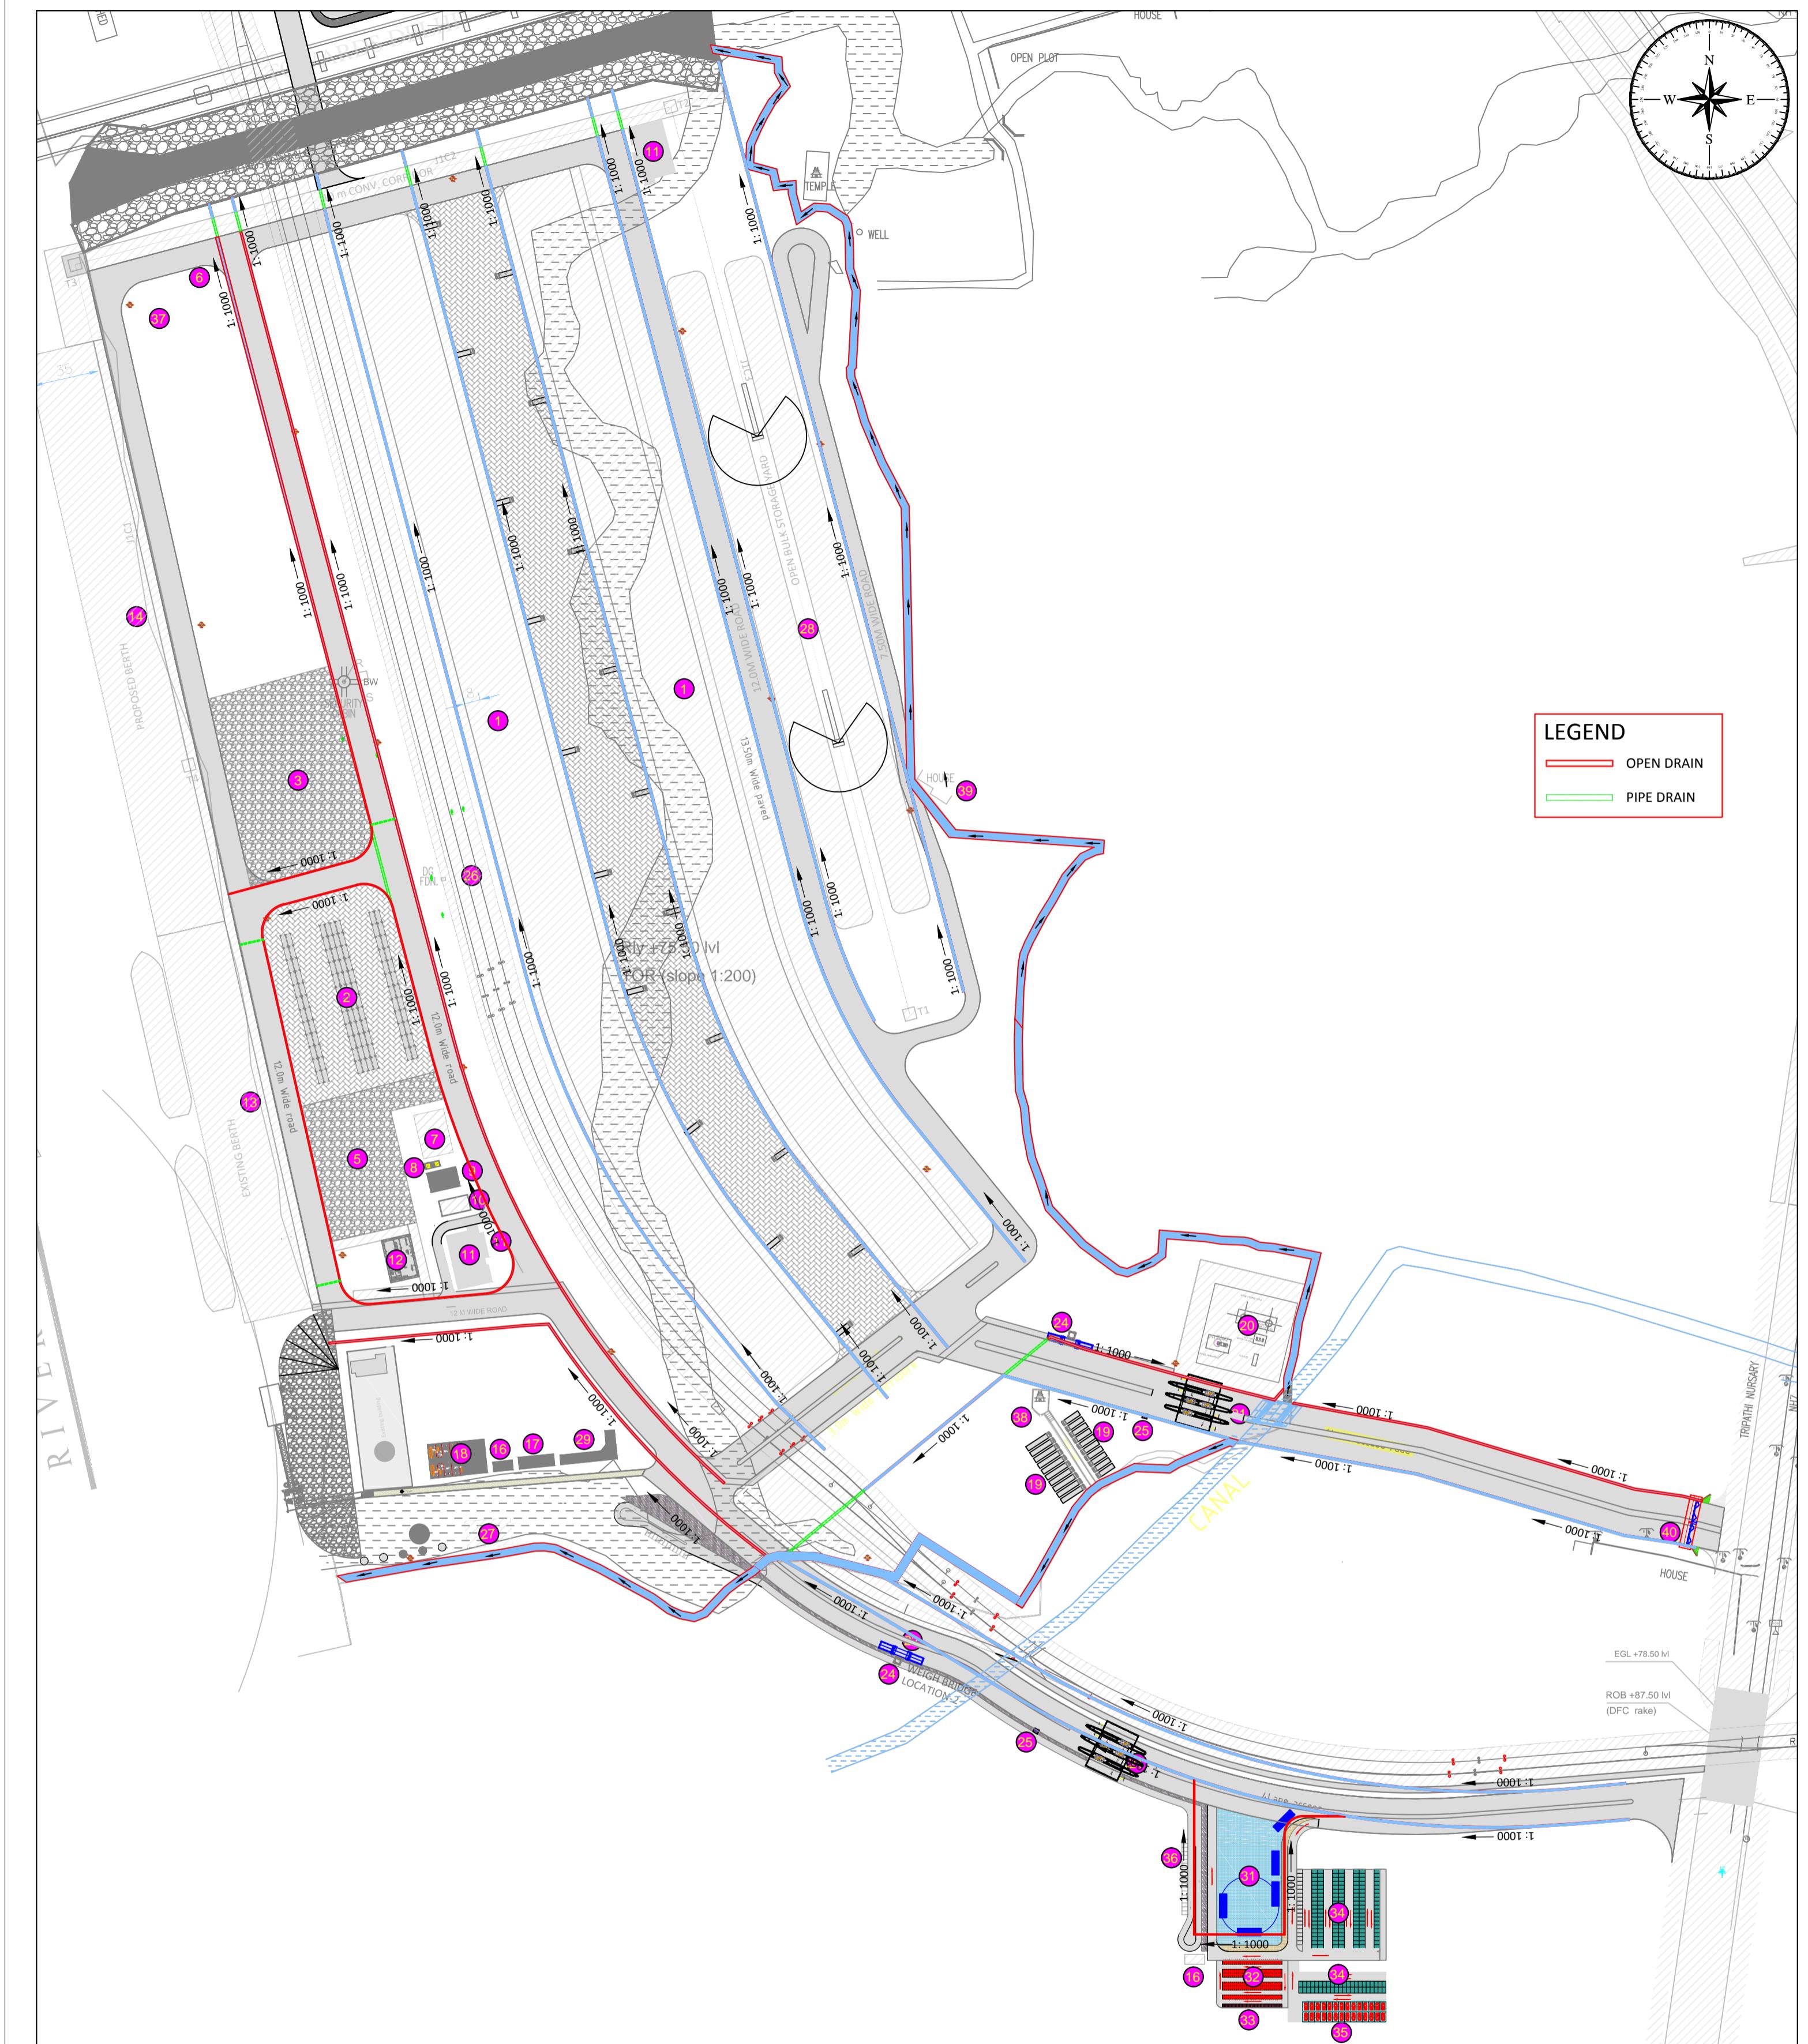


TYPICAL DETAIL OF DRAIN

TYPICAL DETAIL OF DRAIN

REV.	DATE	DESCRIPTION	DRN	CHD	APD
27/09/17		V+F A/J S			
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HOWE					
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COORDINATE SYSTEM USED: ENTER CO-ORD SYSTEM HERE					
		UNIT	SCALE - AS SHOWN		Size : A1
					REV. 0

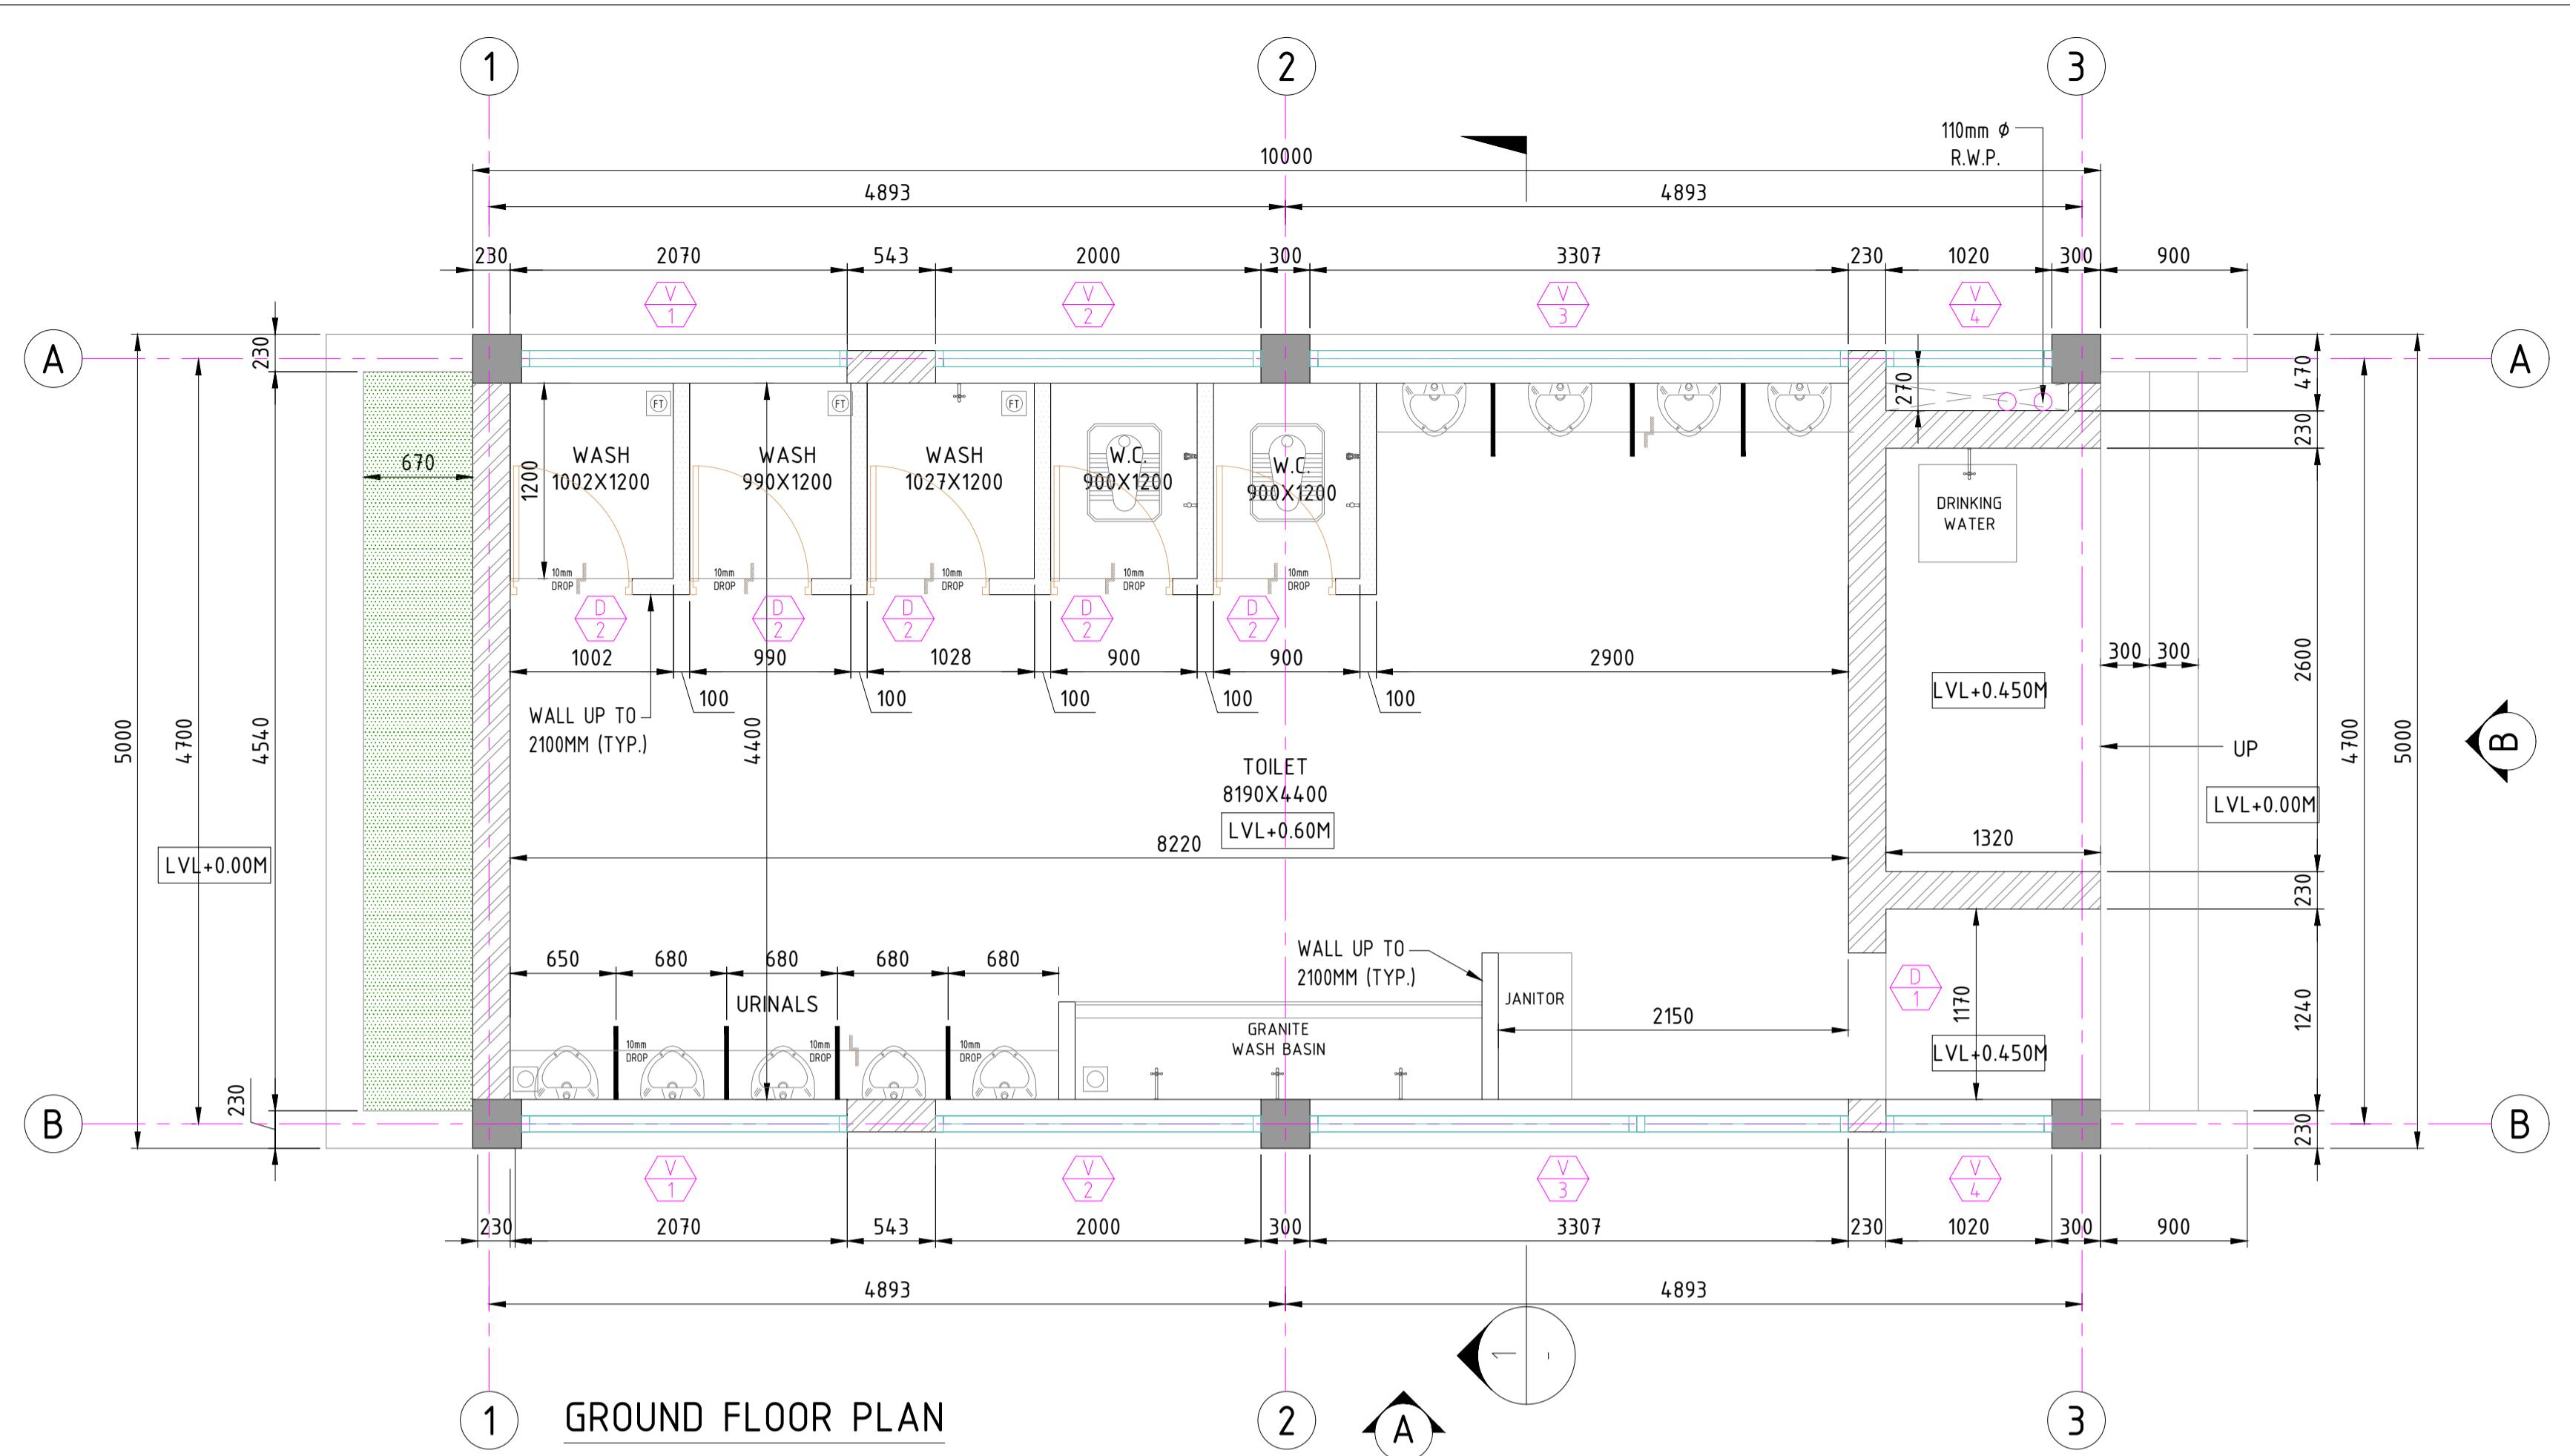

DOOR WINDOW OPENING SCHEDULE					
NO.	SIZE	SILL	LINTEL	NOS.	REMARK
DOOR					
D1	900X2100	-	2100	01	
D2	750X2100	-	2100	05	
WINDOW *					
V/1	2000X500	2200	2700	02	
V/2	2000X500	2200	2700	02	
V/3	3300X500	2200	2700	02	
V/4	1020X500	2200	2700	02	

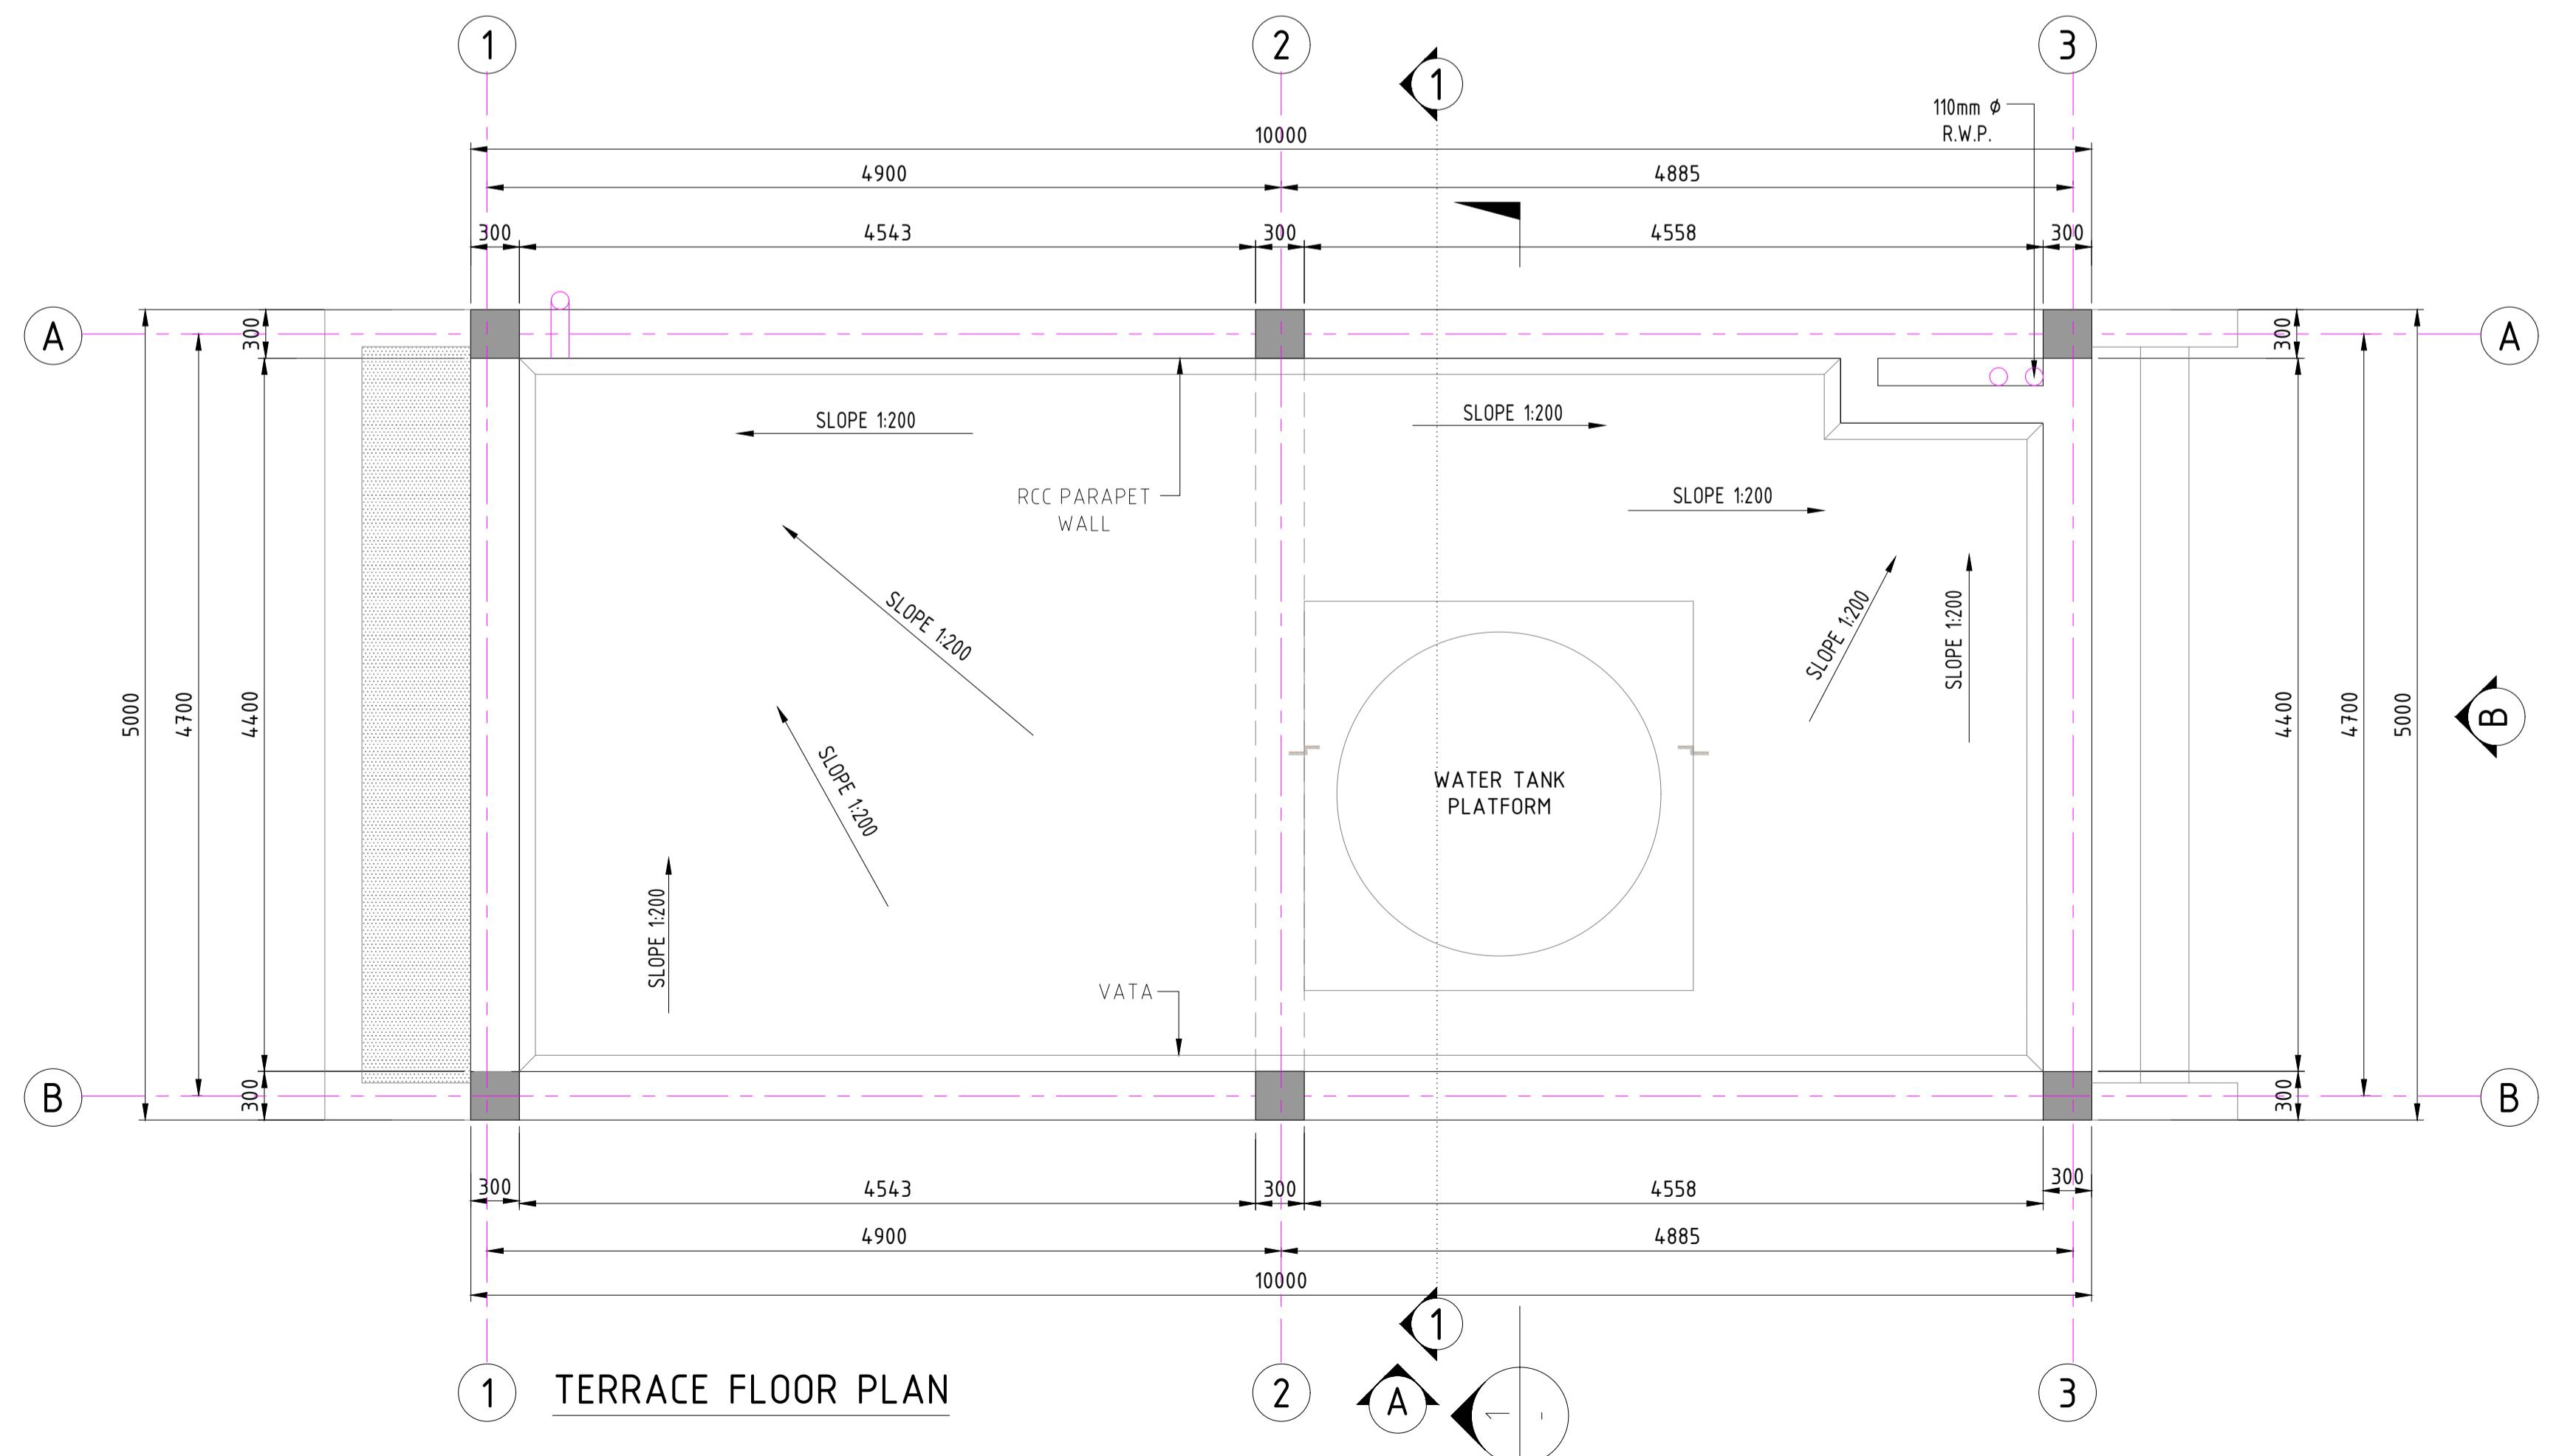

NOTES

1. ALL DIMENSIONS ARE IN MILLIMETRE
 2. ALL LEVELS ARE IN METRE & ARE WITH RESPECT TO MSL

LAND WATERWAYS AUTHORITY OF INDIA

PROJECT DETAILED FEASIBILITY STUDY FOR CAPACITY AUGMENTATION OF NATIONAL WATERWAY-1 AND DETAILED ENGINEERING FOR ITS ANCILLARY WORKS AND PROCESS BETWEEN HALDIA TO ALLAHABAD (JAL VIKAS PROJECT)

AND PROCESS BETWEEN HALDIA TO ALLAHABAD (JAL VIKAS PROJECT)

		PMC PROJECTS <u>(INDIA)PRIVATE LIMITED</u> from vision to reality...		
DRN	VAP		25/09/11	
CHD	AM		25/09/11	
APD	SP		25/09/11	

TITLE	IWT TERMINAL AT VARANASI LAYOUT OF TOILET BLOCK	JOB. NO.	DRG. NO.
		I-525	VTR-228


SHEET 1 OF 2

COORDINATE SYSTEM USED:
ENTER CO-ORD SYSTEM HERE


	UNIT	SCALE AS SHOWN	Size : A1	REV	0
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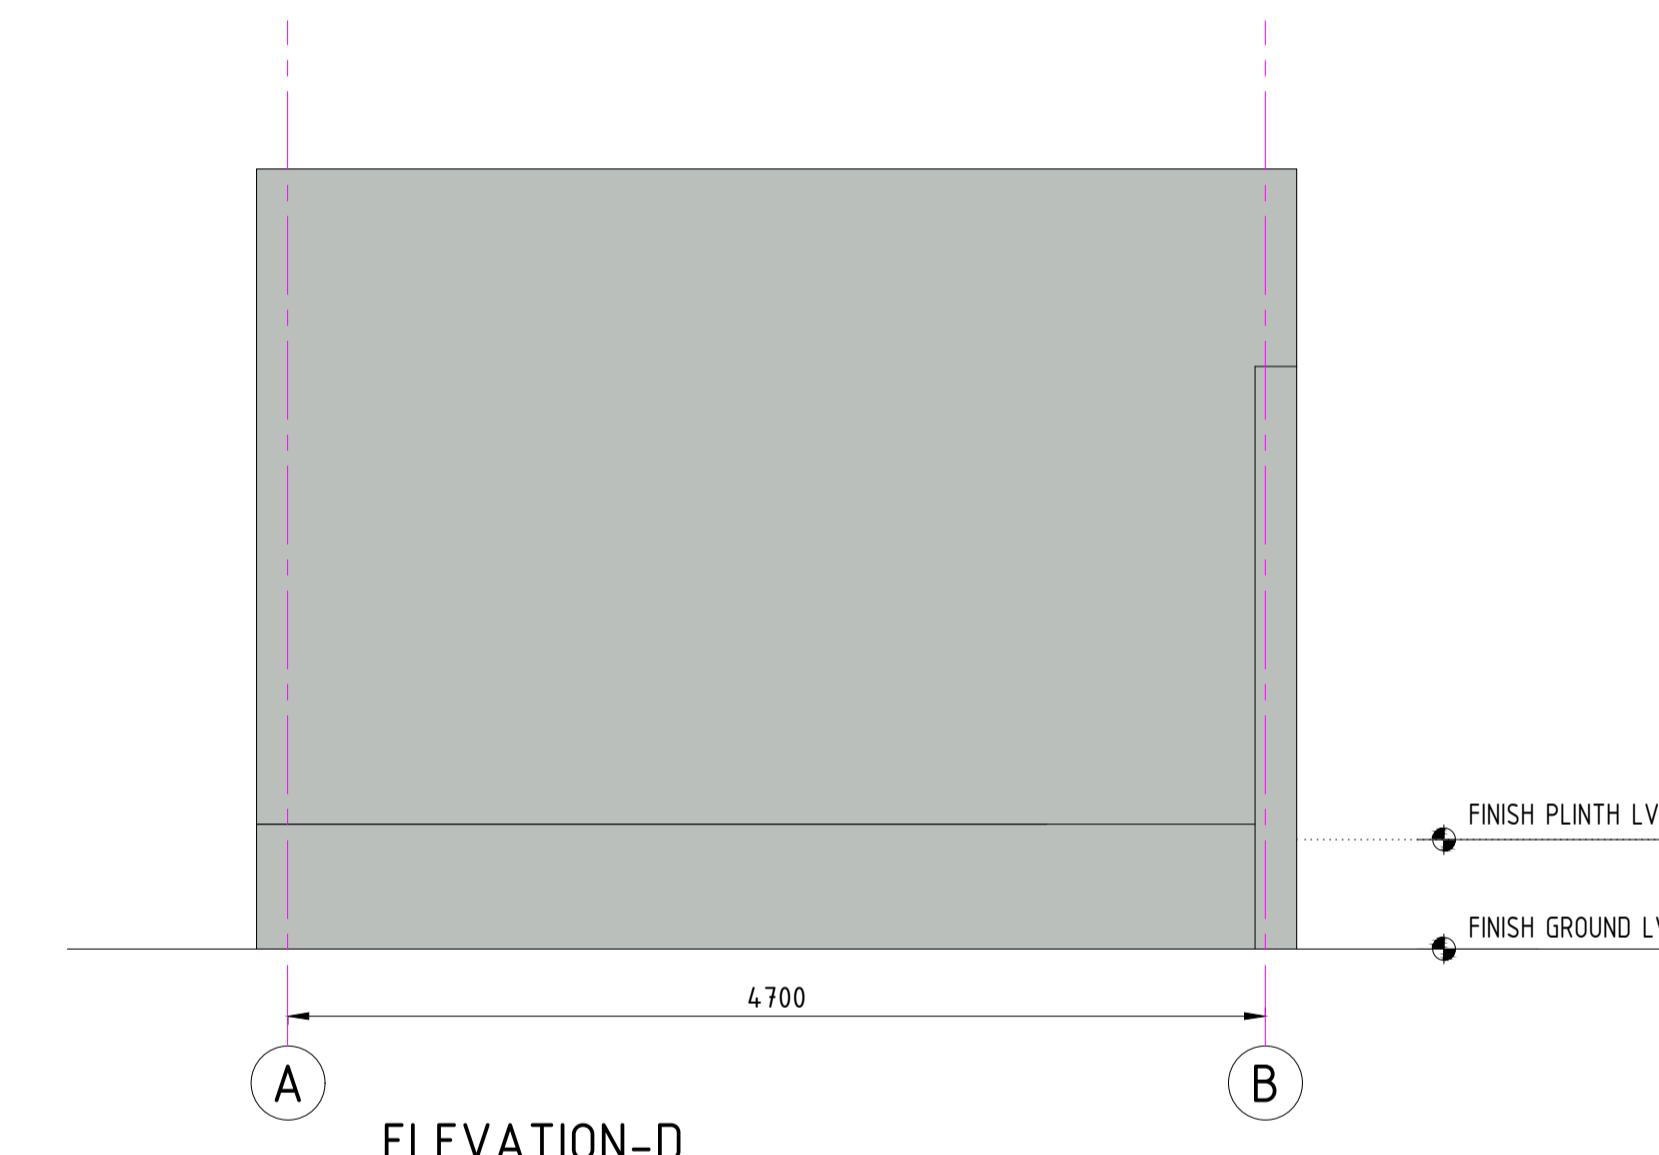
ELEVATION-A




ELEVATION.

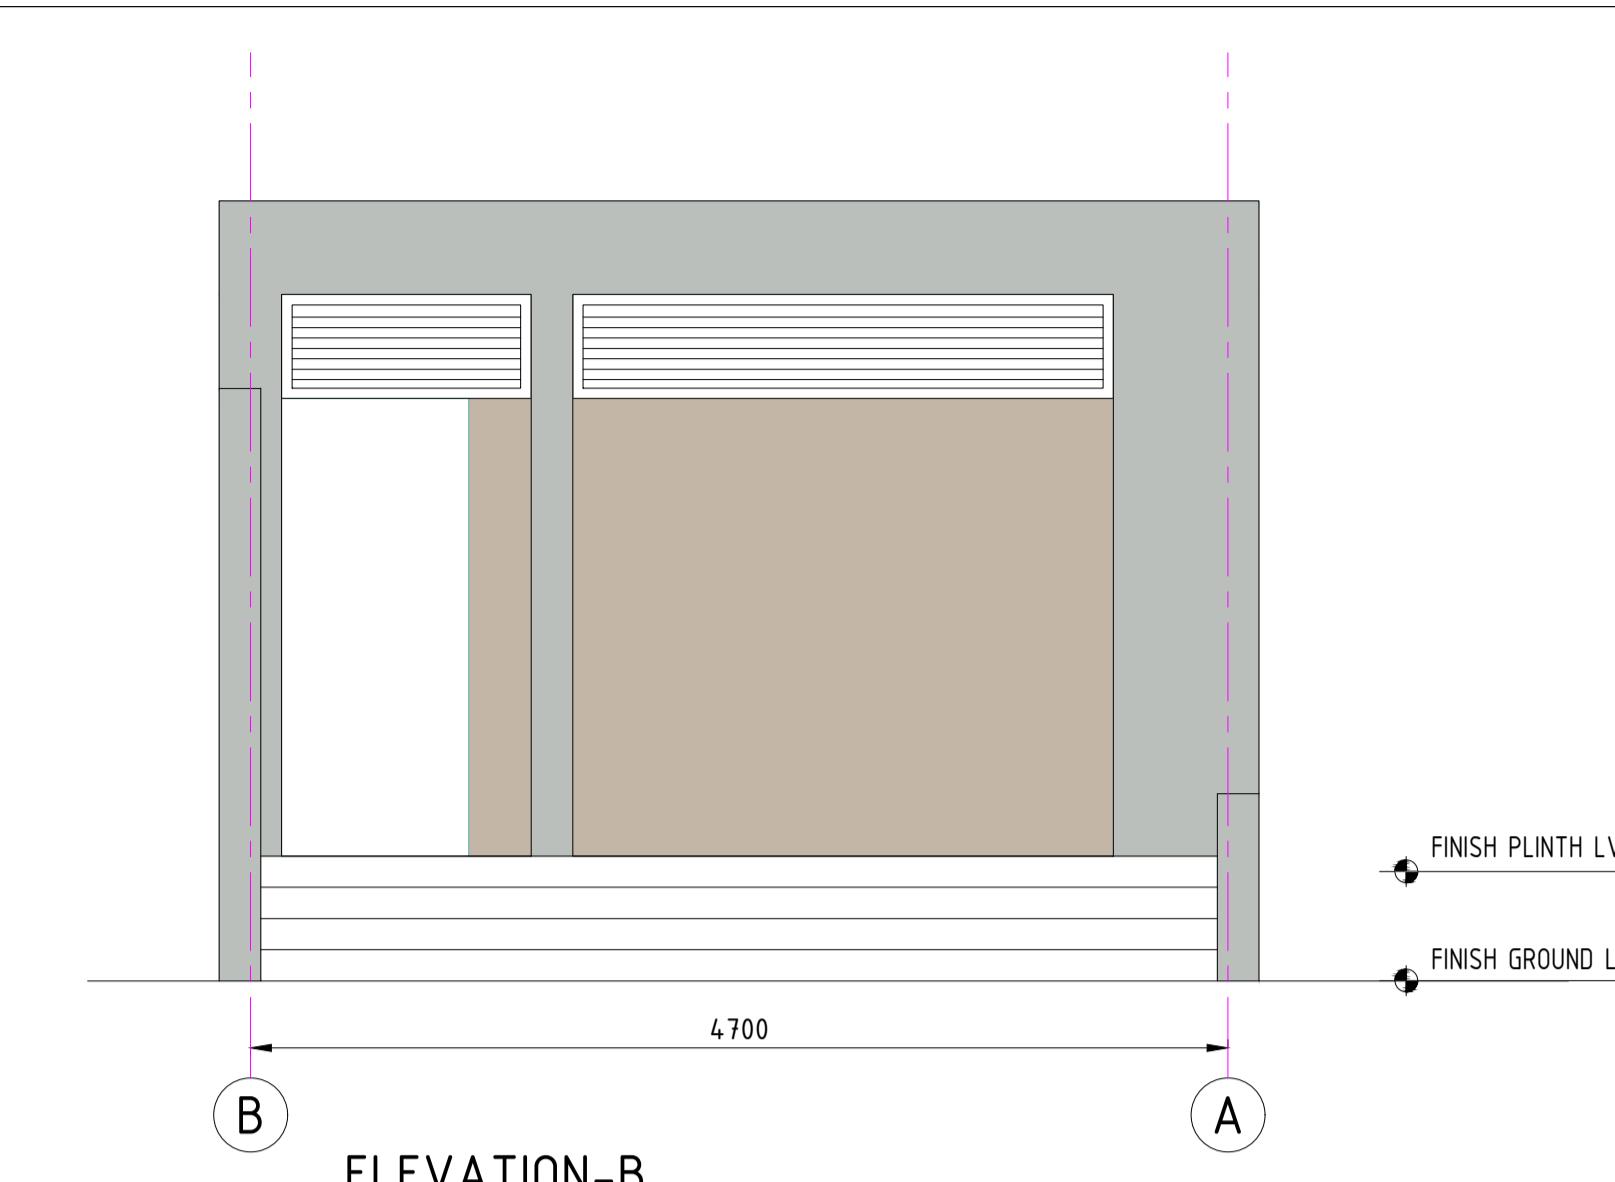

ELEVATION-0

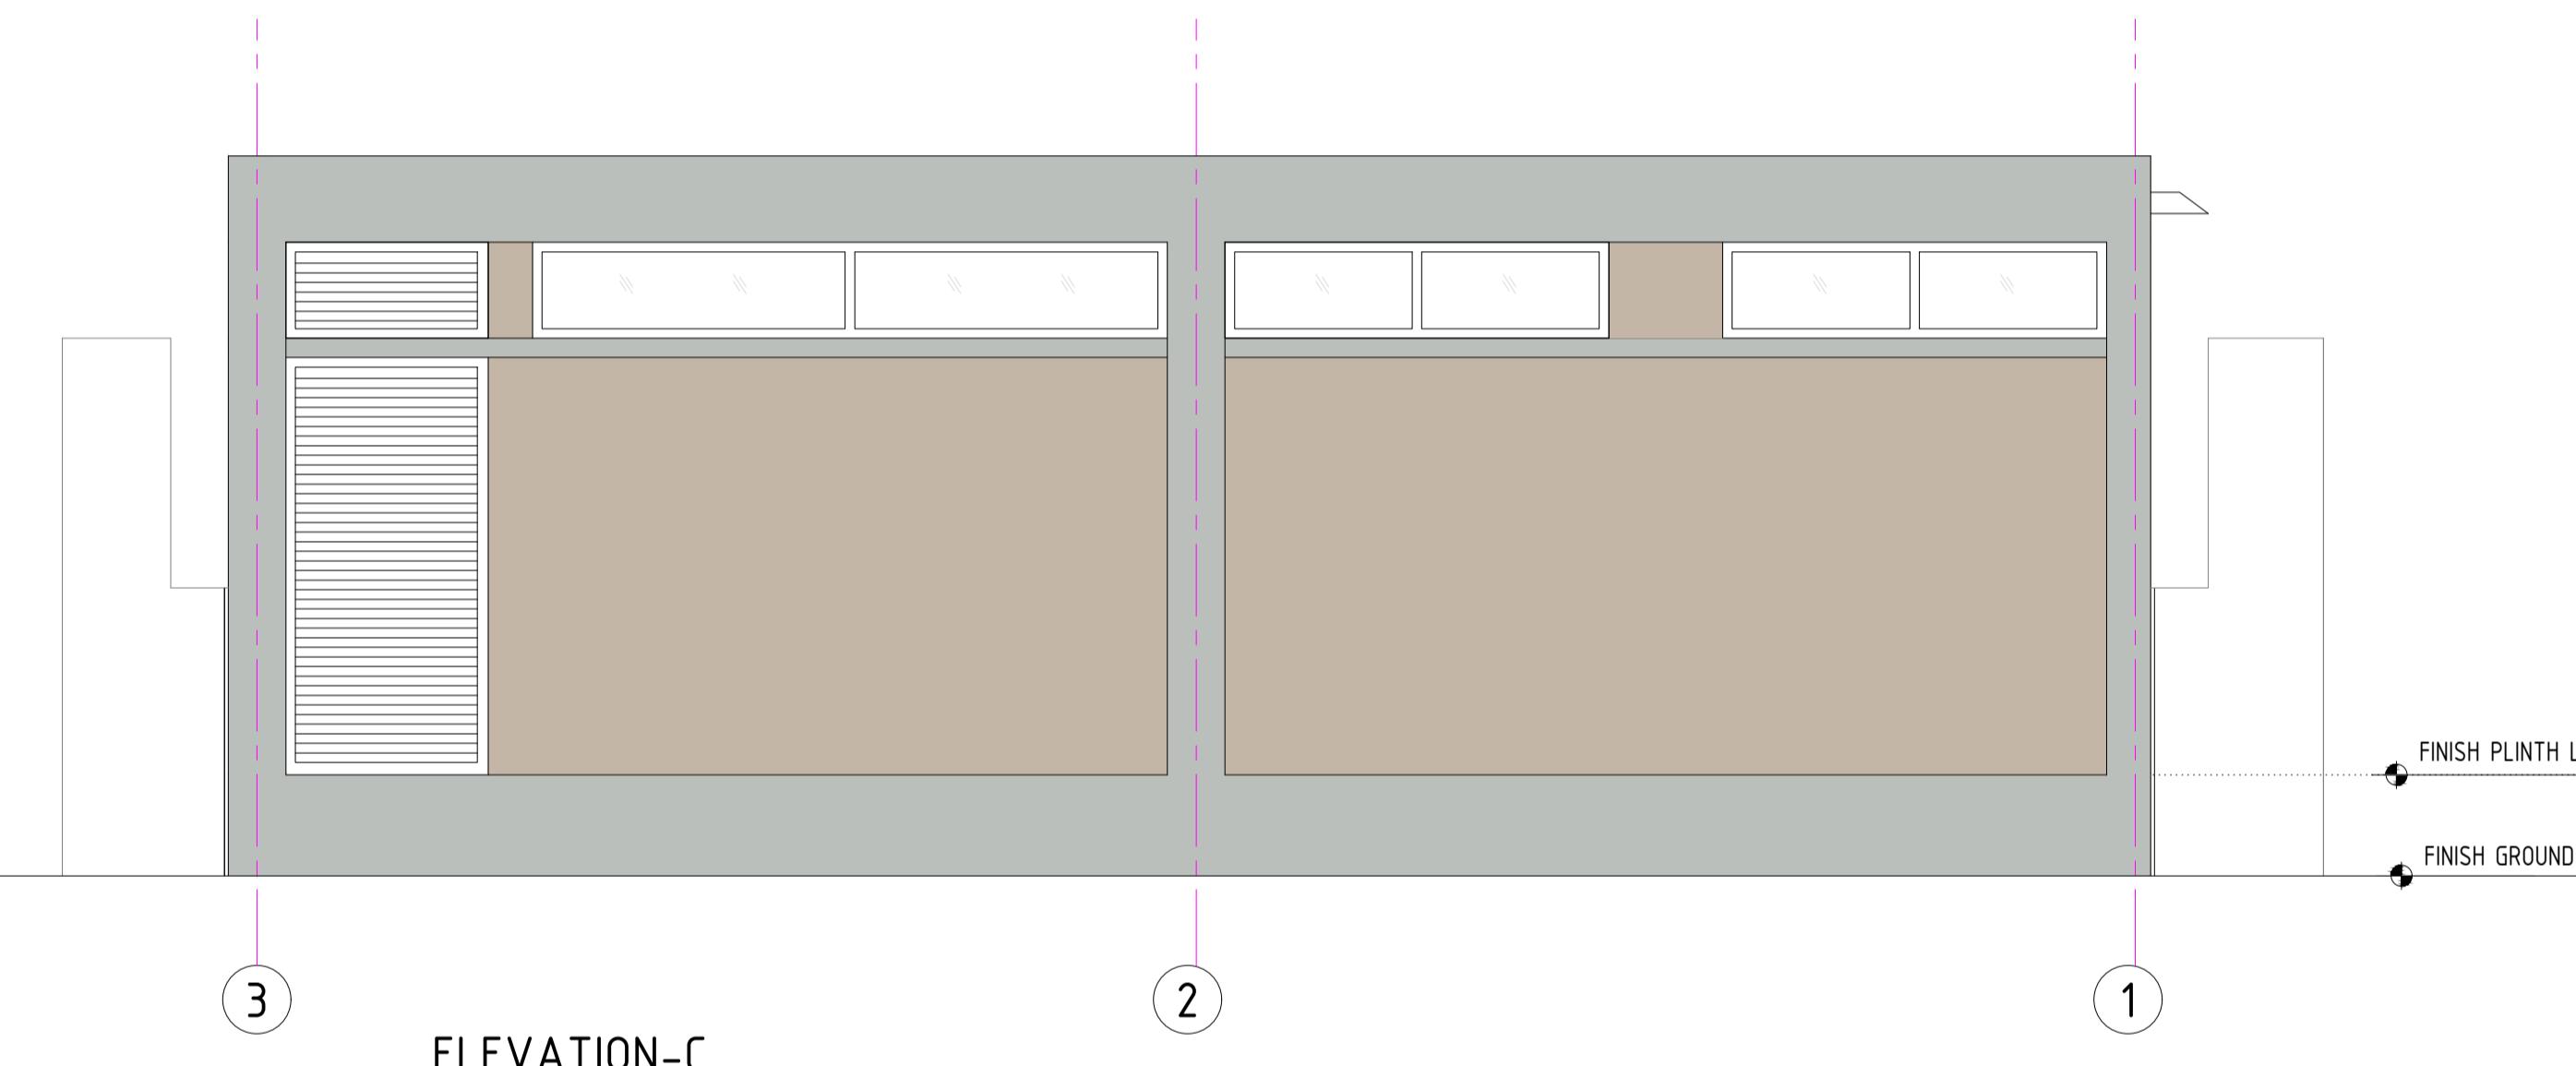

ELEVATION

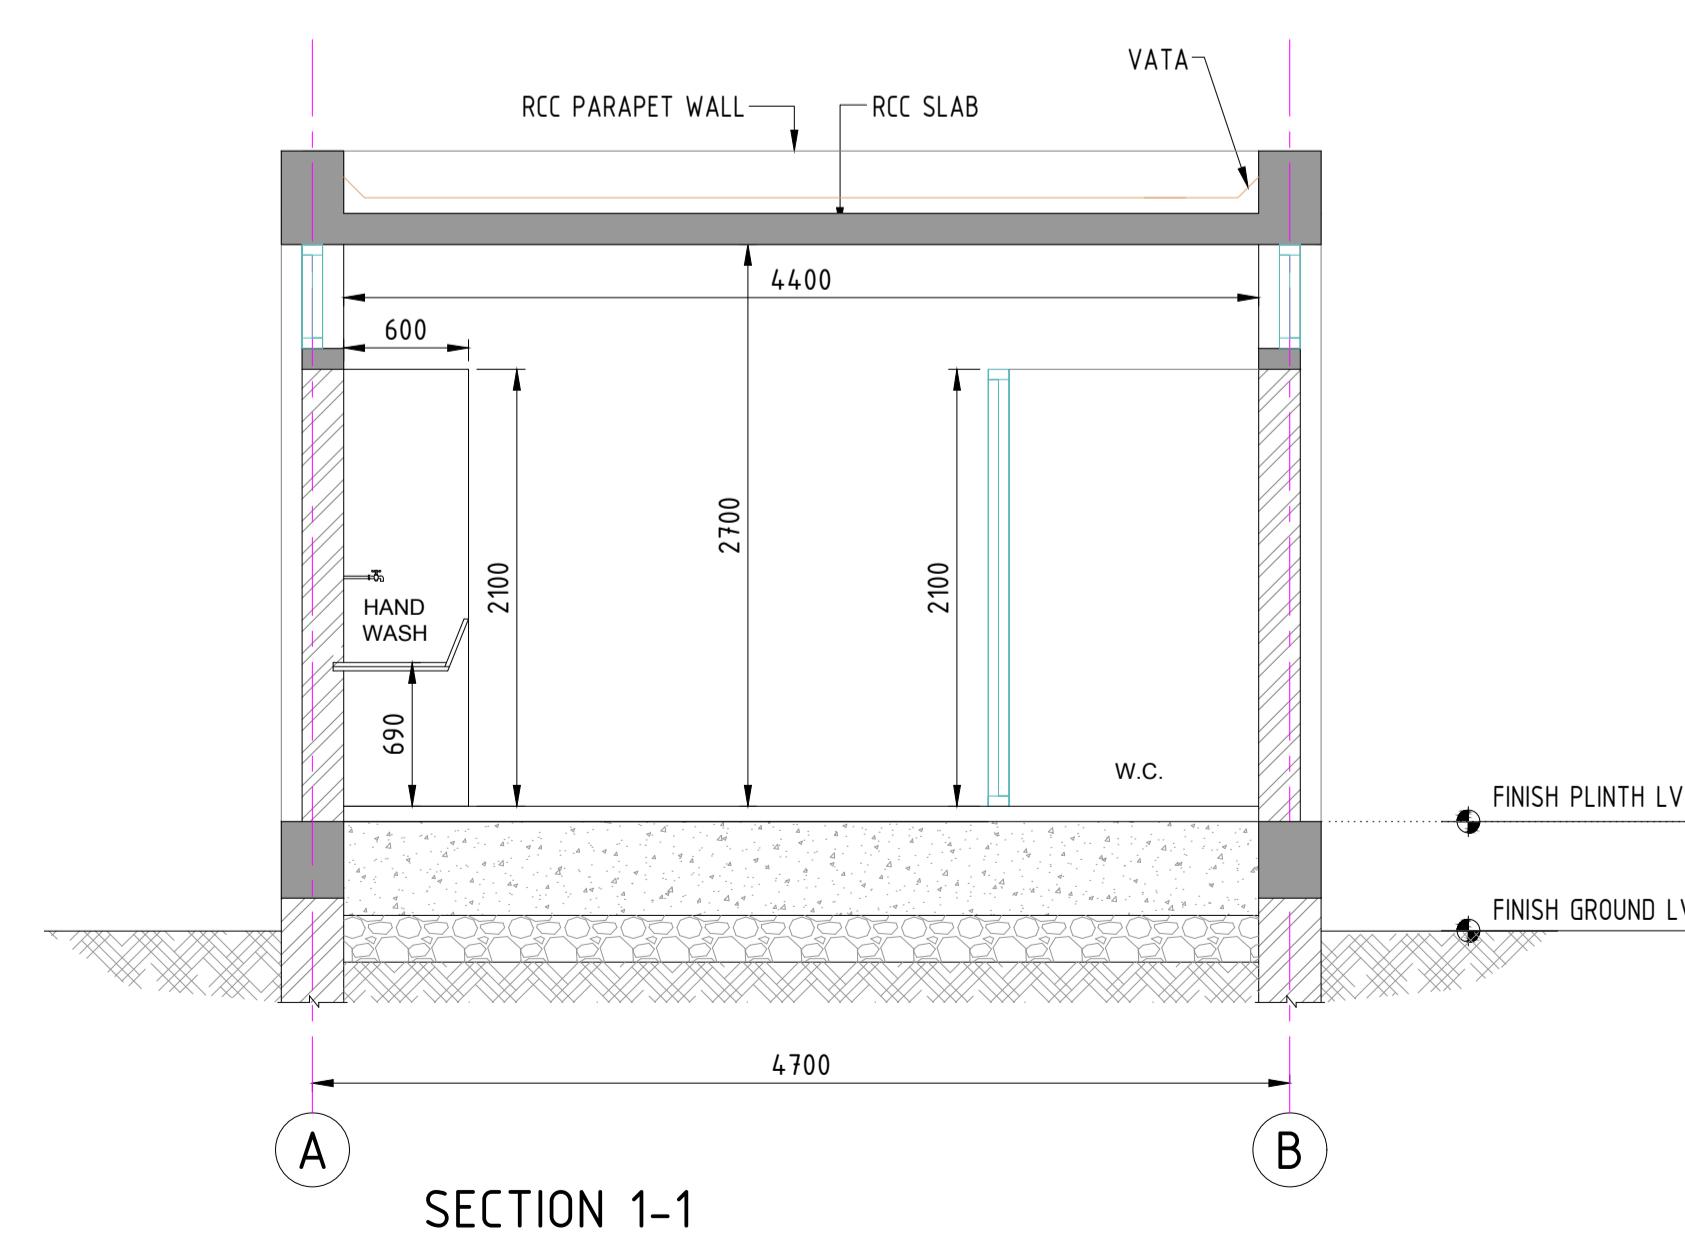

SECTION 1-1

NOTES

- 1. ALL DIMENSIONS ARE IN MILLIMETRE
 2. ALL LEVELS ARE IN METRE & ARE WITH RESPECT TO MSL



INLAND WATERWAYS AUTHORITY OF INDIA



PROJECT DETAILED FEASIBILITY STUDY FOR CAPACITY AUGMENTATION OF NATIONAL WATERWAY-1 AND DETAILED ENGINEERING FOR ITS ANCILLARY WORKS AND PROCESS, BETWEEN HALDIA TO ALLAHABAD (HAL VIKAS PROJECT)

AND PROCESS BETWEEN HALDIA TO ALLAHABAD (JAL VIKAS PROJECT)						
CONSULTANT	 HOWE	 PMC PROJECTS <small>(INDIA) PRIVATE LIMITED</small> from vision to reality...	NAME		SIGN	DATE
			DRN	VAP		25/09/17
			CHD	AM		25/09/17

	NAME	APD	SP	DATE
TITLE	IWT TERMINAL AT VARANASI	JOB. NO.	DRG. NO.	
	ELEVATION OF TOILET BLOCK	I-525	VTR-228	SHEET 2 OF 2

COORDINATE SYSTEM USED:

0	25/09/17		VAP	AM	
REV	DATE	DESCRIPTION	DRN	CHD	A

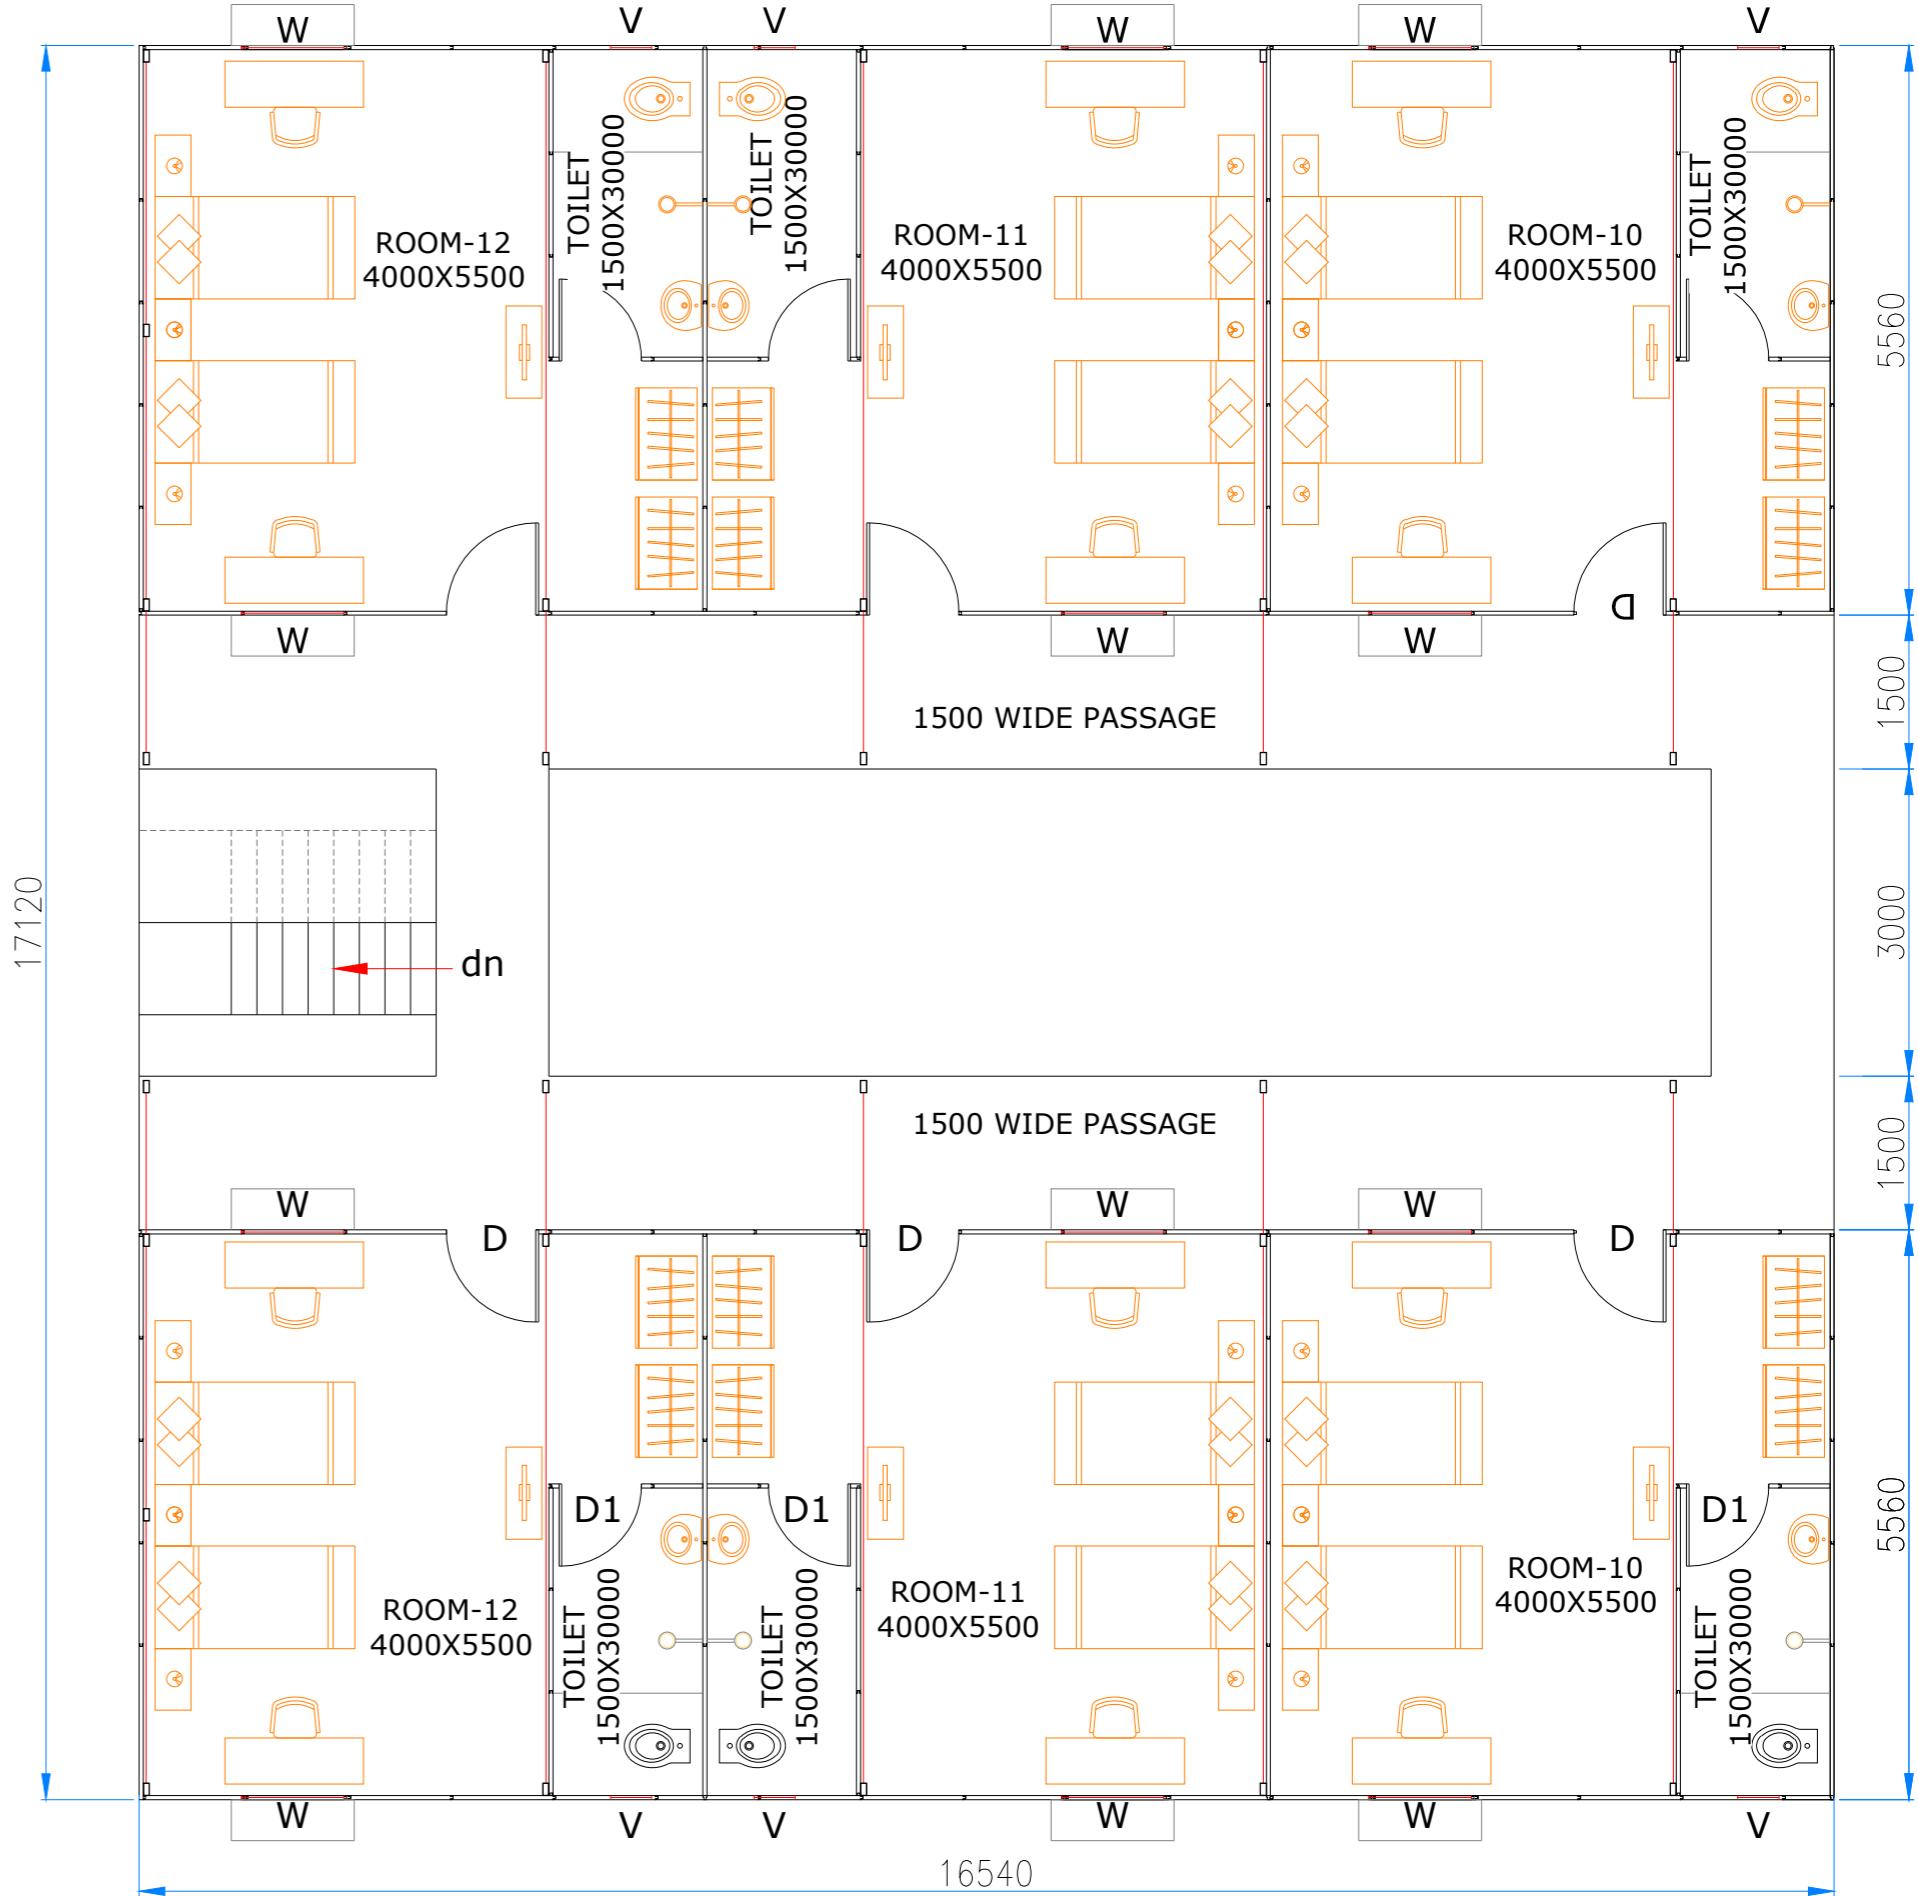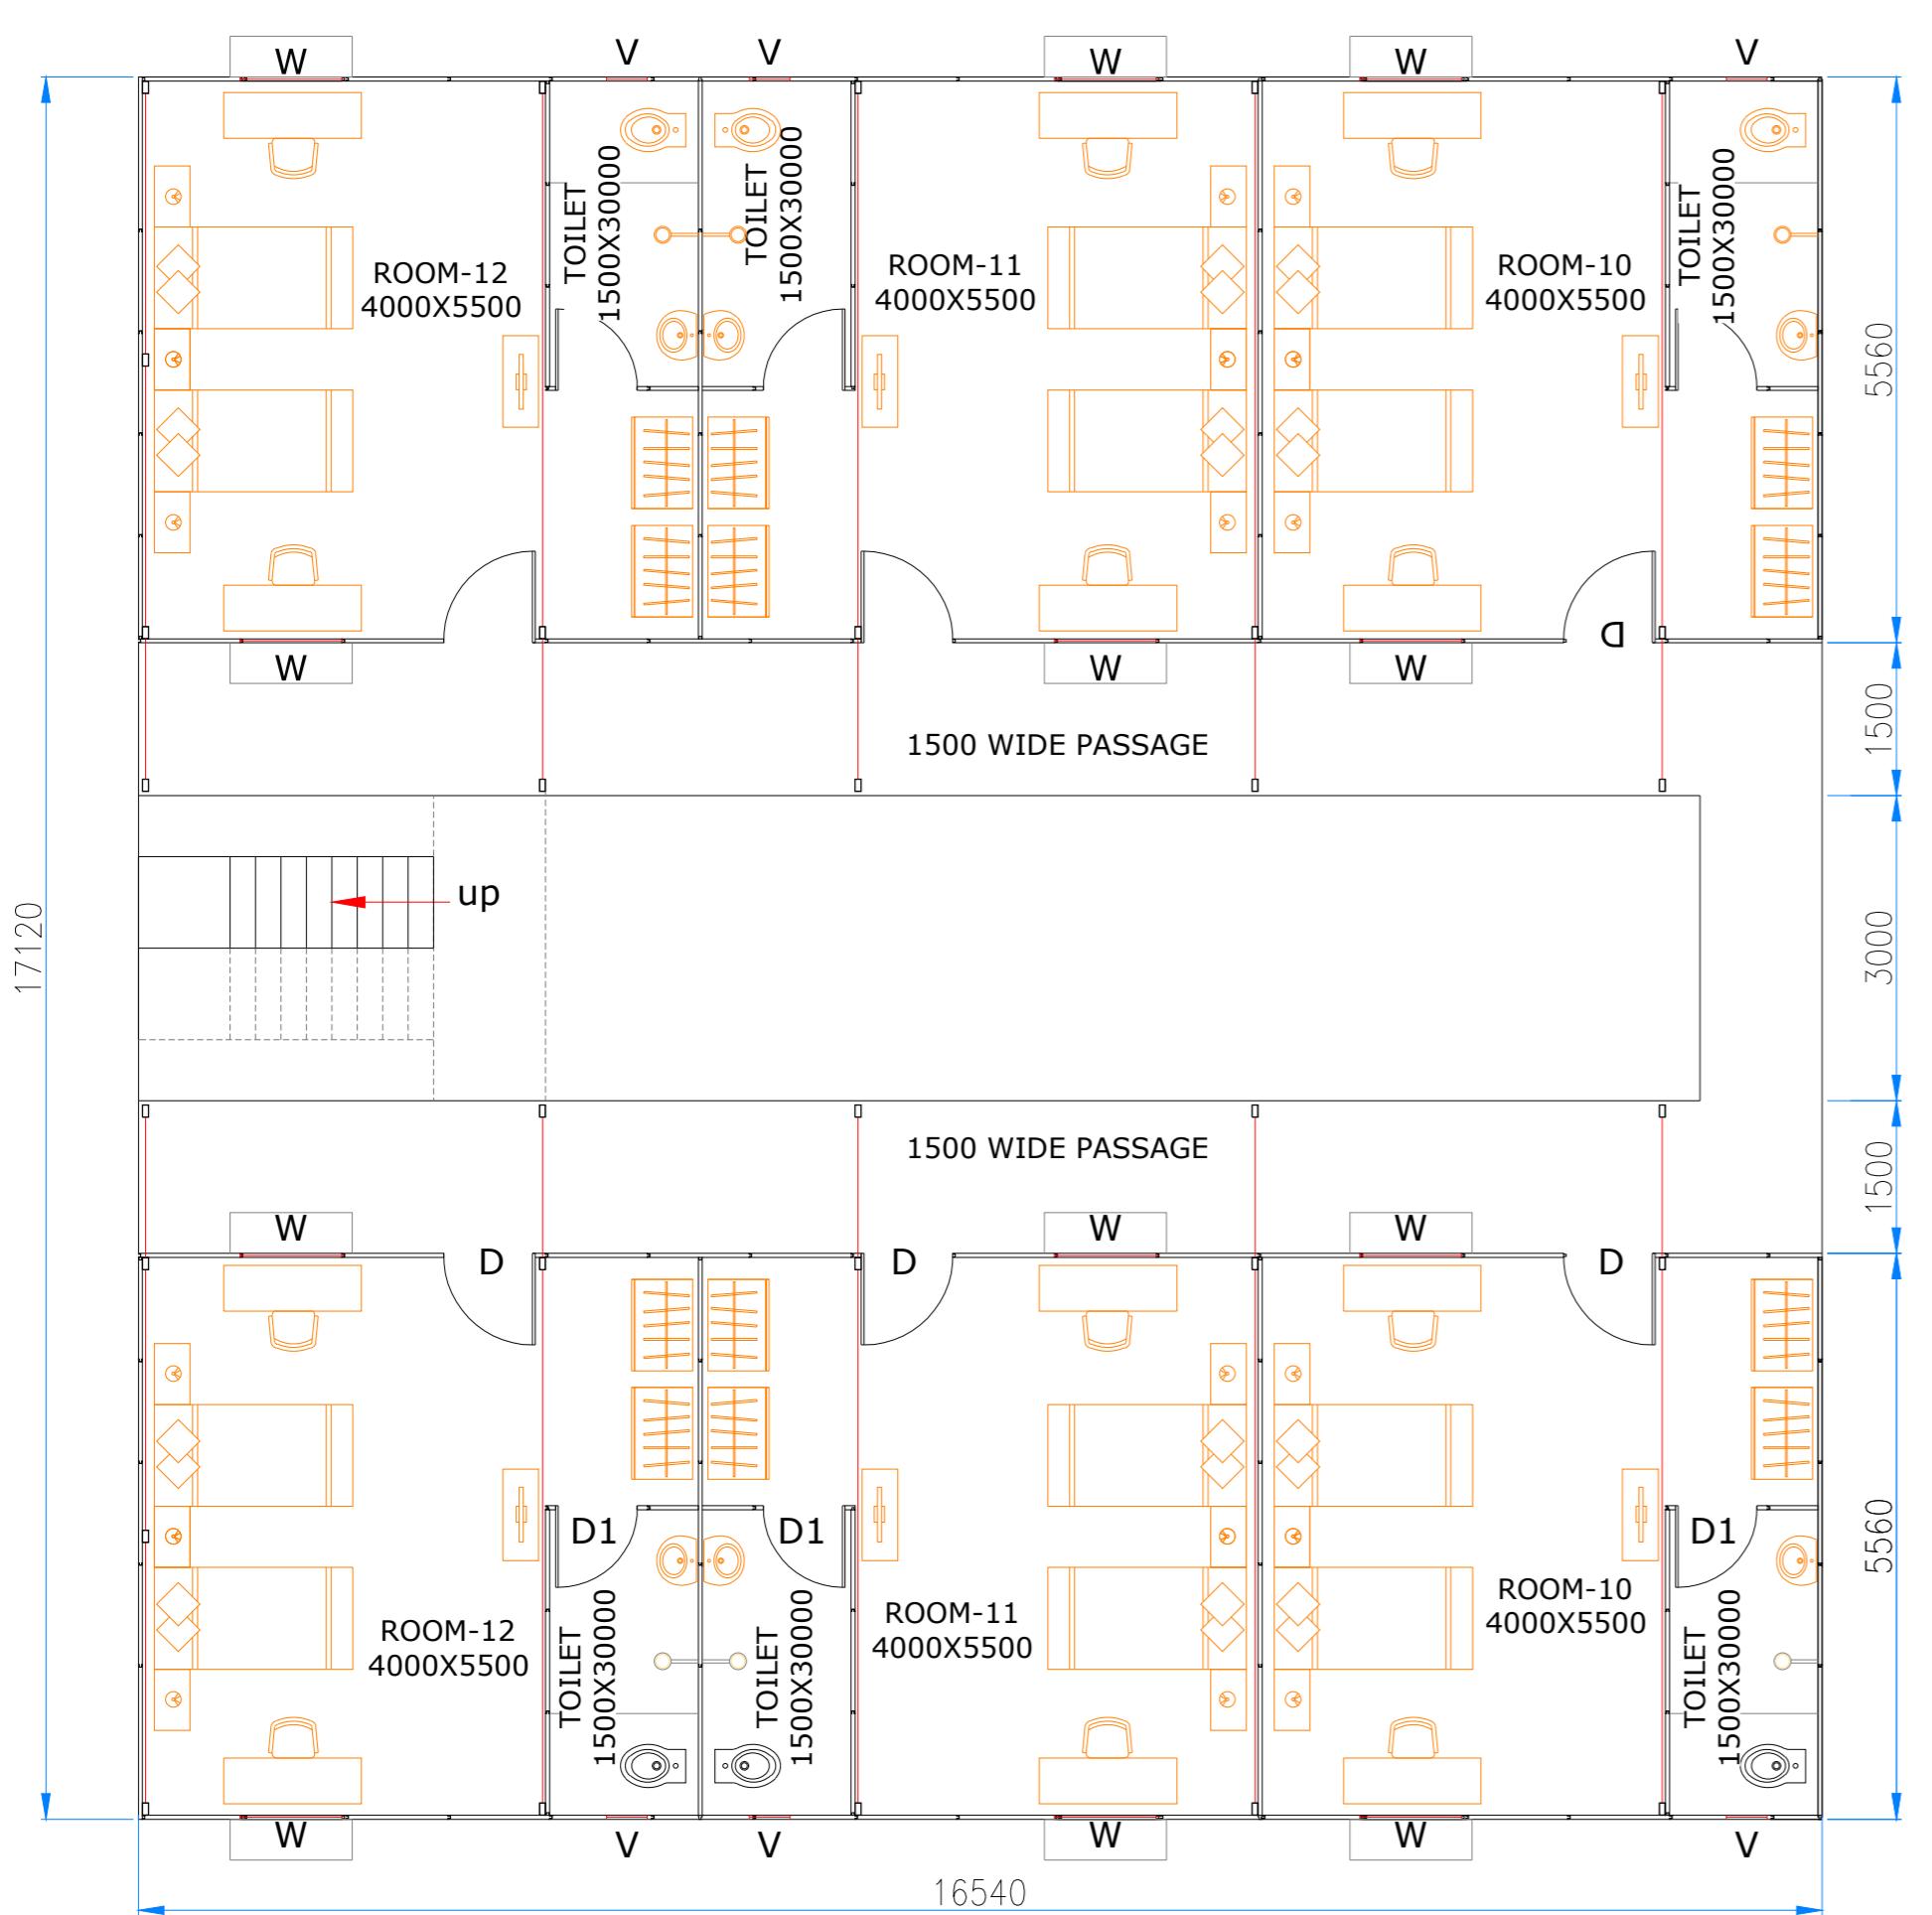

NOTE :-


1. ALL DIMENSIONS ARE IN MM.


		INLAND WATERWAYS AUTHORITY OF INDIA		
PROJECT		DETAILED FEASIBILITY STUDY FOR CAPACITY AUGMENTATION OF NATIONAL WATERWAY-1 AND DETAILED ENGINEERING FOR ITS ANCILLARY WORKS AND PROCESS BETWEEN HALDIA TO ALLAHABAD (JAL VIKAS PROJECT)		
CONSULTANT	HOWE	PMC PROJECTS INDIA PRIVATE LIMITED From vision to reality...	NAME	SIGN DATE
			DRN	VAP 25/09/17
			CHD	AM 25/09/17
			APD	SP 25/09/17
TITLE		IWT TERMINAL AT VARANASI LAYOUT OF JAI YATRI NIWAS (GUEST HOUSE)		
		JOB. NO.	DRG. NO.	
		I-525	VTR-229	
COORDINATE SYSTEM USED: ENTER CO-ORD SYSTEM HERE				
	UNIT	SCALE - AS SHOWN	Size : A1	REV. 0

0 25/09/17 VAP AM SP
REV. DATE DESCRIPTION DRN CHD APD

THIS DESIGN OR DRAWING IS THE PROPERTY OF PMC PROJECTS INDIA PRIVATE LIMITED From vision to reality... HOWE

IT IS SUBJECT TO THEIR RECALL AND MUST NOT BE LENT COPIED OR REPRODUCED WITHOUT THEIR WRITTEN PERMISSION.

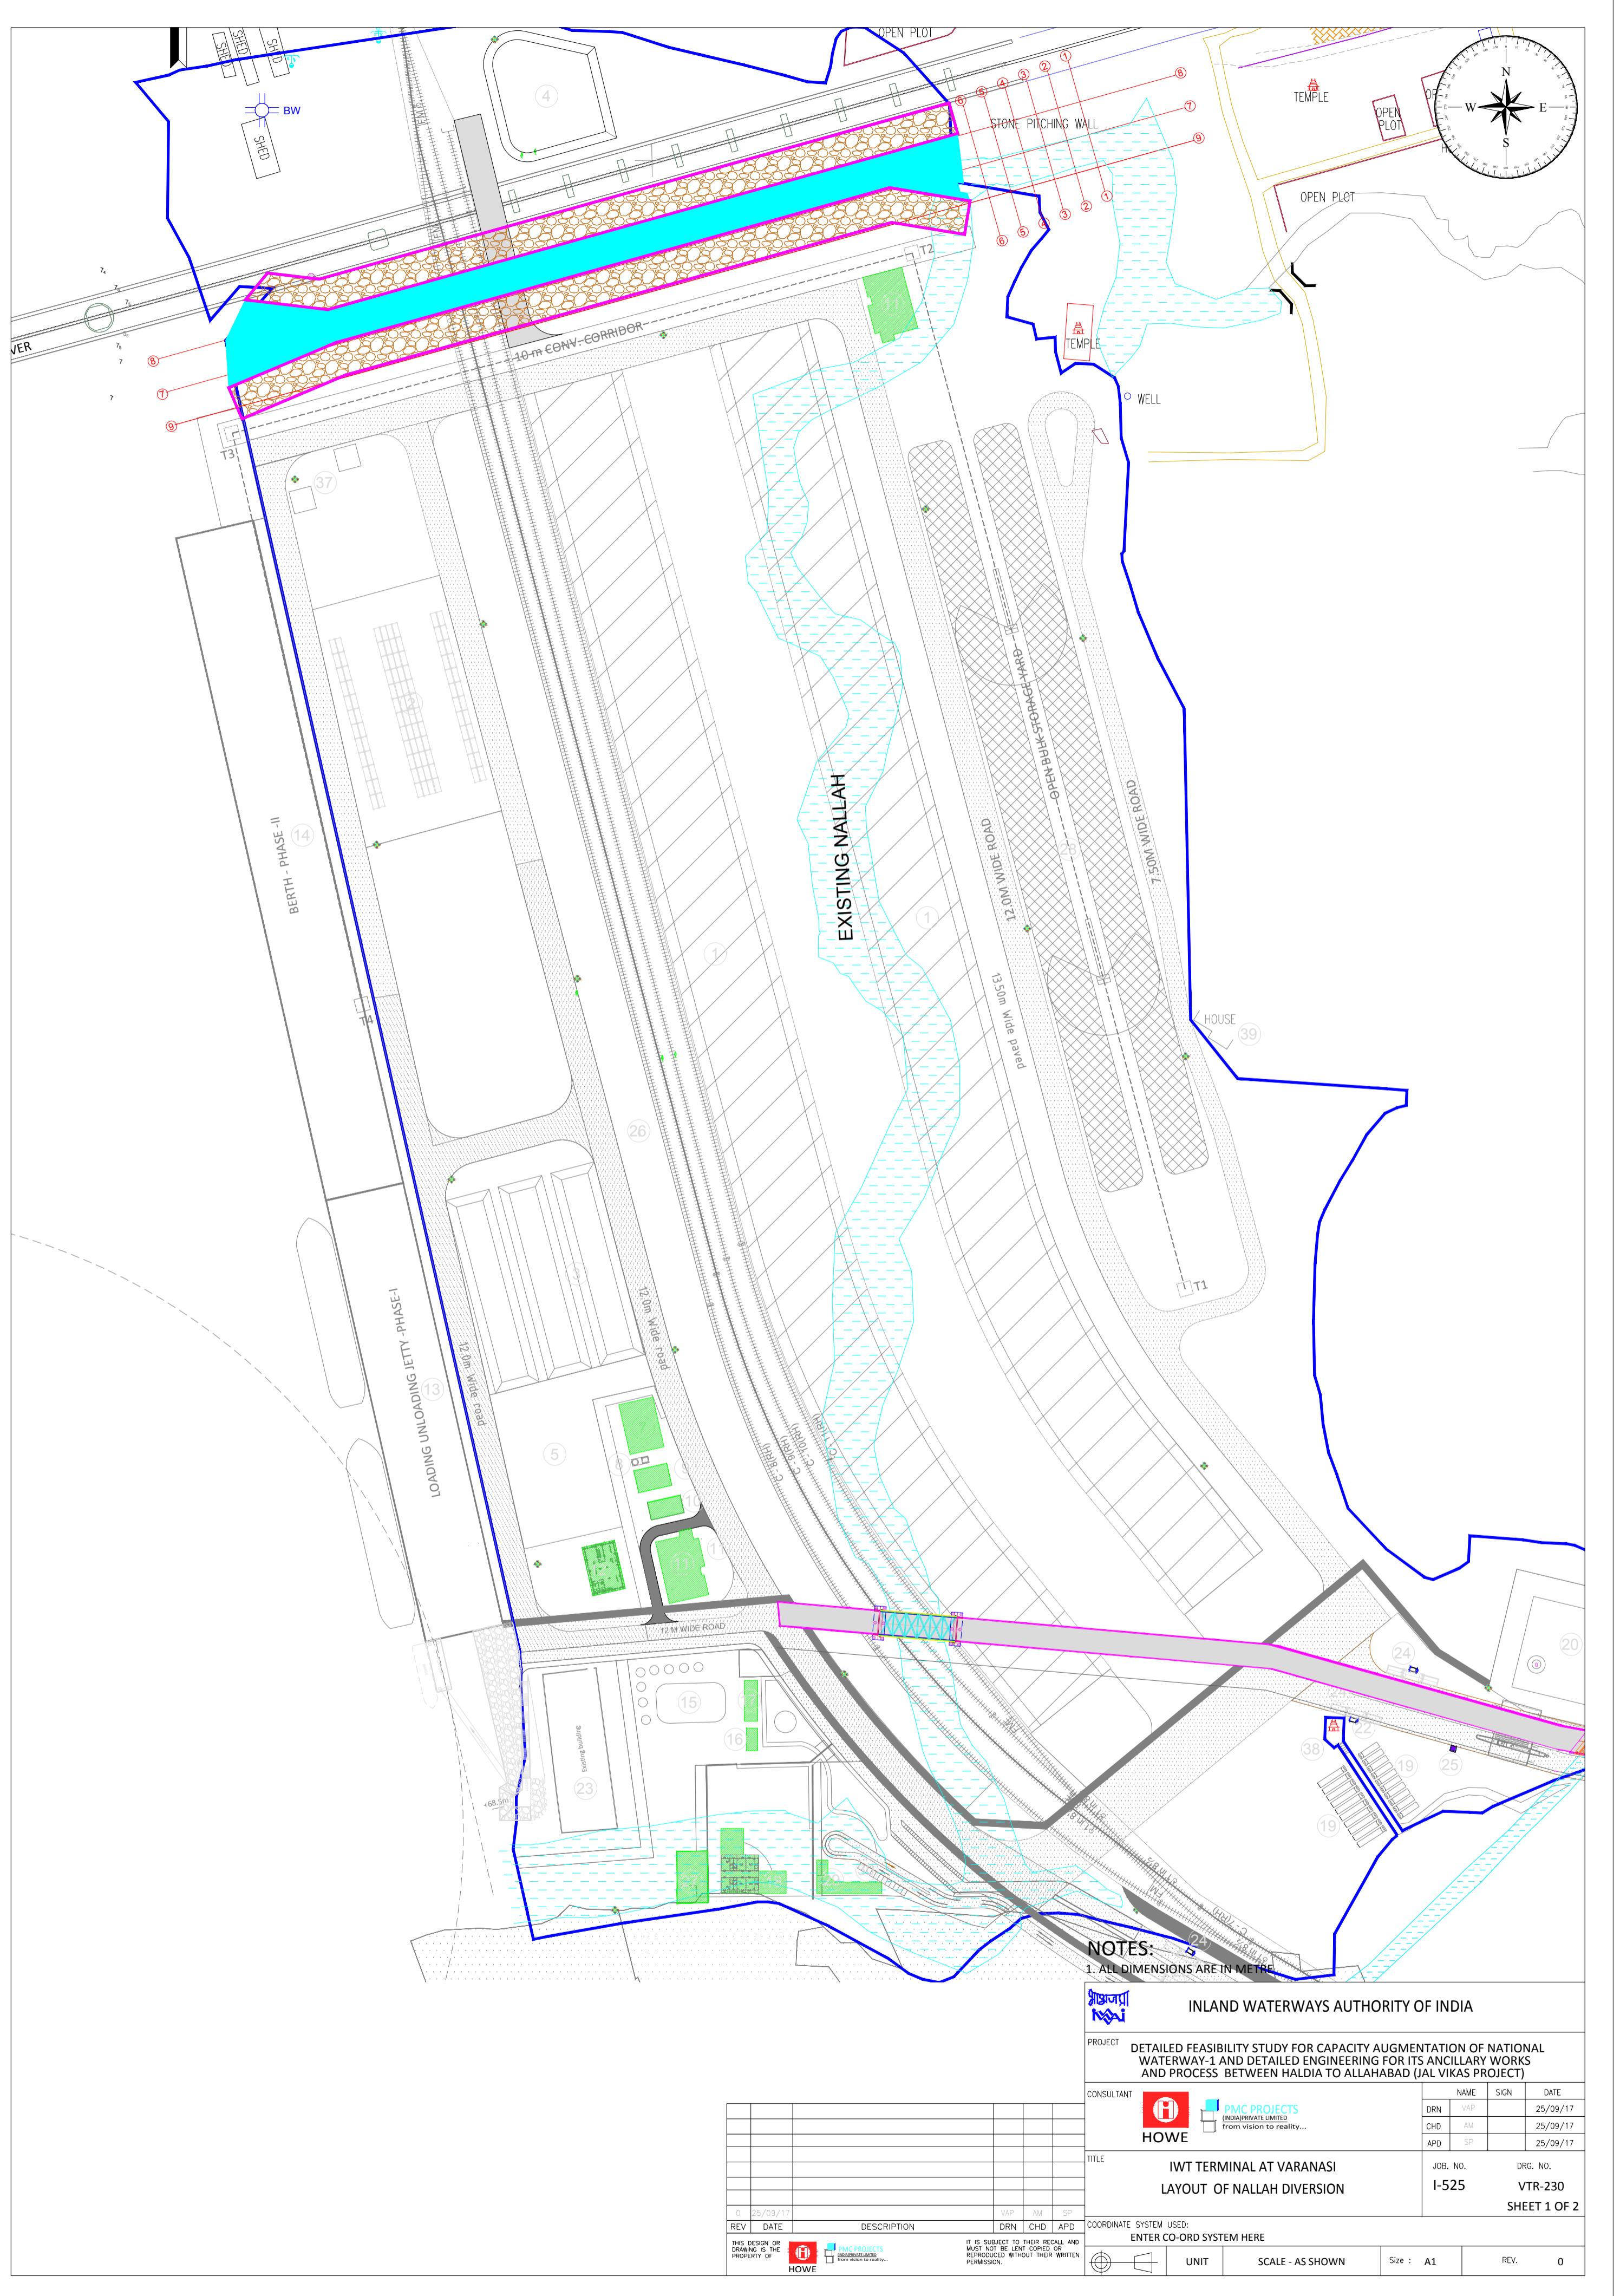

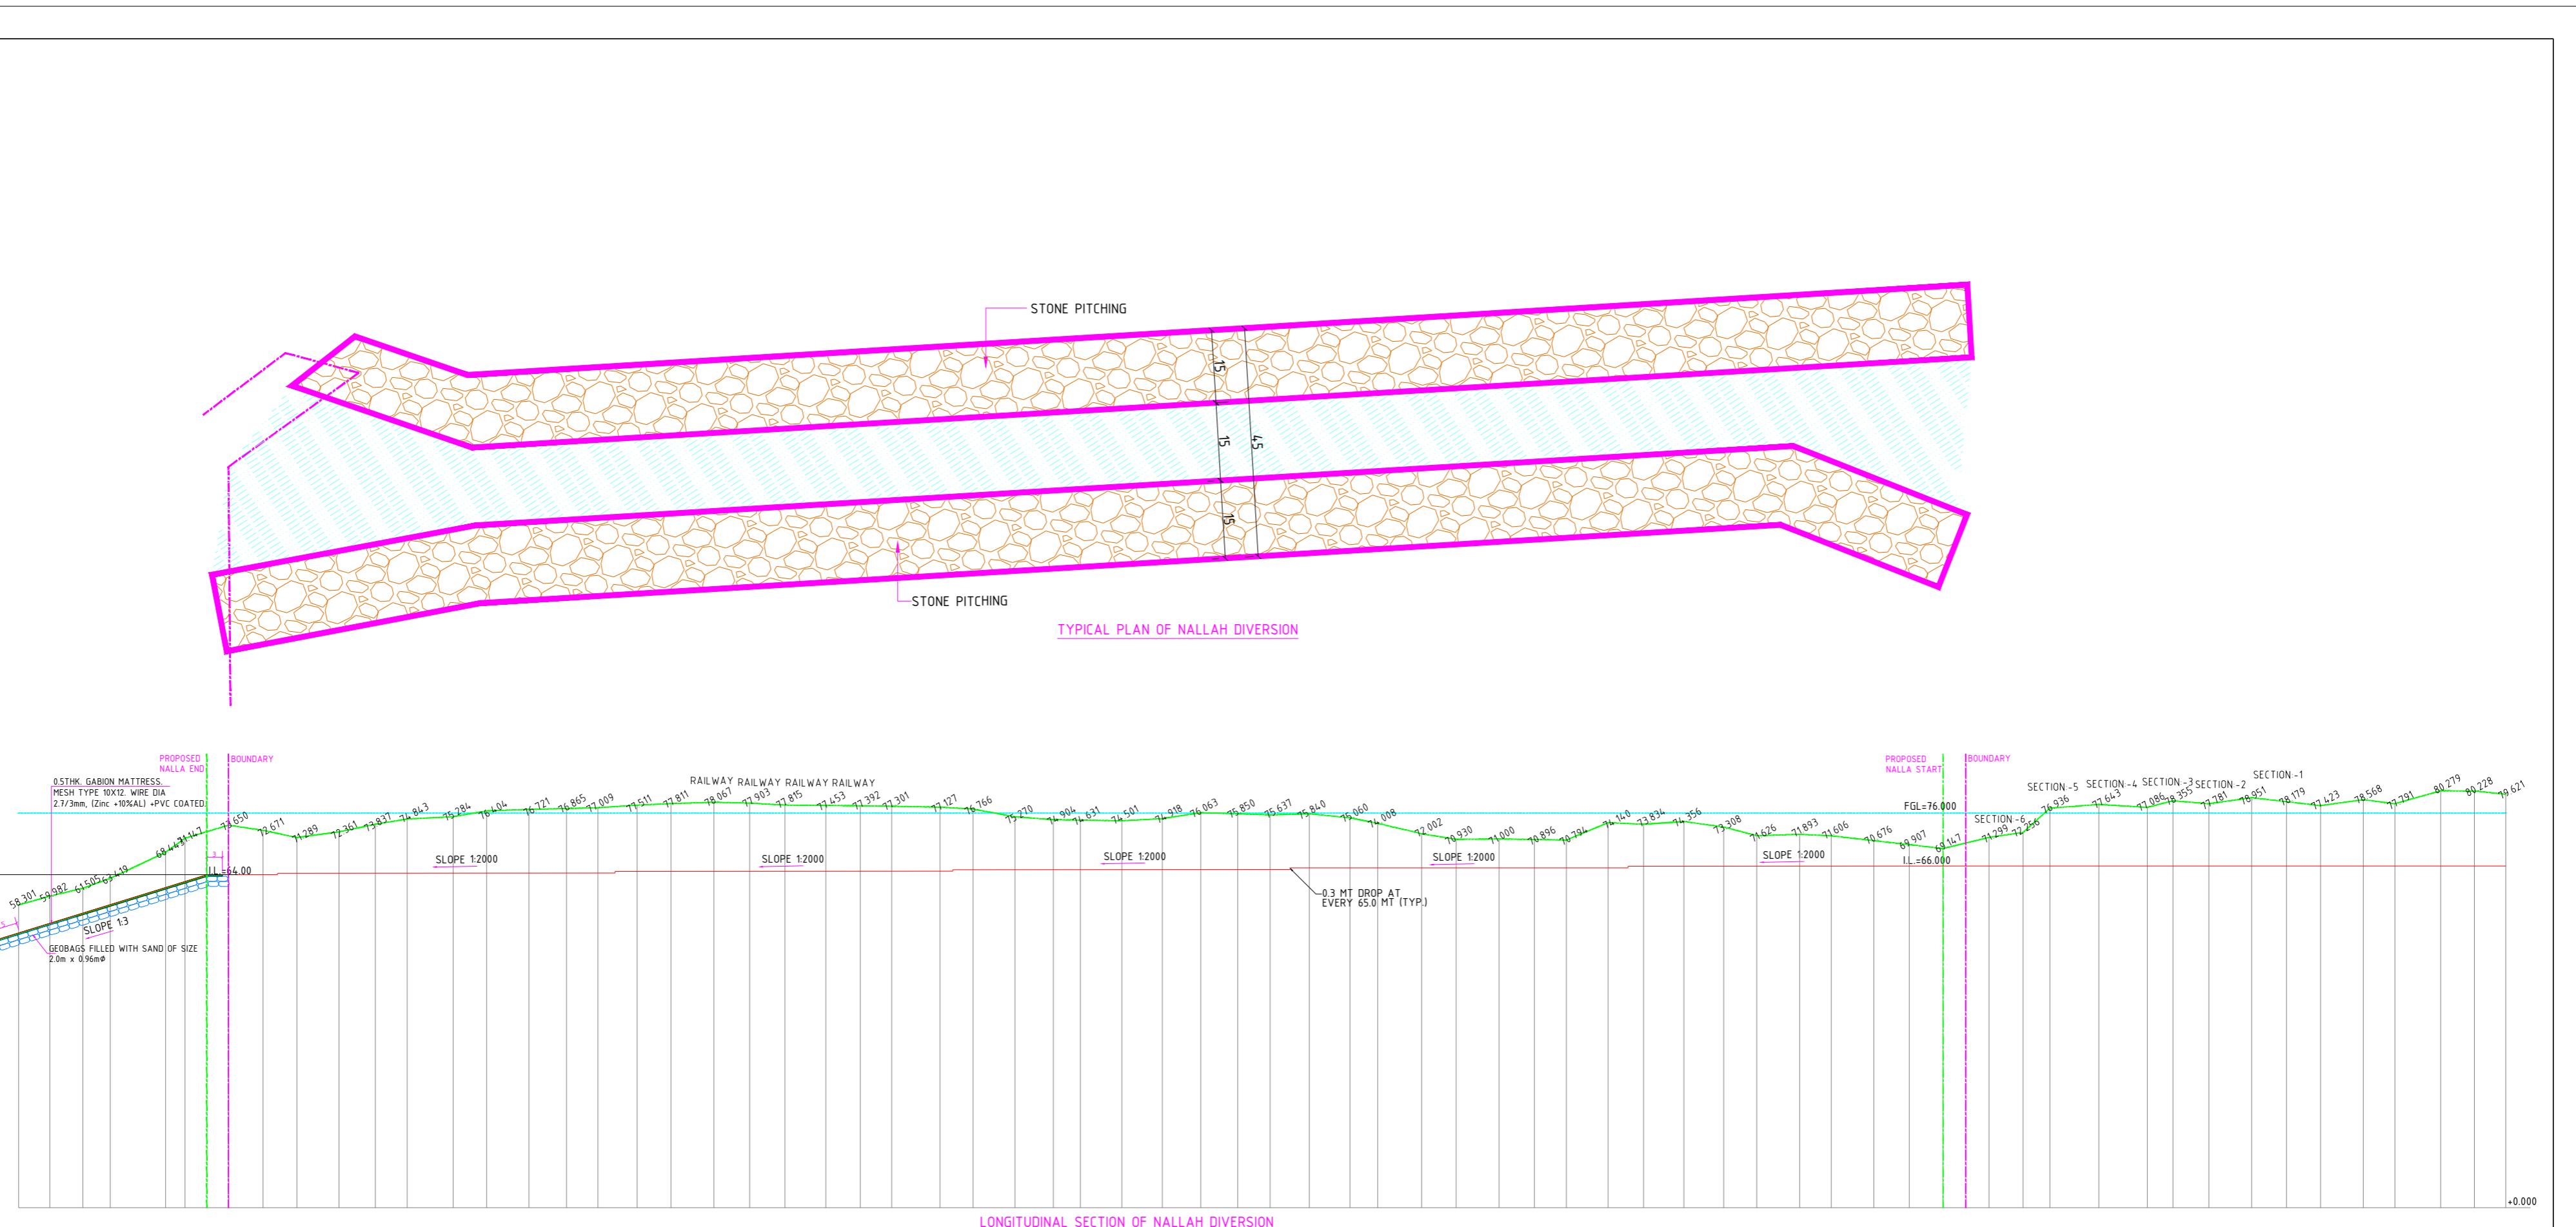

NOTES

1. ALL DIMENSIONS ARE IN MILLIMETERS
 2. ALL LEVELS ARE IN METERS & ARE WITH RESPECT TO MSL



INLAND WATERWAYS AUTHORITY OF INDIA

PROJECT DETAILED FEASIBILITY STUDY FOR CAPACITY AUGMENTATION OF NATIONAL WATERWAY-1 AND DETAILED ENGINEERING FOR ITS ANCILLARY WORKS AND PROCESS BETWEEN HALDIA TO ALI MAMAD (WALWIK PROJECT)



L VIKAS PROJECT		
	NAME	SIGN
RN	VAP	25/09/17
HD	AM	25/09/17

TITLE IWT TERMINAL AT VARANASI
LONGITUDINAL SECTION OF NALLAH DIVERSION

JOB. NO. DRG. NO.
I-525 VTR-230
SHEET 2 OF 2

SP COORDINATE SYSTEM USED:

AND WRITTEN	ENTER CO-ORD SYSTEM HERE			
	UNIT	SCALE - AS SHOWN	Size : A1	REV. 0

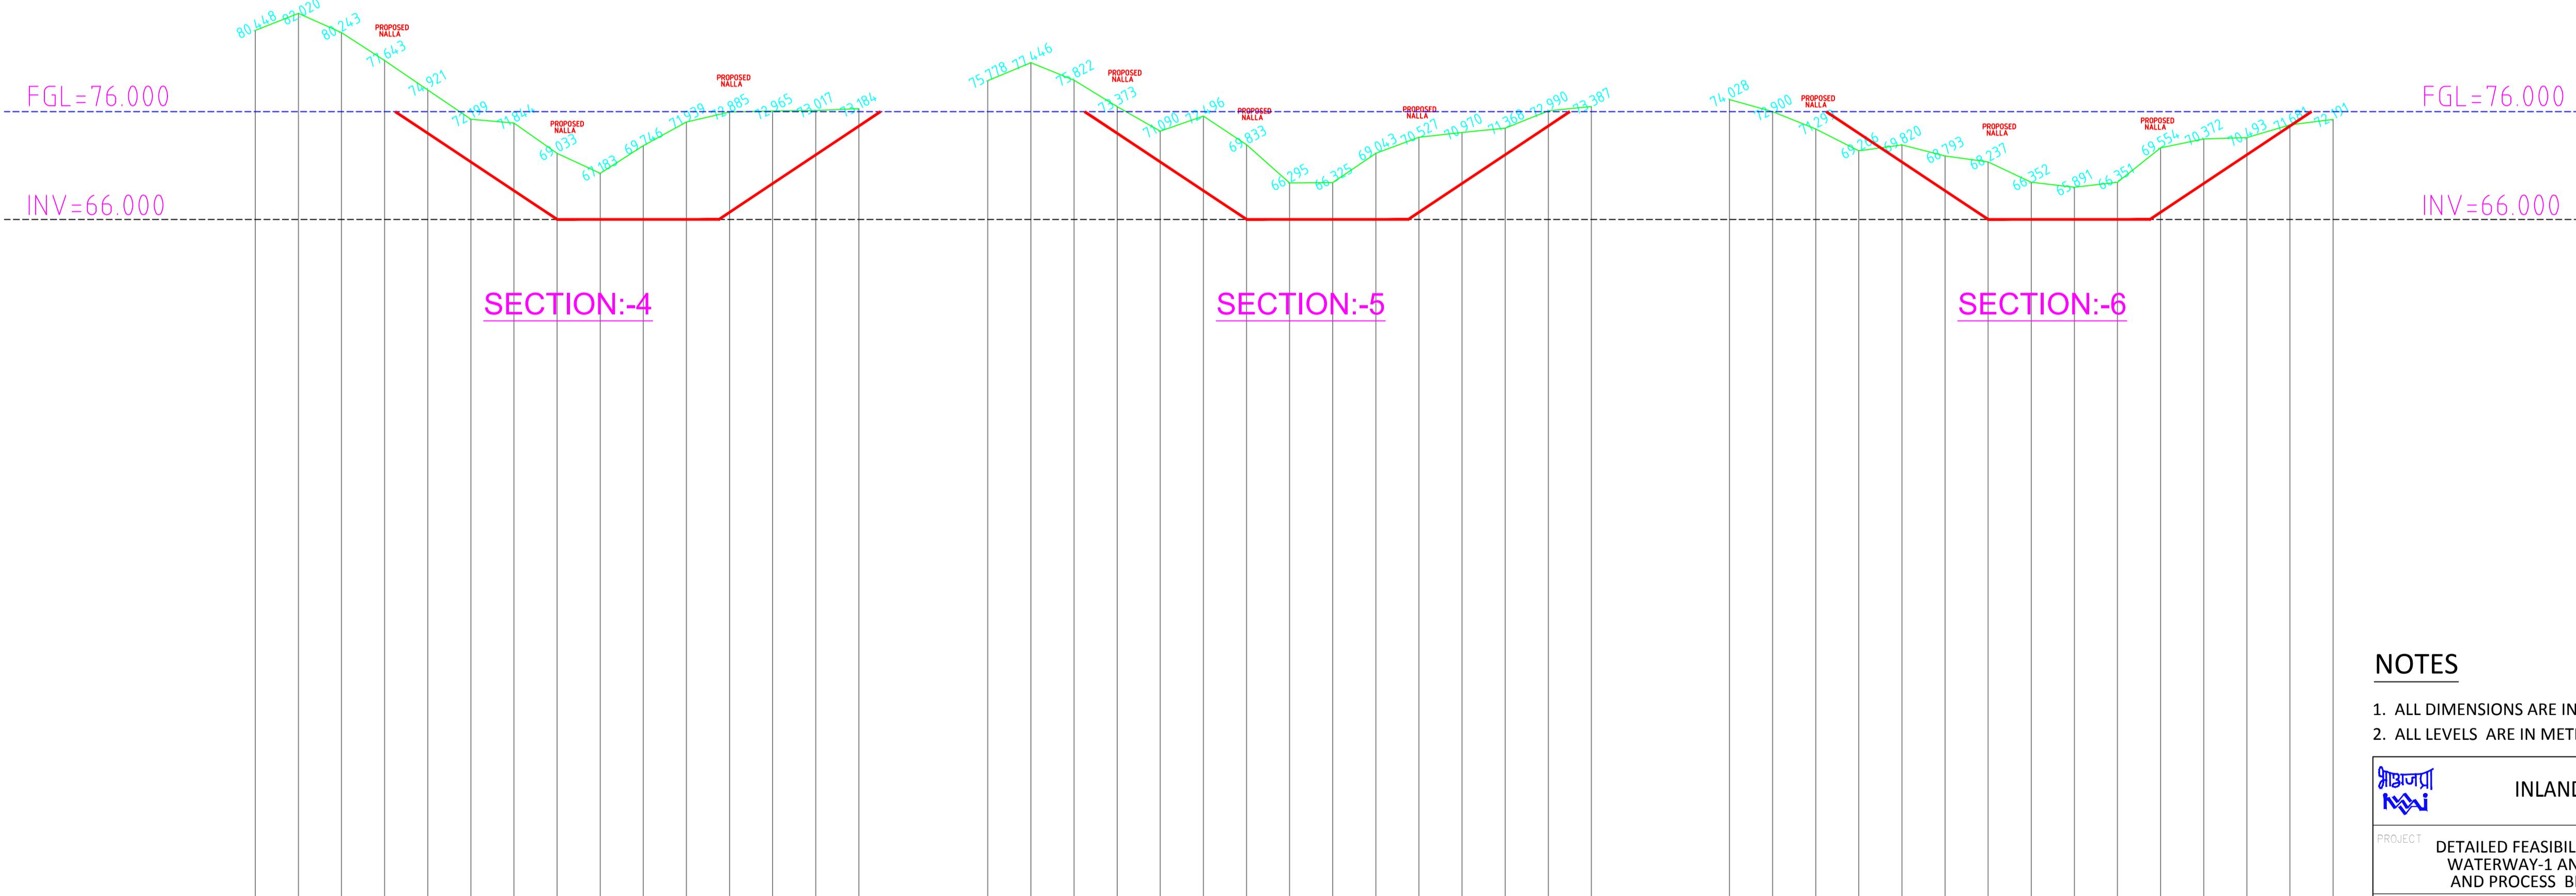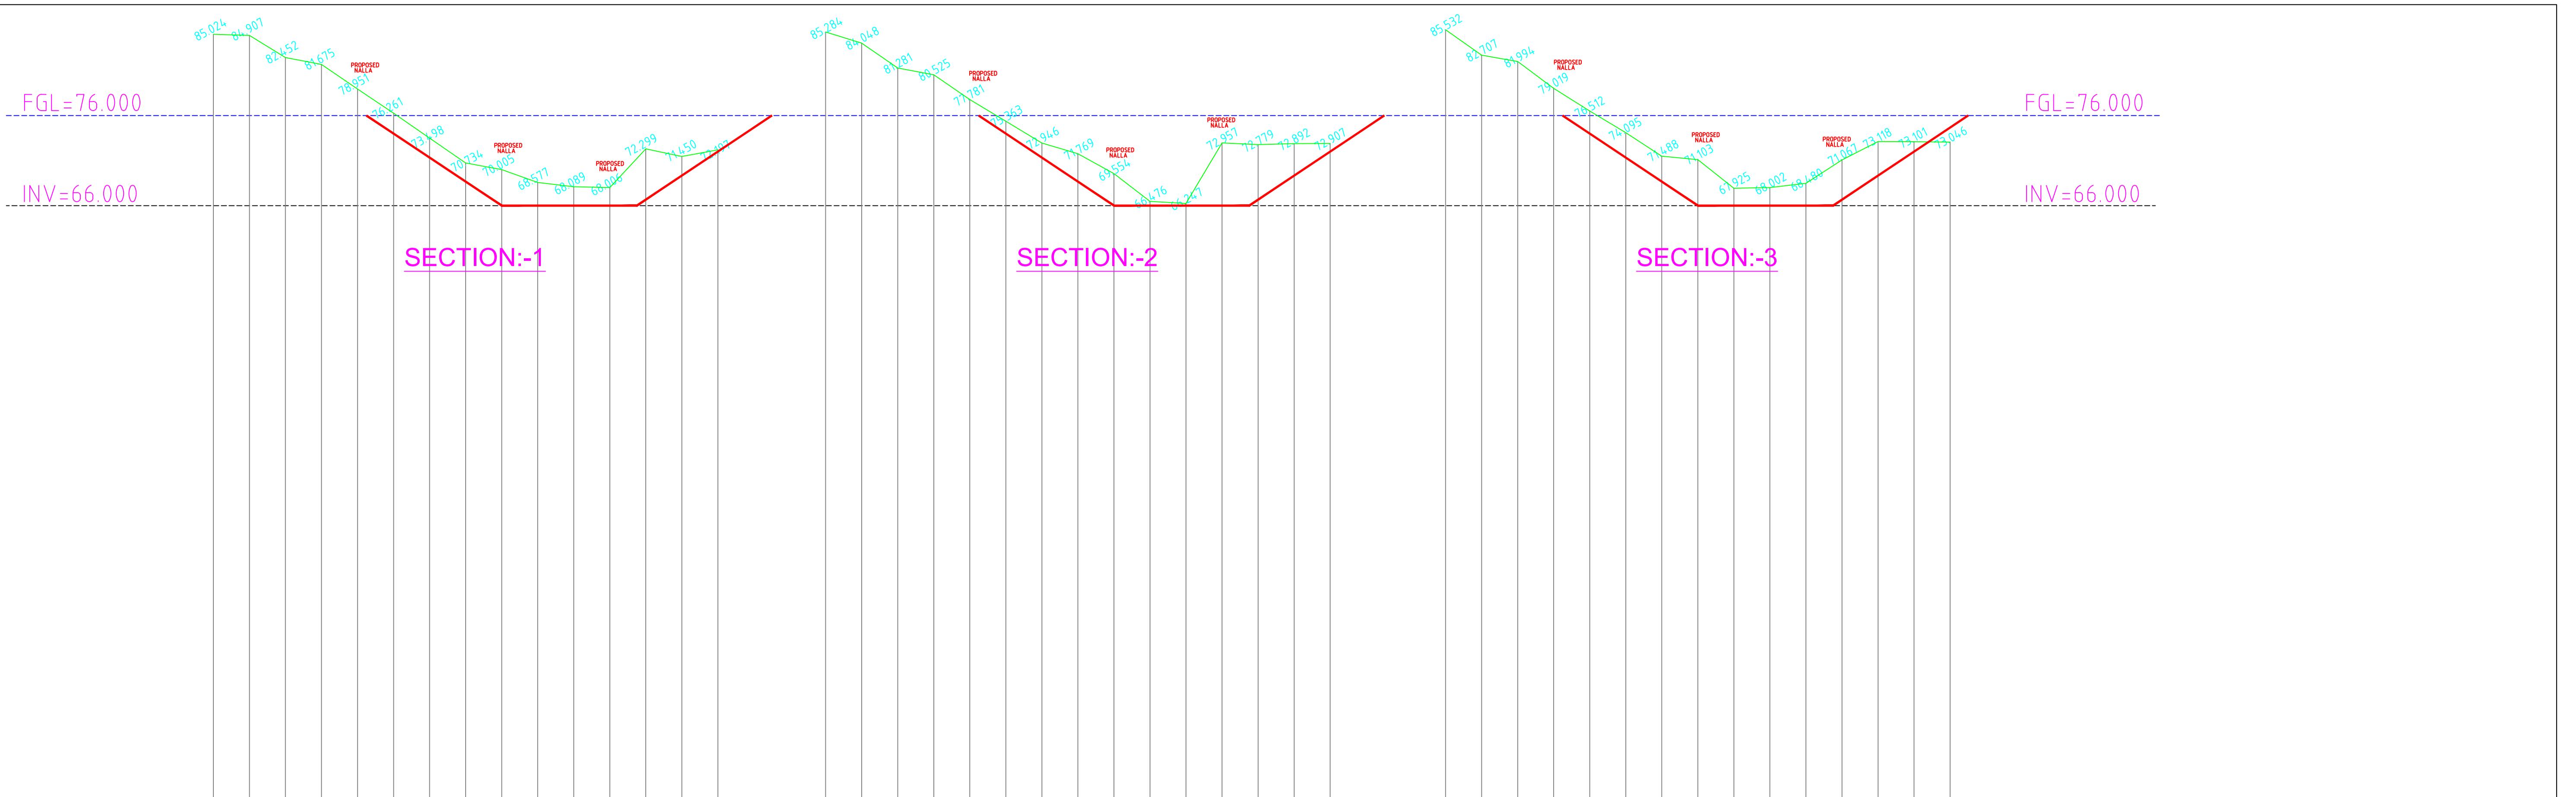

NOTES

1. ALL DIMENSIONS ARE IN MILLIMETERS
2. ALL LEVELS ARE IN METERS & ARE WITH RESPECT TO MSL

INLAND WATERWAYS AUTHORITY OF INDIA

PROJECT DETAILED FEASIBILITY STUDY FOR CAPACITY AUGMENTATION OF NATIONAL WATERWAY-1 AND DETAILED ENGINEERING FOR ITS ANCILLARY WORKS AND PROCESS BETWEEN HALDIA TO ALLAHABAD (JAL VIKAS PROJECT)

CONSULTANT	HOWE	PMC PROJECTS		
		DRN	VAP	DATE
		60223	60227	25/09/17
		60221	60225	25/09/17
		60222	60226	25/09/17
		60224	60228	25/09/17

TITLE IWT TERMINAL AT VARANASI
CROSS SECTION OF NALLAH DIVERSION

JOB. NO. DRG. NO.

I-525 VTR-230


SHEET 3 OF 3

0	25/09/17	REV	DATE	DESCRIPTION	DRN	CHD	APD
VAP	AM	SP					
THIS DESIGN OR DRAWING IS THE PROPERTY OF HOWE							
IT IS SUBJECT TO THEIR RECALL AND MUST NOT BE LENT COPIED OR REPRODUCED WITHOUT THEIR WRITTEN PERMISSION.							


COORDINATE SYSTEM USED:

ENTER CO-ORD SYSTEM HERE

UNIT SCALE - AS SHOWN Size : A1 REV. 0

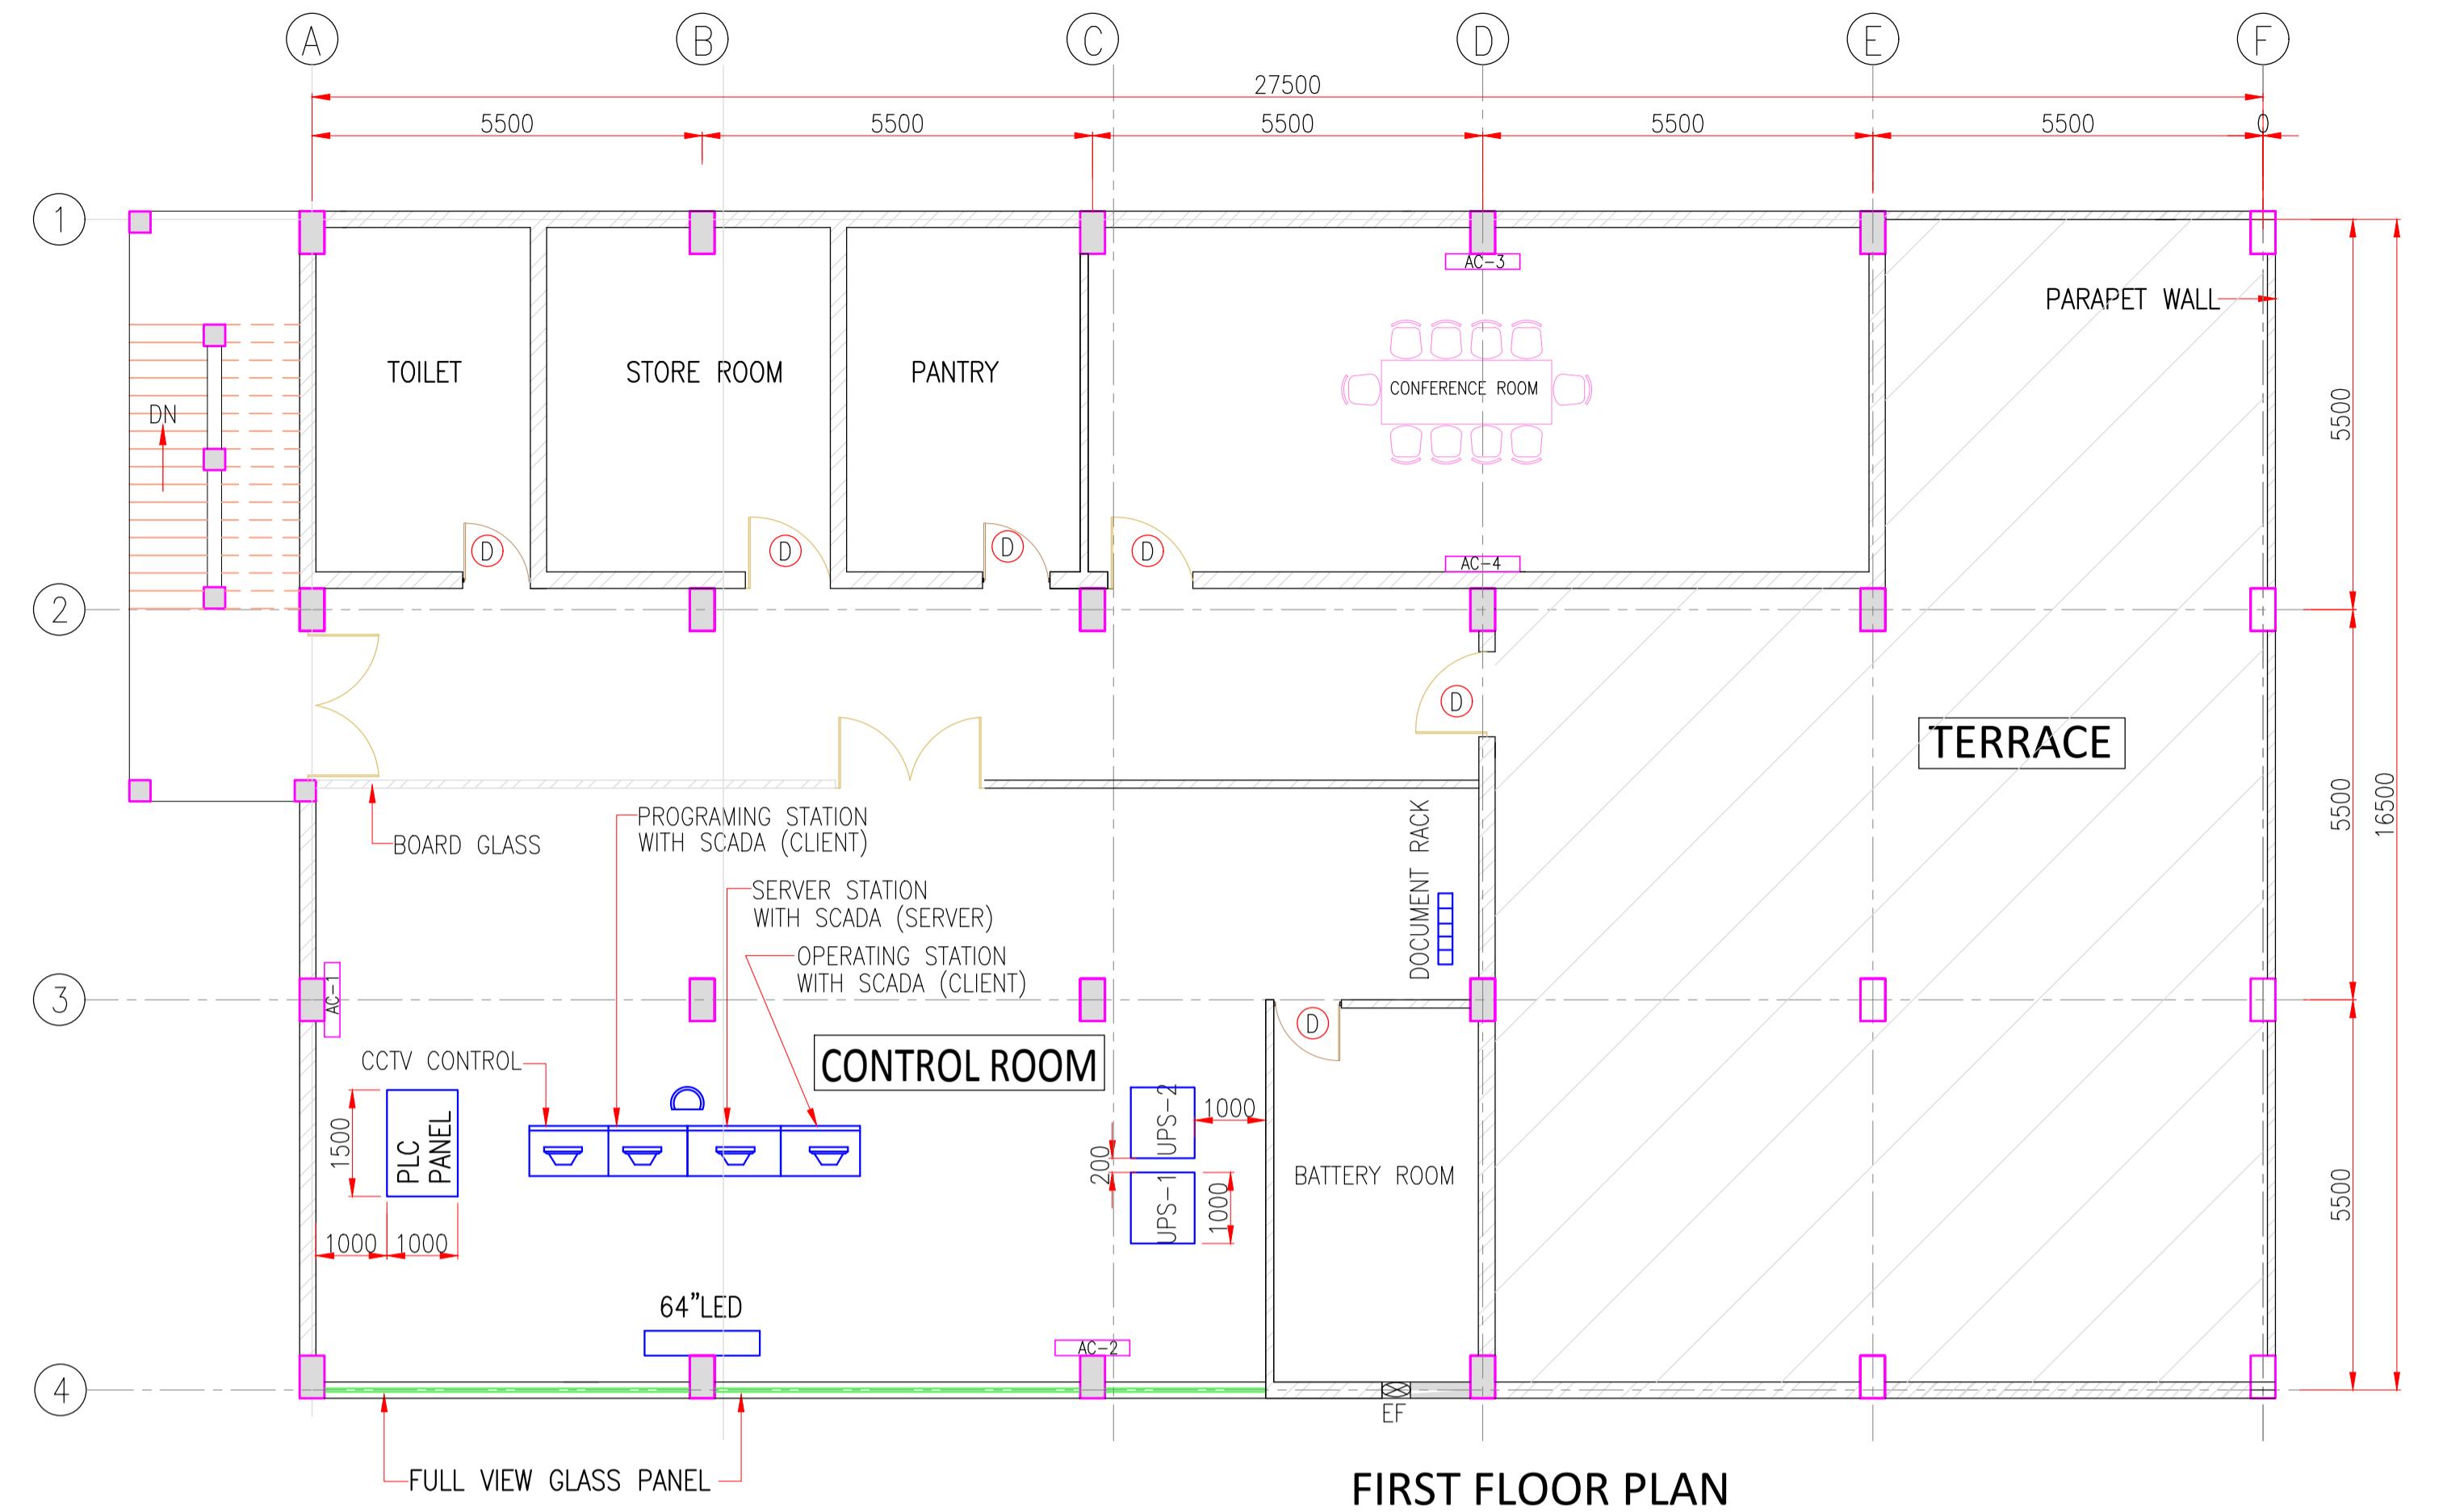

FIRST FLOOR PLAN

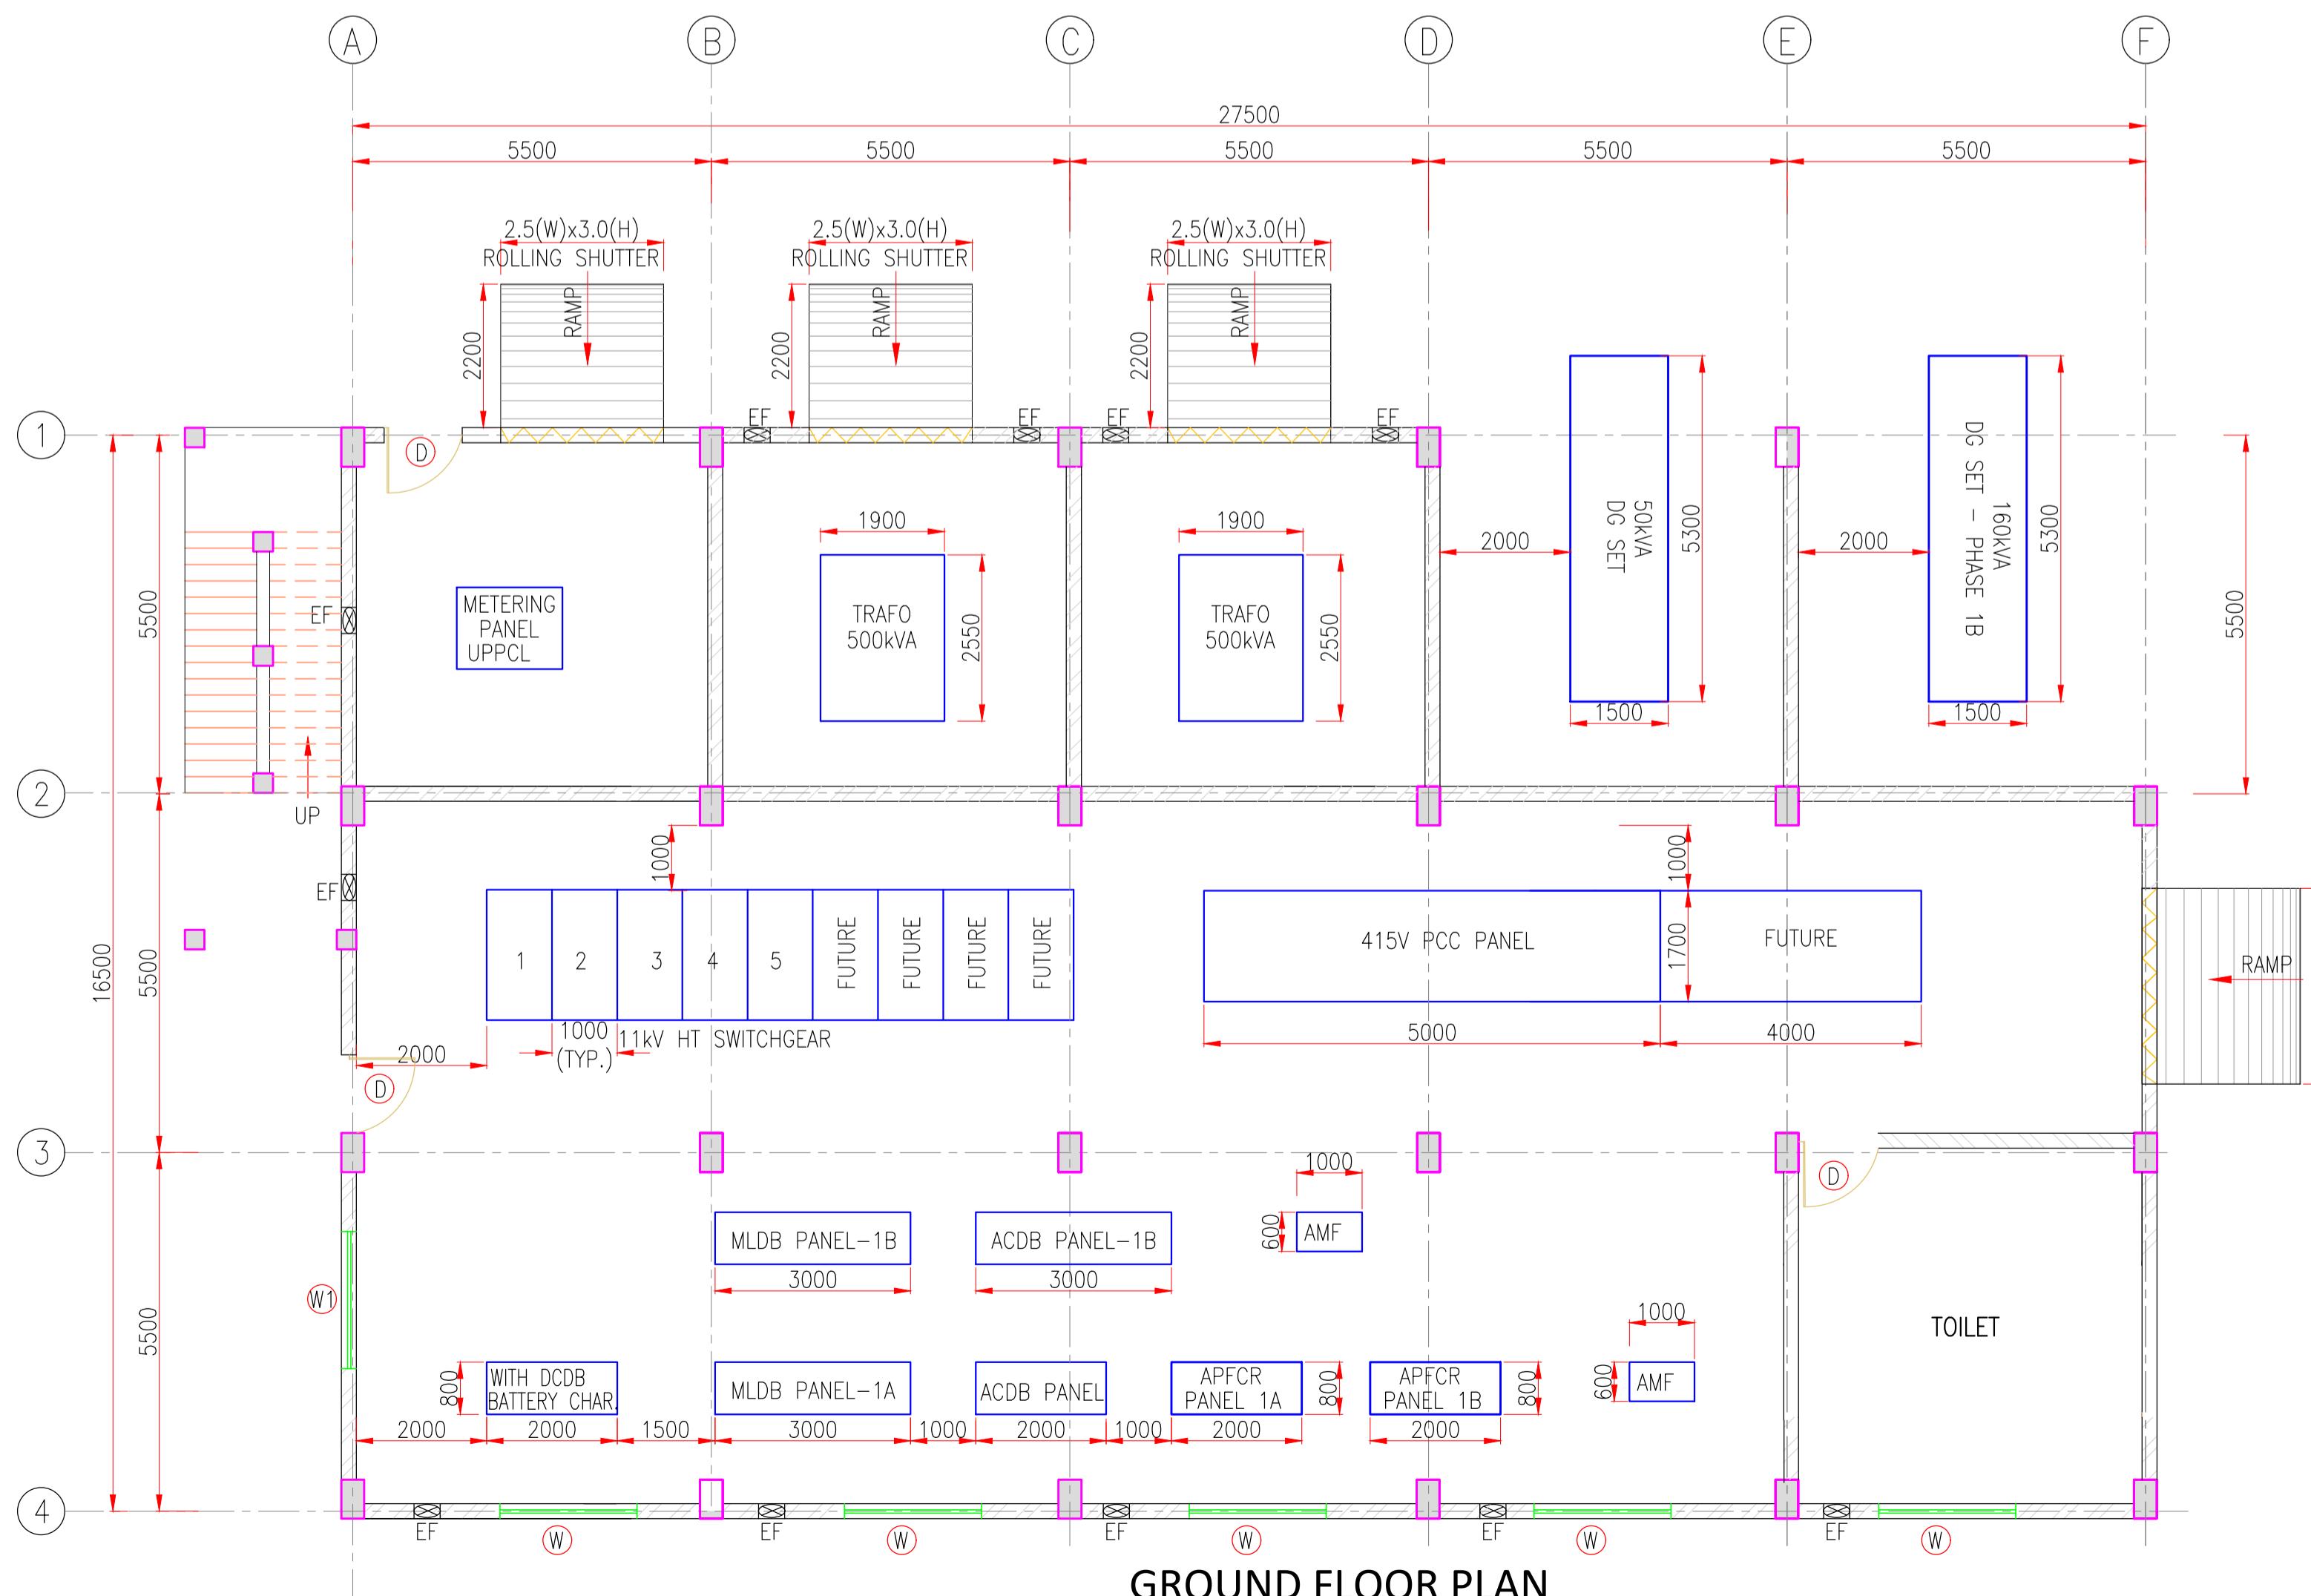

GROUND FLOOR PLAN

LEGEND :-

- W WINDOW (OPENABLE)
 - W1 FIXED GLASS WINDOW
 - X EXHAUST FAN
 - D DOOR


NOTE :-

1. ALL DIMENSIONS ARE IN MM UNLESS OTHERWISE NOTED.

* THE CONTRACTOR SHALL PROCUER THE EQUIPMENT FOR PHASE 1 ONLY & PROVISION SHALL BE MADE FOR PHASE 2

						 INLAND WATERWAYS AUTHORITY OF INDIA					
						PROJECT DETAILED FEASIBILITY STUDY FOR CAPACITY AUGMENTATION OF NATIONAL WATERWAY-1 AND DETAILED ENGINEERING FOR ITS ANCILLARY WORKS AND PROCESS BETWEEN HALDIA TO ALLAHABAD (JAL VIKAS PROJECT)					
						CONSULTANT   PMC PROJECTS <small>(INDIA) PRIVATE LIMITED</small> <small>from vision to reality...</small>			NAME SIGN DATE		
						DRN	VAP			25/09/17	
						CHD	AM			25/09/17	
						APD	SP			25/09/17	
						TITLE IWT TERMINAL AT VARANASI SUB STATION EQUIPMENT LAYOUT IN MASTER PLAN			JOB. NO. DRG. NO. I-525 VTR-232		
						COORDINATE SYSTEM USED: ENTER CO-ORD SYSTEM HERE					
0	25/09/17	VAP	AM	SP							
REV	DATE	DESCRIPTION		DRN	CHD	APD					
THIS DESIGN OR DRAWING IS THE PROPERTY OF		 HOWE		 PMC PROJECTS <small>(INDIA) PRIVATE LIMITED</small> <small>from vision to reality...</small>		<small>IT IS SUBJECT TO THEIR RECALL AND MUST NOT BE LENT COPIED OR REPRODUCED WITHOUT THEIR WRITTEN PERMISSION.</small>					
								UNIT	SCALE - AS SHOWN	Size : A1	REV. 0

ELECTRICAL SUBSTATION (ESS)

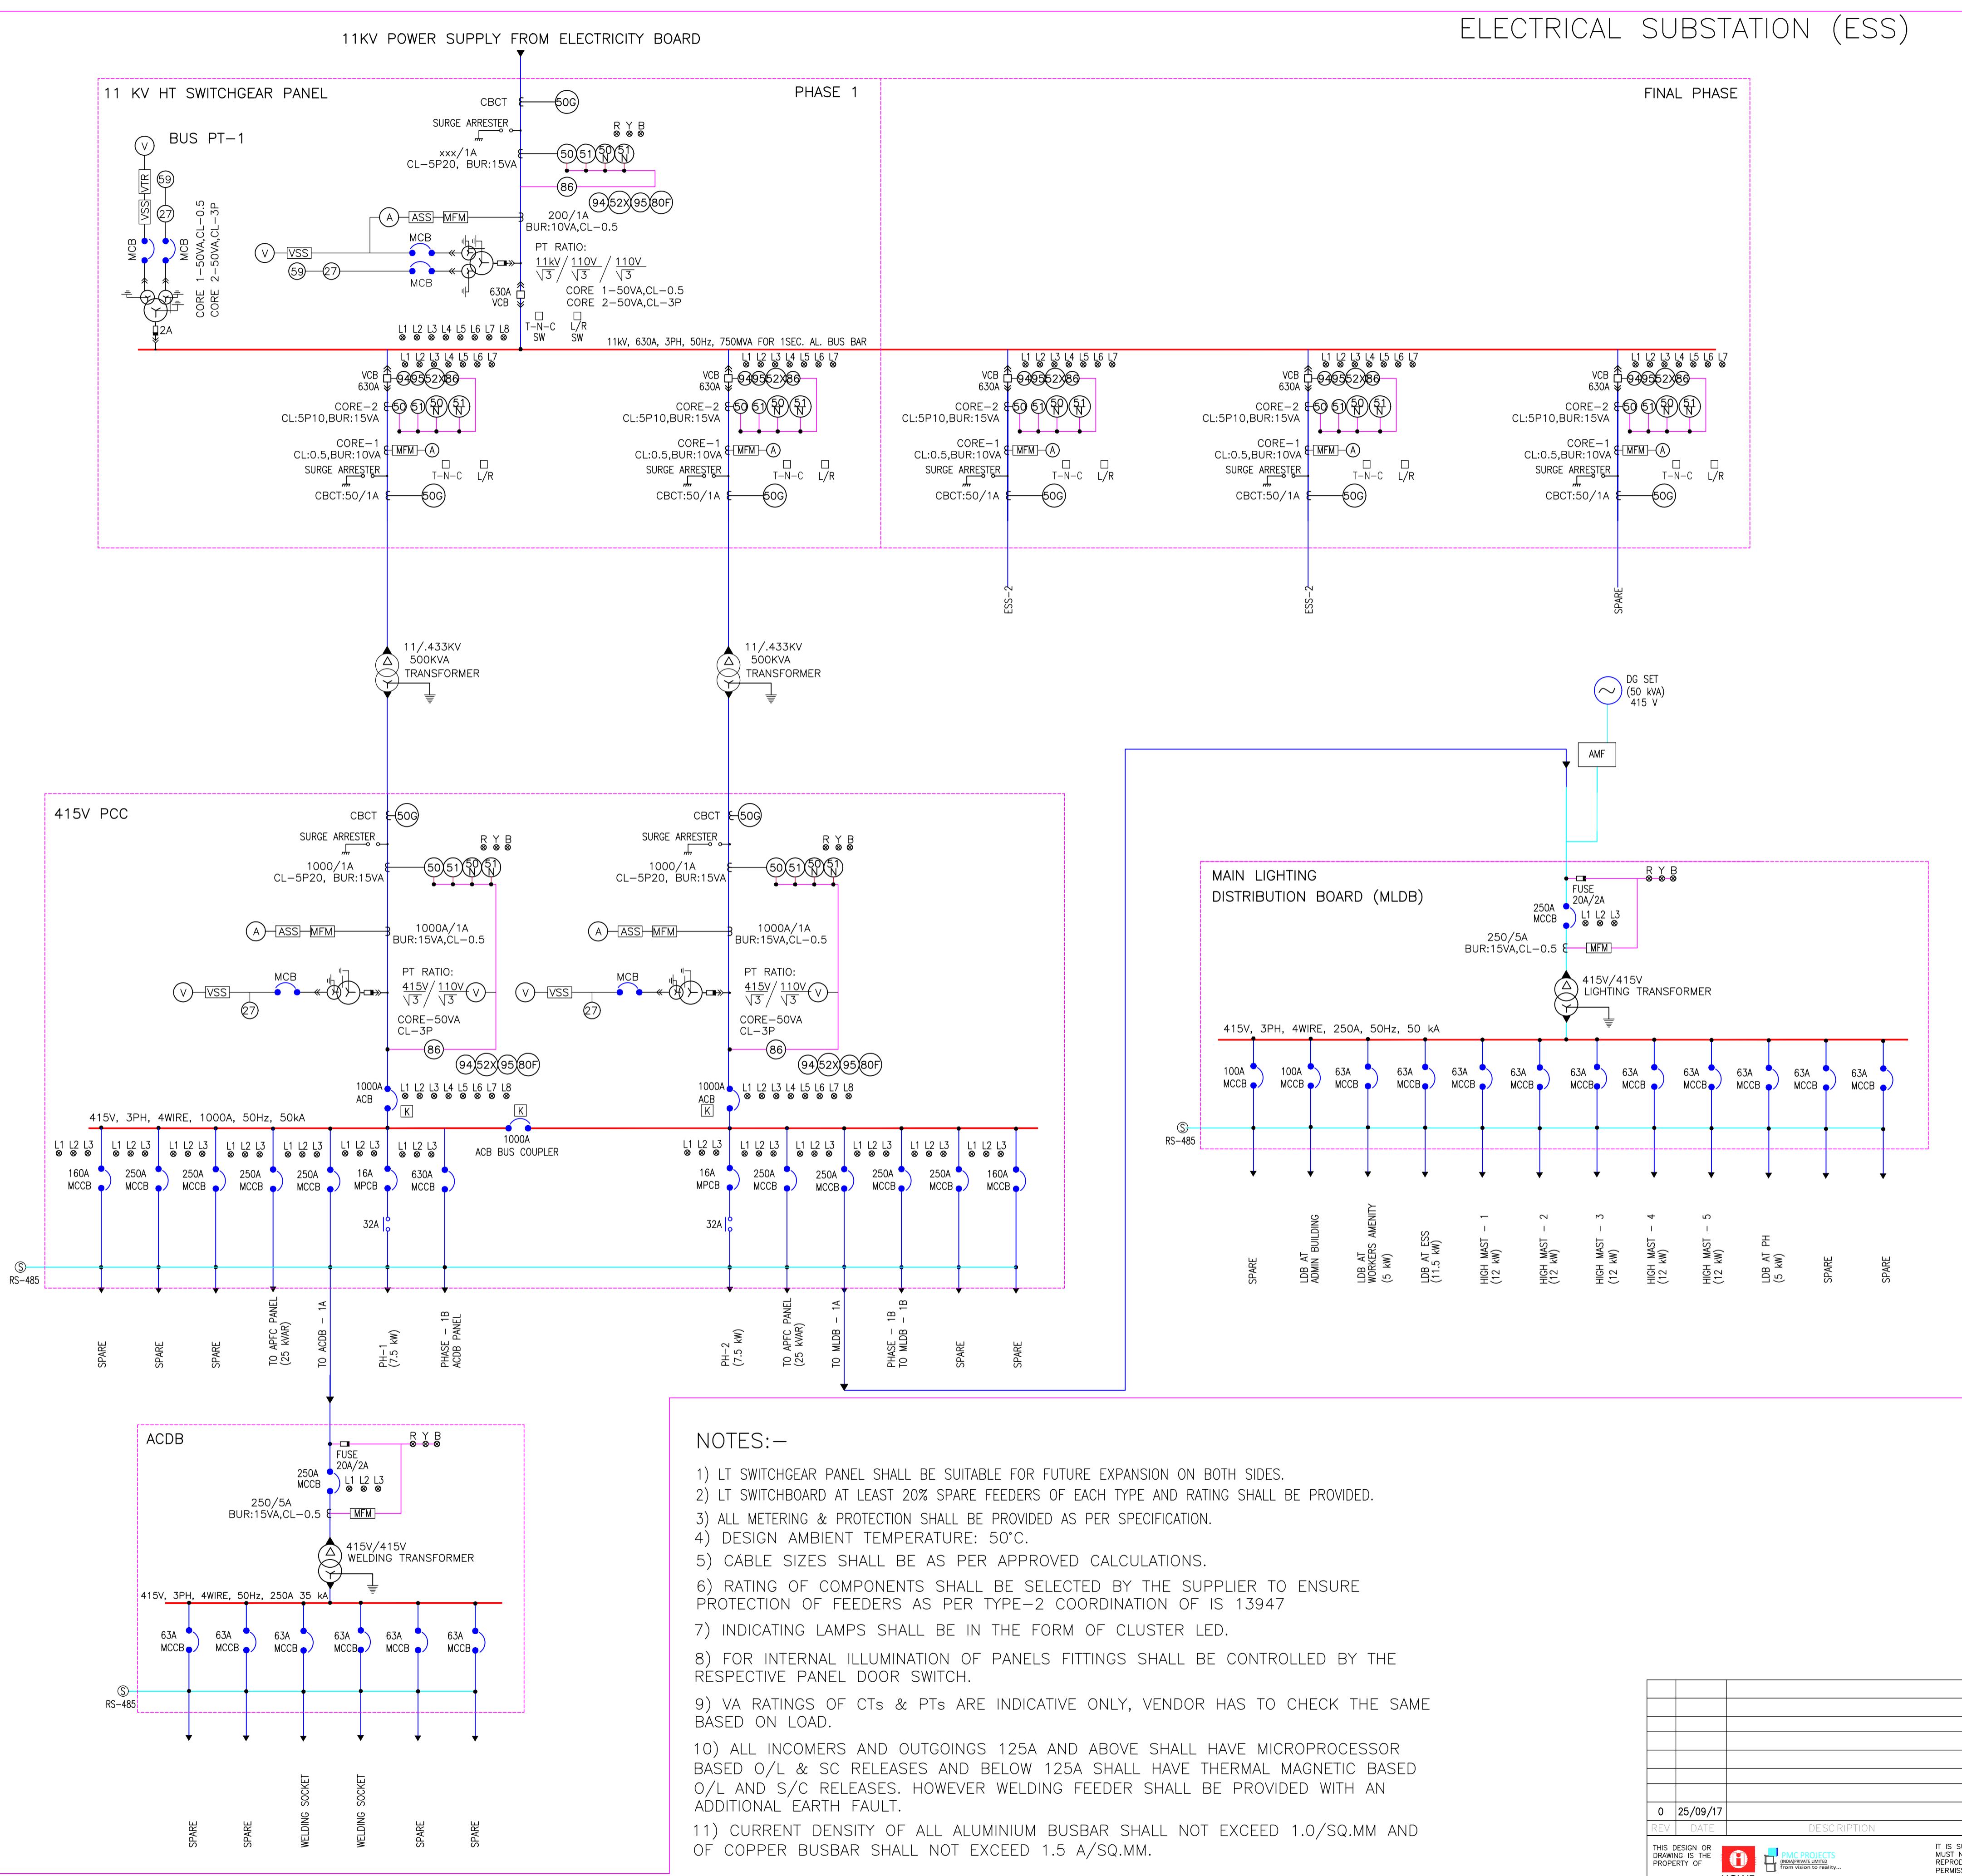


SYMBOL	DESCRIPTION
-	FUSE
Σ	CURRENT TRANSFORMER
Δ	POTENTIAL TRANSFORMER
()	MOULDED CASE CIRCUIT BREAKER
\otimes	INDICATION
\odot	AIR CIRCUIT BREAKER
$\overline{m} \quad \overline{o}$	SURGE ARRESTER
CBCT	CORE BALANCE CURRENT TRANSFORMER
(27)	UNDER VOLTAGE RELAY
(50)	INSTANTANEOUS OVER CURRENT RELAY
(50N)	INSTANTANEOUS EARTH FAULT RELAY
(51)	IDMT OVER CURRENT RELAY
(51N)	IDMT EARTH FAULT RELAY
(59)	OVER VOLTAGE RELAY
(95)	TRIP CIRCUIT SUP. RELAY
(86)	LOCK OUT RELAY
(94)	ANTI PUMPING RELAY
(50G)	INSTANTANEOUS GROUND FAULT RELAY
(80F)	DC FAIL RELAY
L1 \otimes	BREAKER ON RED
L2 \otimes	BREAKER OFF GREEN
L3 \otimes	BREAKER TRIP AMBER
L4 \otimes	SPRING CHARGED RED
L5 \otimes	TRIP CIRCUIT HEALTHY
L6 \otimes	BREAKER IN TEST POSITION
L7 \otimes	BREAKER IN SERVICE POSITION
L8 \otimes	DC FAIL
(52X)	BREAKER CONTACT MULTIPLIER RELAY
□ TNC	TRIP NEUTRAL CLOSE SWITCH
□ L/R	LOCAL/REMOTE SELECTOR SWITCH
VSS	VOLTMETER SELECTOR SWITCH
(V)	VOLTMETER
(ASS)	AMMETER SELECTOR SWITCH
(A)	AMMETER
(MFM)	MULTI FUNCTION METER
$\overleftarrow{\square}$	VACUUM CIRCUIT BREAKER
(K)	ELECTRICAL & MECHANICAL INTERLOCK
(P)	CONTACTOR
AMF	AUTO MAINS FAILURE WITH CHANGEOVER SWITCH

INLAND WATERWAYS AUTHORITY OF INDIA			
PROJECT	DETAILED FEASIBILITY STUDY FOR CAPACITY AUGMENTATION OF NATIONAL WATERWAY-1 AND DETAILED ENGINEERING FOR ITS ANCILLARY WORKS AND PROCESS BETWEEN HALDIA TO ALLAHABAD (JAL VIKAS PROJECT)		
CONSULTANT	PMC PROJECTS HOWE INDIAPRINT LIMITED from vision to reality...		
NAME	SIGN	DATE	
DRN	VAP	25/09/17	
CHD	AM	25/09/17	
APD	SP	25/09/17	
TITLE			
IWT TERMINAL AT VARANASI			
POWER SINGLE LINE DIAGRAM IN PHASE-1A			
JOB. NO.	DRG. NO.		
I-525	VTR-233		
COORDINATE SYSTEM USED:			
ENTER CO-ORD SYSTEM HERE			
REV.	UNIT	SCALE - AS SHOWN	Size : A1
0			

SYMBOL	DESCRIPTION
-□-	FUSE
Σ	CURRENT TRANSFORMER
△	POTENTIAL TRANSFORMER
●	MOULDED CASE CIRCUIT BREAKER
⊗	INDICATION
◎	AIR CIRCUIT BREAKER
—○—	SURGE ARRESTER
cbct	CORE BALANCE CURRENT TRANSFORMER
(2)	UNDER VOLTAGE RELAY
(50)	INSTANTANEOUS OVER CURRENT RELAY
(50)	INSTANTANEOUS EARTH FAULT RELAY
(51)	IDMT OVER CURRENT RELAY
(51)	IDMT EARTH FAULT RELAY
(50)	OVER VOLTAGE RELAY
(60)	TRIP CIRCUIT SUP. RELAY
(60)	LOCK OUT RELAY
(94)	ANTI PUMPING RELAY
(60)	INSTANTANEOUS GROUND FAULT RELAY
(60)	DC FAIL RELAY
L1 ⊗	BREAKER ON RED
L2 ⊗	BREAKER OFF GREEN
L3 ⊗	BREAKER TRIP AMBER
L4 ⊗	SPRING CHARGED RED
L5 ⊗	TRIP CIRCUIT HEALTHY
L6 ⊗	BREAKER IN TEST POSITION
L7 ⊗	BREAKER IN SERVICE POSITION
L8 ⊗	DC FAIL
(50)	BREAKER CONTACT MULTIPLIER RELAY
□	TRIP NEUTRAL CLOSE SWITCH
□/□	LOCAL/REMOTE SELECTOR SWITCH
VSS	VOLTMETER SELECTOR SWITCH
V	VOLTMETER
ASS	AMMETER SELECTOR SWITCH
A	AMMETER
MFM	MULTI FUNCTION METER
—□—	VACUUM CIRCUIT BREAKER
□	ELECTRICAL & MECHANICAL INTERLOCK
□	CONTACTOR
AMF	AUTO MAINS FAILURE WITH CHANGE OVER SWITCH

ELECTRICAL SUBSTATION 2 (ESS2)

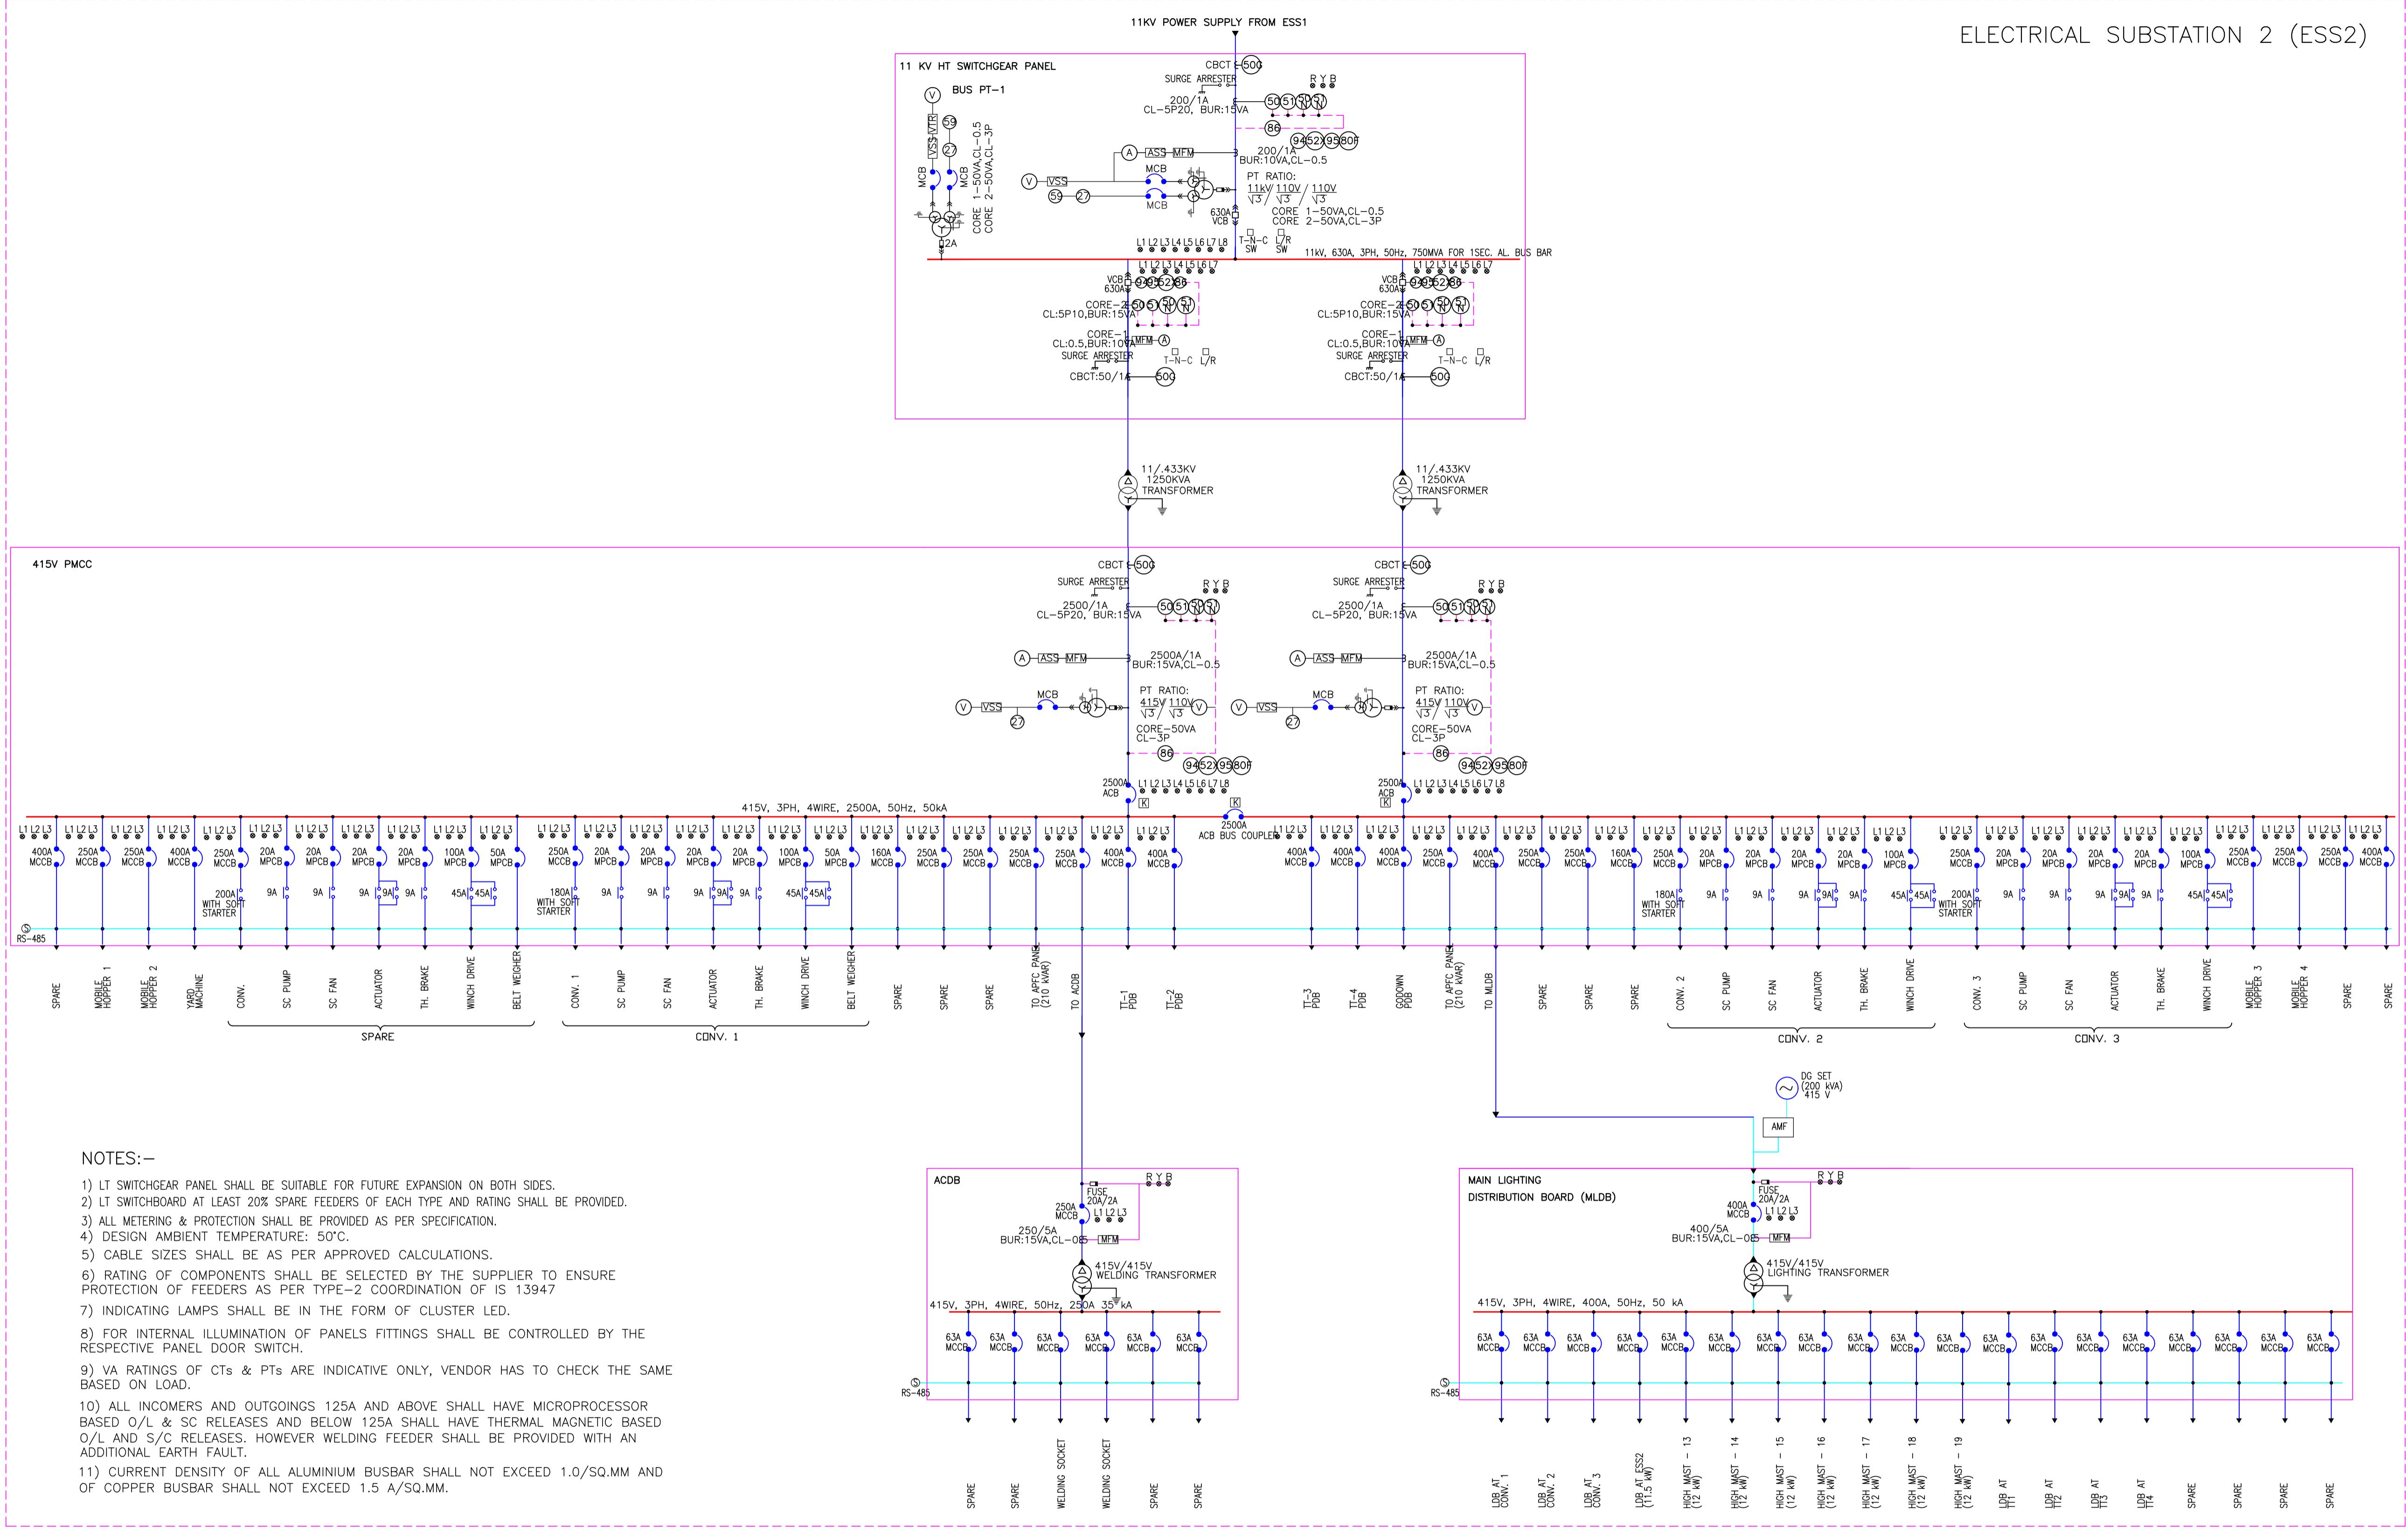

NOTES:-

- LT SWITCHGEAR PANEL SHALL BE SUITABLE FOR FUTURE EXPANSION ON BOTH SIDES.
- LT SWITCHBOARD AT LEAST 20% SPARE FEEDERS OF EACH TYPE AND RATING SHALL BE PROVIDED.
- ALL METERING & PROTECTION SHALL BE PROVIDED AS PER SPECIFICATION.
- DESIGN AMBIENT TEMPERATURE: 50°C.
- CABLE SIZES SHALL BE AS PER APPROVED CALCULATIONS.
- RATING OF COMPONENTS SHALL BE SELECTED BY THE SUPPLIER TO ENSURE PROTECTION OF FEEDERS AS PER TYPE-2 COORDINATION OF IS 13947
- INDICATING LAMPS SHALL BE IN THE FORM OF CLUSTER LED.
- FOR INTERNAL ILLUMINATION OF PANELS FITTINGS SHALL BE CONTROLLED BY THE RESPECTIVE PANEL DOOR SWITCH.
- VA RATINGS OF CTs & PTs ARE INDICATIVE ONLY, VENDOR HAS TO CHECK THE SAME BASED ON LOAD.
- ALL INCOMERS AND OUTGOINGS 125A AND ABOVE SHALL HAVE MICROPROCESSOR BASED O/L & SC RELEASES AND BELOW 125A SHALL HAVE THERMAL MAGNETIC BASED O/L AND S/C RELEASES. HOWEVER WELDING FEEDER SHALL BE PROVIDED WITH AN ADDITIONAL EARTH FAULT.
- CURRENT DENSITY OF ALL ALUMINIUM BUSBAR SHALL NOT EXCEED 1.0/SQ.MM AND OF COPPER BUSBAR SHALL NOT EXCEED 1.5 A/SQ.MM.

INLAND WATERWAYS AUTHORITY OF INDIA

PROJECT DETAILED FEASIBILITY STUDY FOR CAPACITY AUGMENTATION OF NATIONAL WATERWAY-1 AND DETAILED ENGINEERING FOR ITS ANCILLARY WORKS AND PROCESS BETWEEN HALDIA TO ALLAHABAD (JAL VIKAS PROJECT)


CONSULTANT	PMC PROJECTS HOWE	NAME	SIGN	DATE
		DRN	VAP	25/09/17
		CHD	AM	25/09/17
		APD	SP	25/09/17

TITLE IWT TERMINAL AT VARANASI

POWER SINGLE LINE DIAGRAM IN MASTER PLAN

REV. 0 DRG. NO. I-525 VTR-234

0	25/09/17	VAP	AM	SP
REV.	DATE	DESCRIPTION		
DRN	CHD	APD		
THIS DESIGN OR PROPERTY OF PMC PROJECTS HOWE				
IT IS SUBJECT TO THEIR RECALL OR REPRODUCTION WITHOUT THEIR WRITTEN PERMISSION.				
ENTER CO-ORD SYSTEM HERE				
UNIT	SCALE - AS SHOWN	Size : A1	REV. 0	

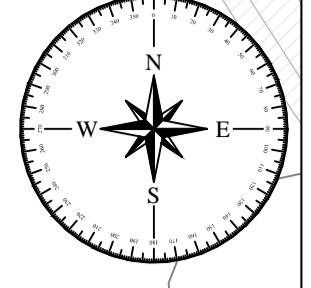




SR NO	SYMBOL	DESCRIPTION
1		HIGH MAST
2		CCTV
3		HUME PIPE FOR RAIL / ROAD CROSSING

NOTES:


1. ALL DIMENSIONS ARE IN METRE
2. ALL LEVELS ARE IN METRE & ARE WITH RESPECT TO MSL
3. CCTV LOCATIONS SHOWN IN MASTER PLAN IS TENTATIVE
4. PHASE 1A - HIGH MAST 1 TO 5
PHASE 1B - HIGH MAST 6 TO 12
FINAL PHASE - HIGH MAST 13 TO 19

RIVER GANGA

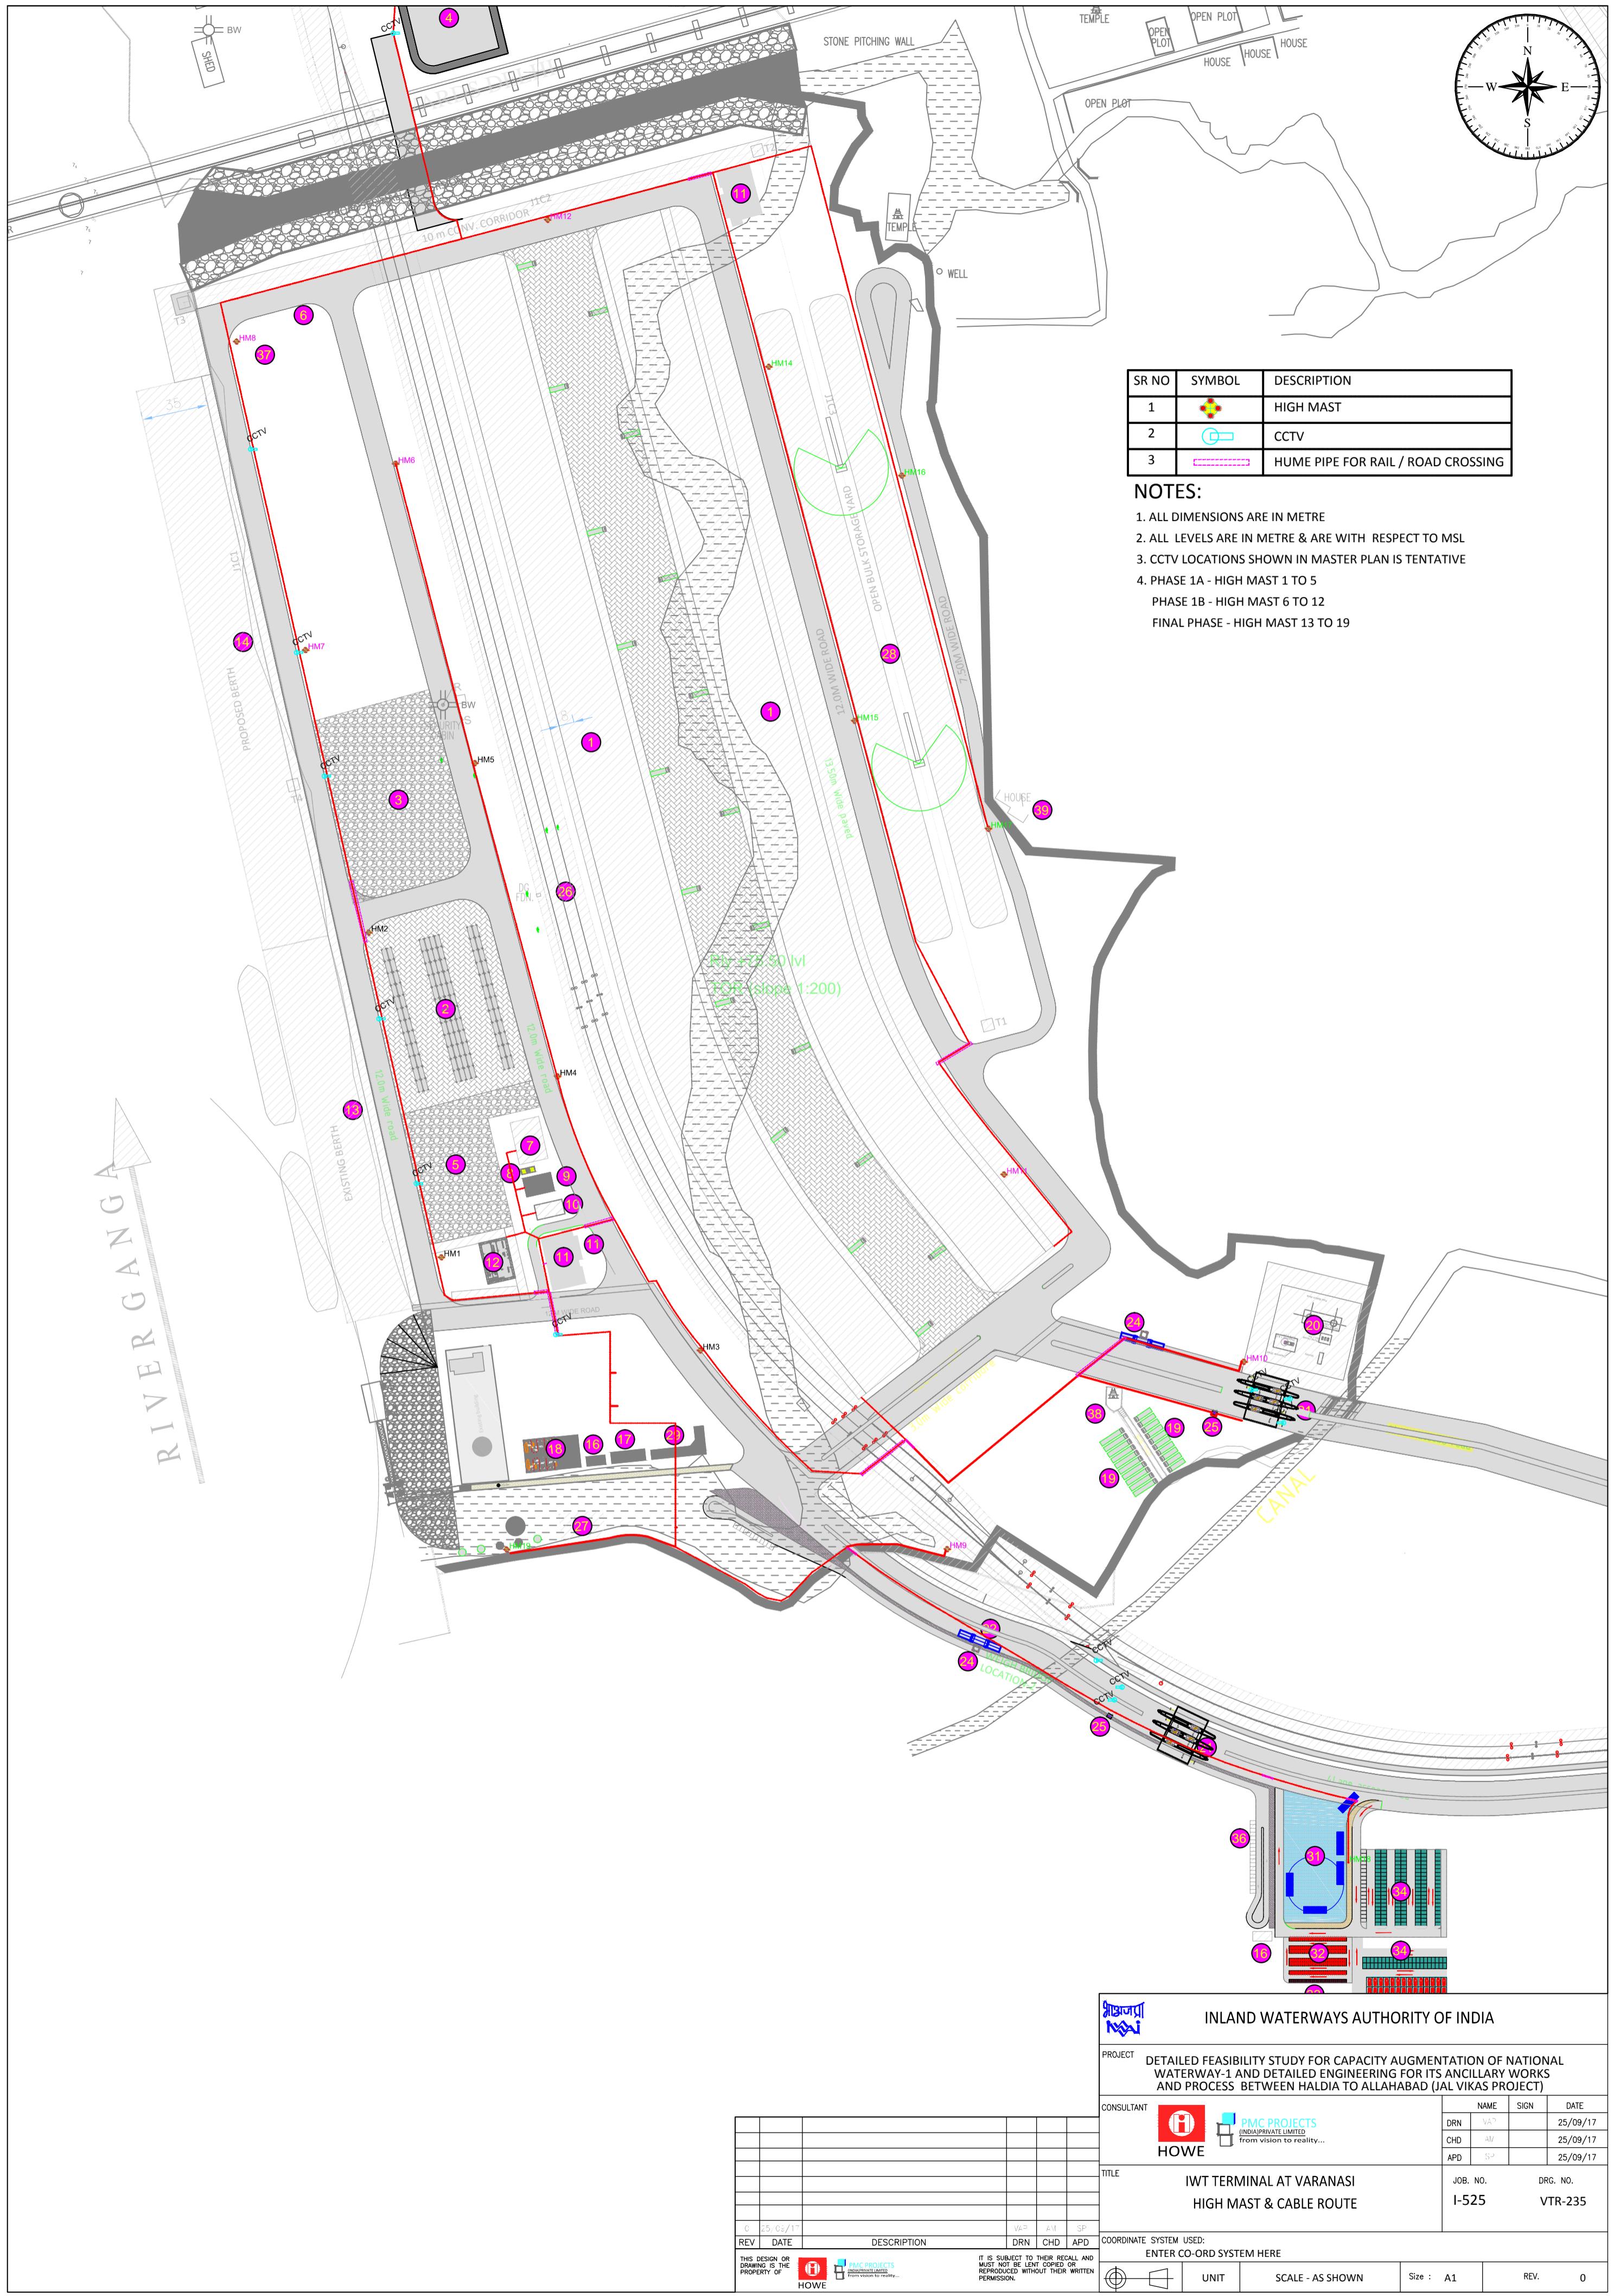

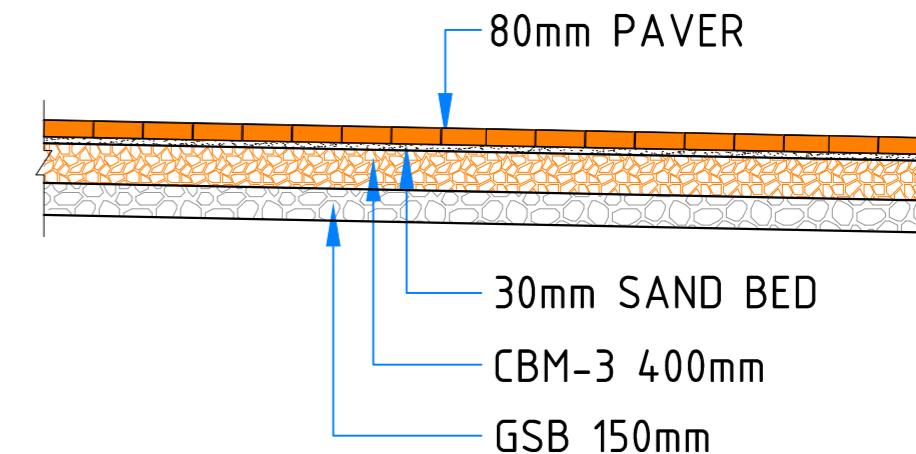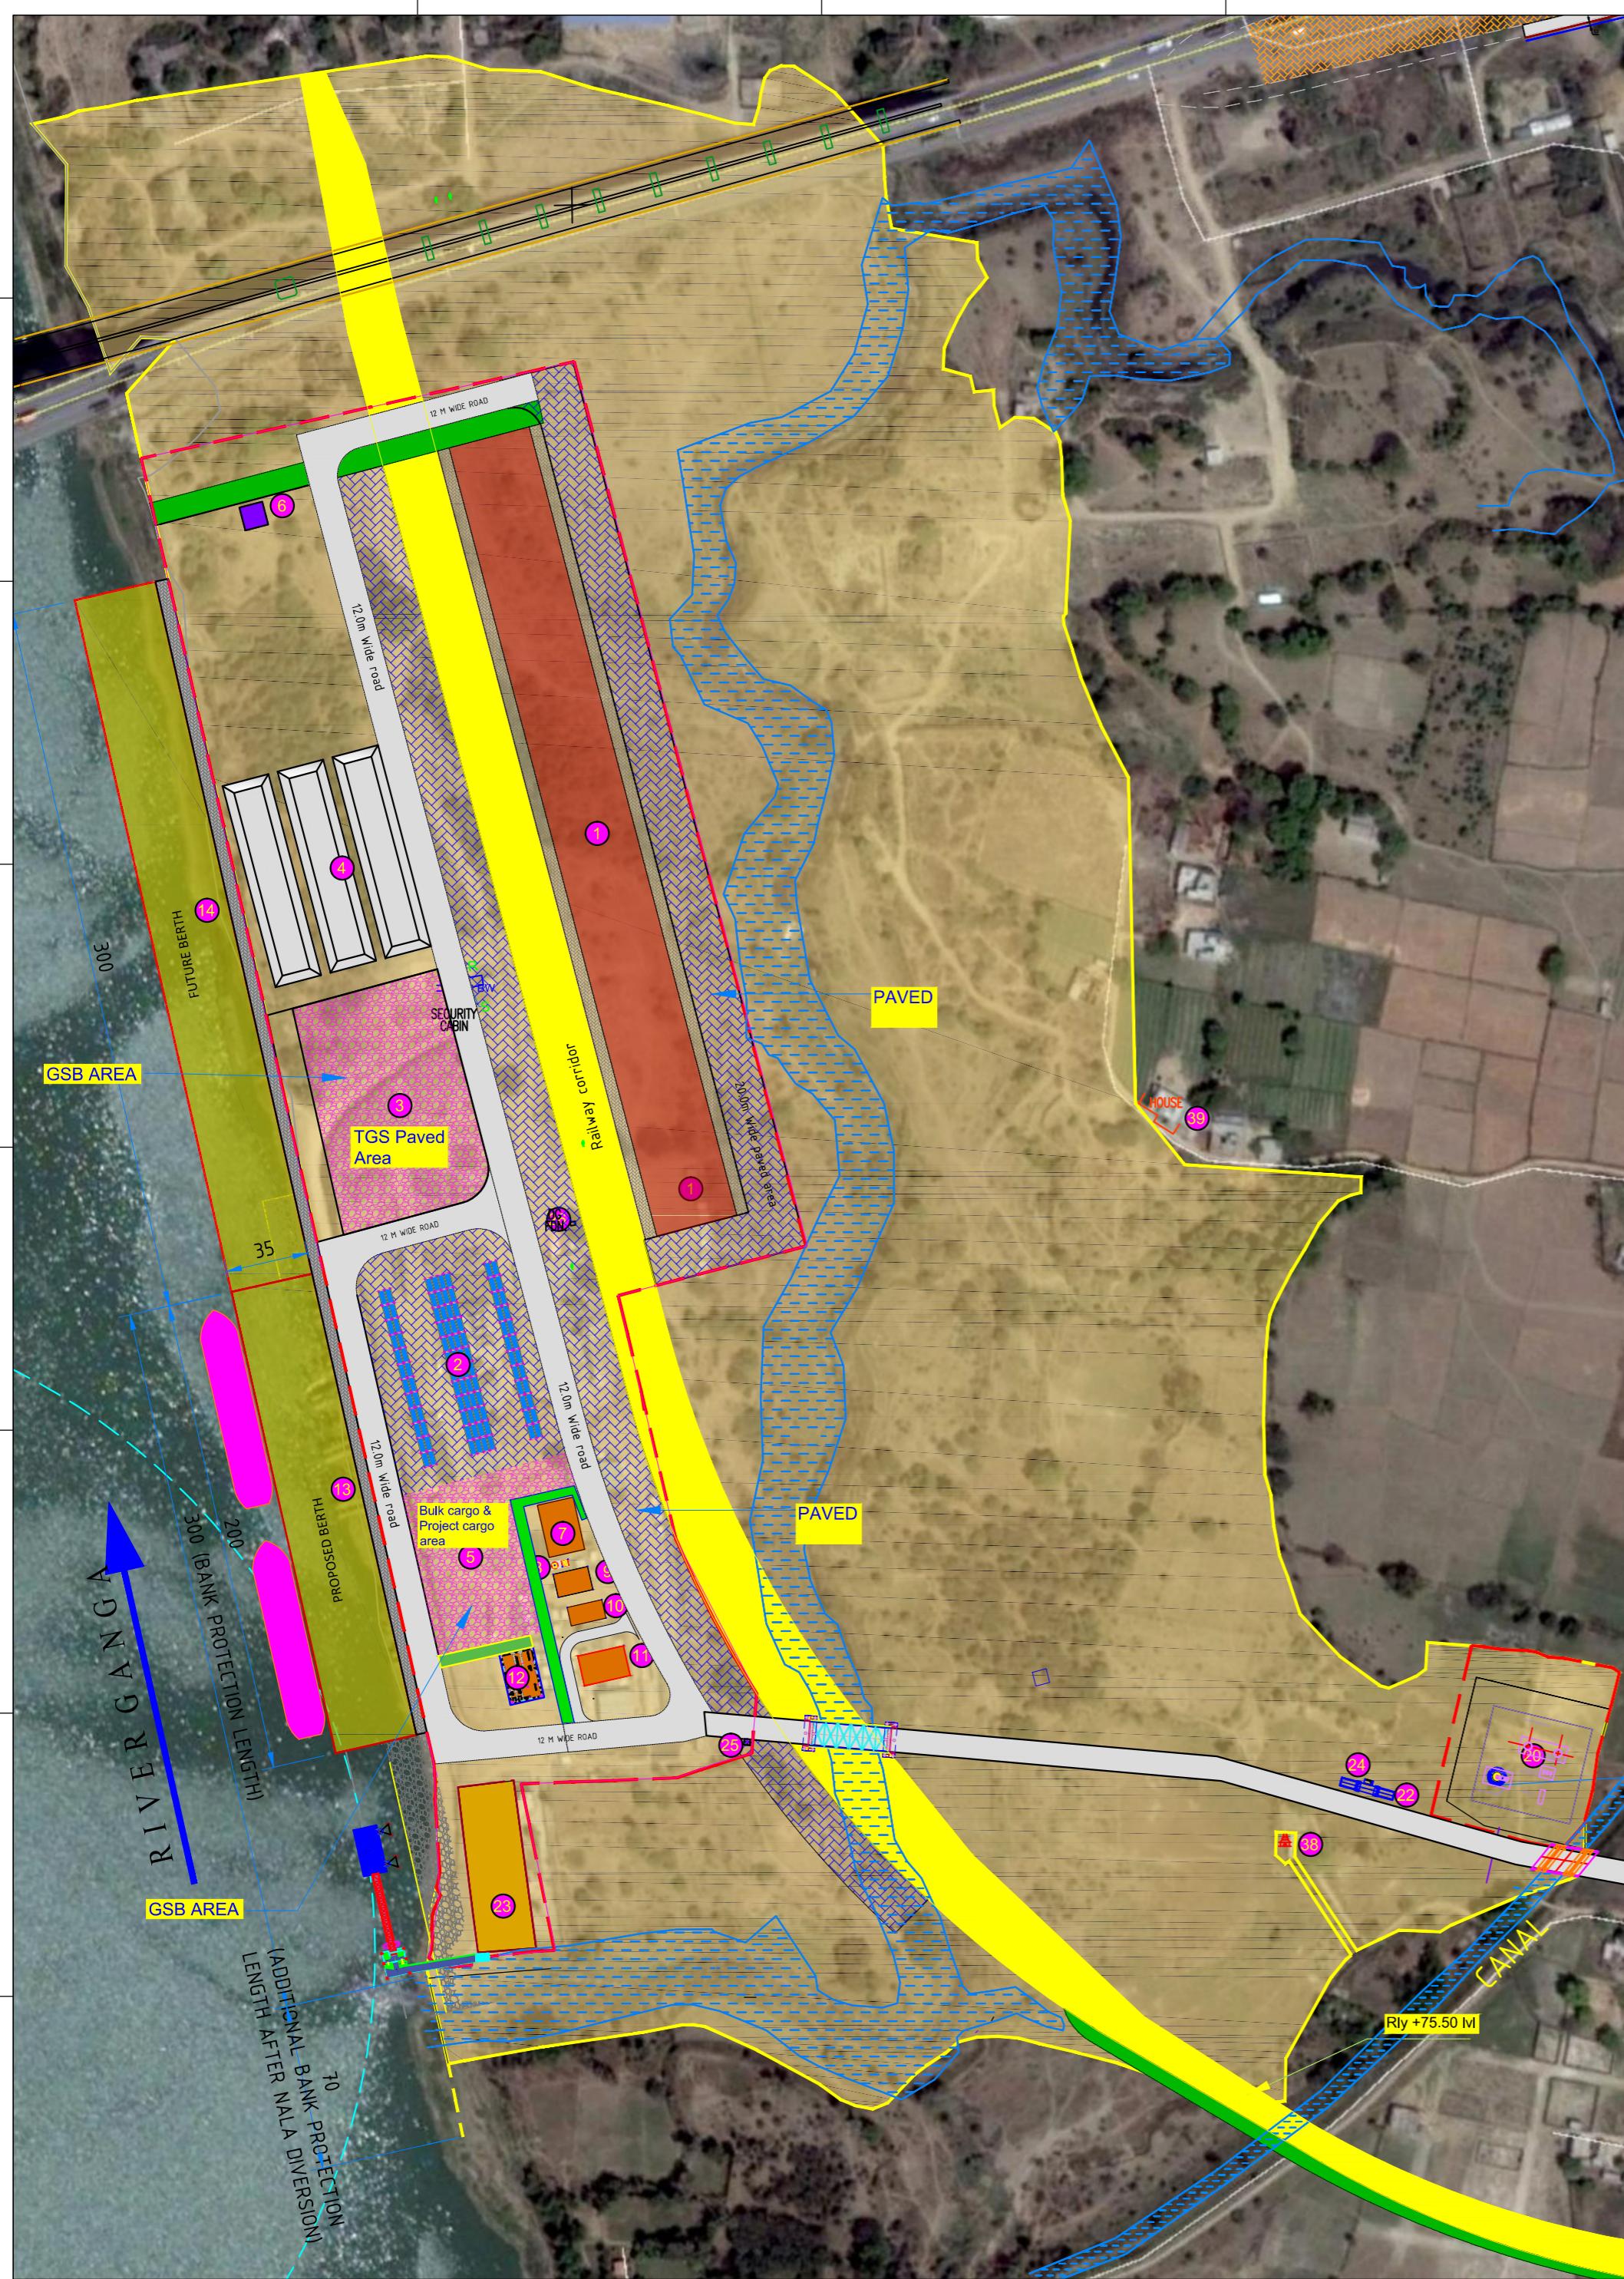


TYPICAL PAVED FOR YARD DEVELOPMENT SECTION

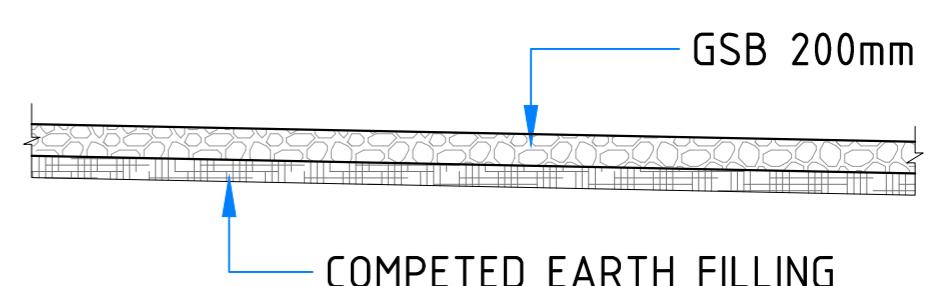

TYPICAL BULK & PROJECTS CARGO STORAGE YARD

NOTES

- ALL DIMENSIONS ARE IN MILLIMETRE
- ALL LEVELS ARE IN METRE WITH & ARE RESPECT TO MSL

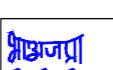

INLAND WATERWAYS AUTHORITY OF INDIA

PROJECT DETAILED FEASIBILITY STUDY FOR CAPACITY AUGMENTATION OF NATIONAL WATERWAY-1 AND DETAILED ENGINEERING FOR ITS ANCILLARY WORKS AND PROCESS BETWEEN HALDIA TO ALLAHABAD (JAL VIKAS PROJECT)

CONSULTANT

HOWE PMC PROJECTS
INDIA PRIVATE LIMITED
from vision to reality...

IT

IWT TERMINAL AT VARANASI
YARD DEVELOPMENT DETAIL (PHASE-1B)

REV

DATE

0

16/01/17

DRN

CHD

APD

SP

16/01/17

NAVE

VAP

DATE

16/01/17

RDC

NO.

I-525

VTR-236

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DATE

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16/01/17

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I-525

VTR-236

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I-525

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I-525

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VTR-236

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APD

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NAVE

VAP

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RDC

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I-525

VTR-236

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RDC

NO.

I-525

VTR-236

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DRN

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RDC

NO.

I-525

VTR-236

AV

SD

REV


DATE

0

16/01/17

DRN

CHD

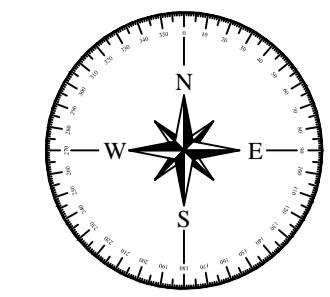

FACILITIES

- (1) GODEWN-1
 - (2) CONTAINER HANDLING AREA 64TGS 3400 SQMT
 - (3) BULK CARGO (CONSUMER GOODS) 6000 SQMT
 - (4) BULK CARGO (CONSTRUCTION MATERIAL) 9000 SQMT
 - (5) PROJECT CARGO 3000 SQMT
 - (6) STP
 - (7) UNDER GROUND WATER TANK
 - (8) SOAK PIT & SEPTIC TANK
 - (9) WORKERS AMENITY
 - (10) PUMP ROOM
 - (11) SUB-STATION
 - (12) ADMINISTRATION BUILDING
 - (13) PROPOSED BERTH
 - (14) FUTURE BERTH
 - (20) PROPOSED FUELSTATION
 - (22) WEIGH BRIDGE
 - (23) EXISTING BUILDING
 - (24) WEIGH BRIDGE CABIN
 - (25) SECURITY OFFICE
 - (38) EXISTING PUBLIC TEMPLE
 - (39) EXISTING HOUSE

NOTES:

NOTES:



INLAND WATERWAYS AUTHORITY OF INDIA

PROJECT DETAILED FEASIBILITY STUDY FOR CAPACITY AUGMENTATION OF NATIONAL WATERWAY-1 AND DETAILED ENGINEERING FOR ITS ANCILLARY WORKS AND PROCESS, BETWEEN HAMBIA TO ALLAHABAD (HALVIKAS PROJECT)

AND PROCESS BETWEEN HALDIA TO ALLAHABAD (JAL VIKAS PROJECT)			
CONSULTANT	 HOWE	 PMC PROJECTS (INDIA)PRIVATE LIMITED from vision to reality...	Name
			Sign
		DRN	VAP
		CHD	SP
			27/0

TITLE	IWT TERMINAL AT VARANASI SEWAGE COLLECTION SYSTEM	APD	35	27/0
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SEWERAGE COLLECTION SYSTEM	I-525	VTR-23
COORDINATE SYSTEM USED:		


ENTER CO-ORD SYSTEM HERE				
	UNIT	SCALE - AS SHOWN	Size : A1	REV.

LEGEND

SEWAGE PUMPING PIPE LINE

SEWAGE GRAVITY PIPE LINE



MANHOLE CHAMBER

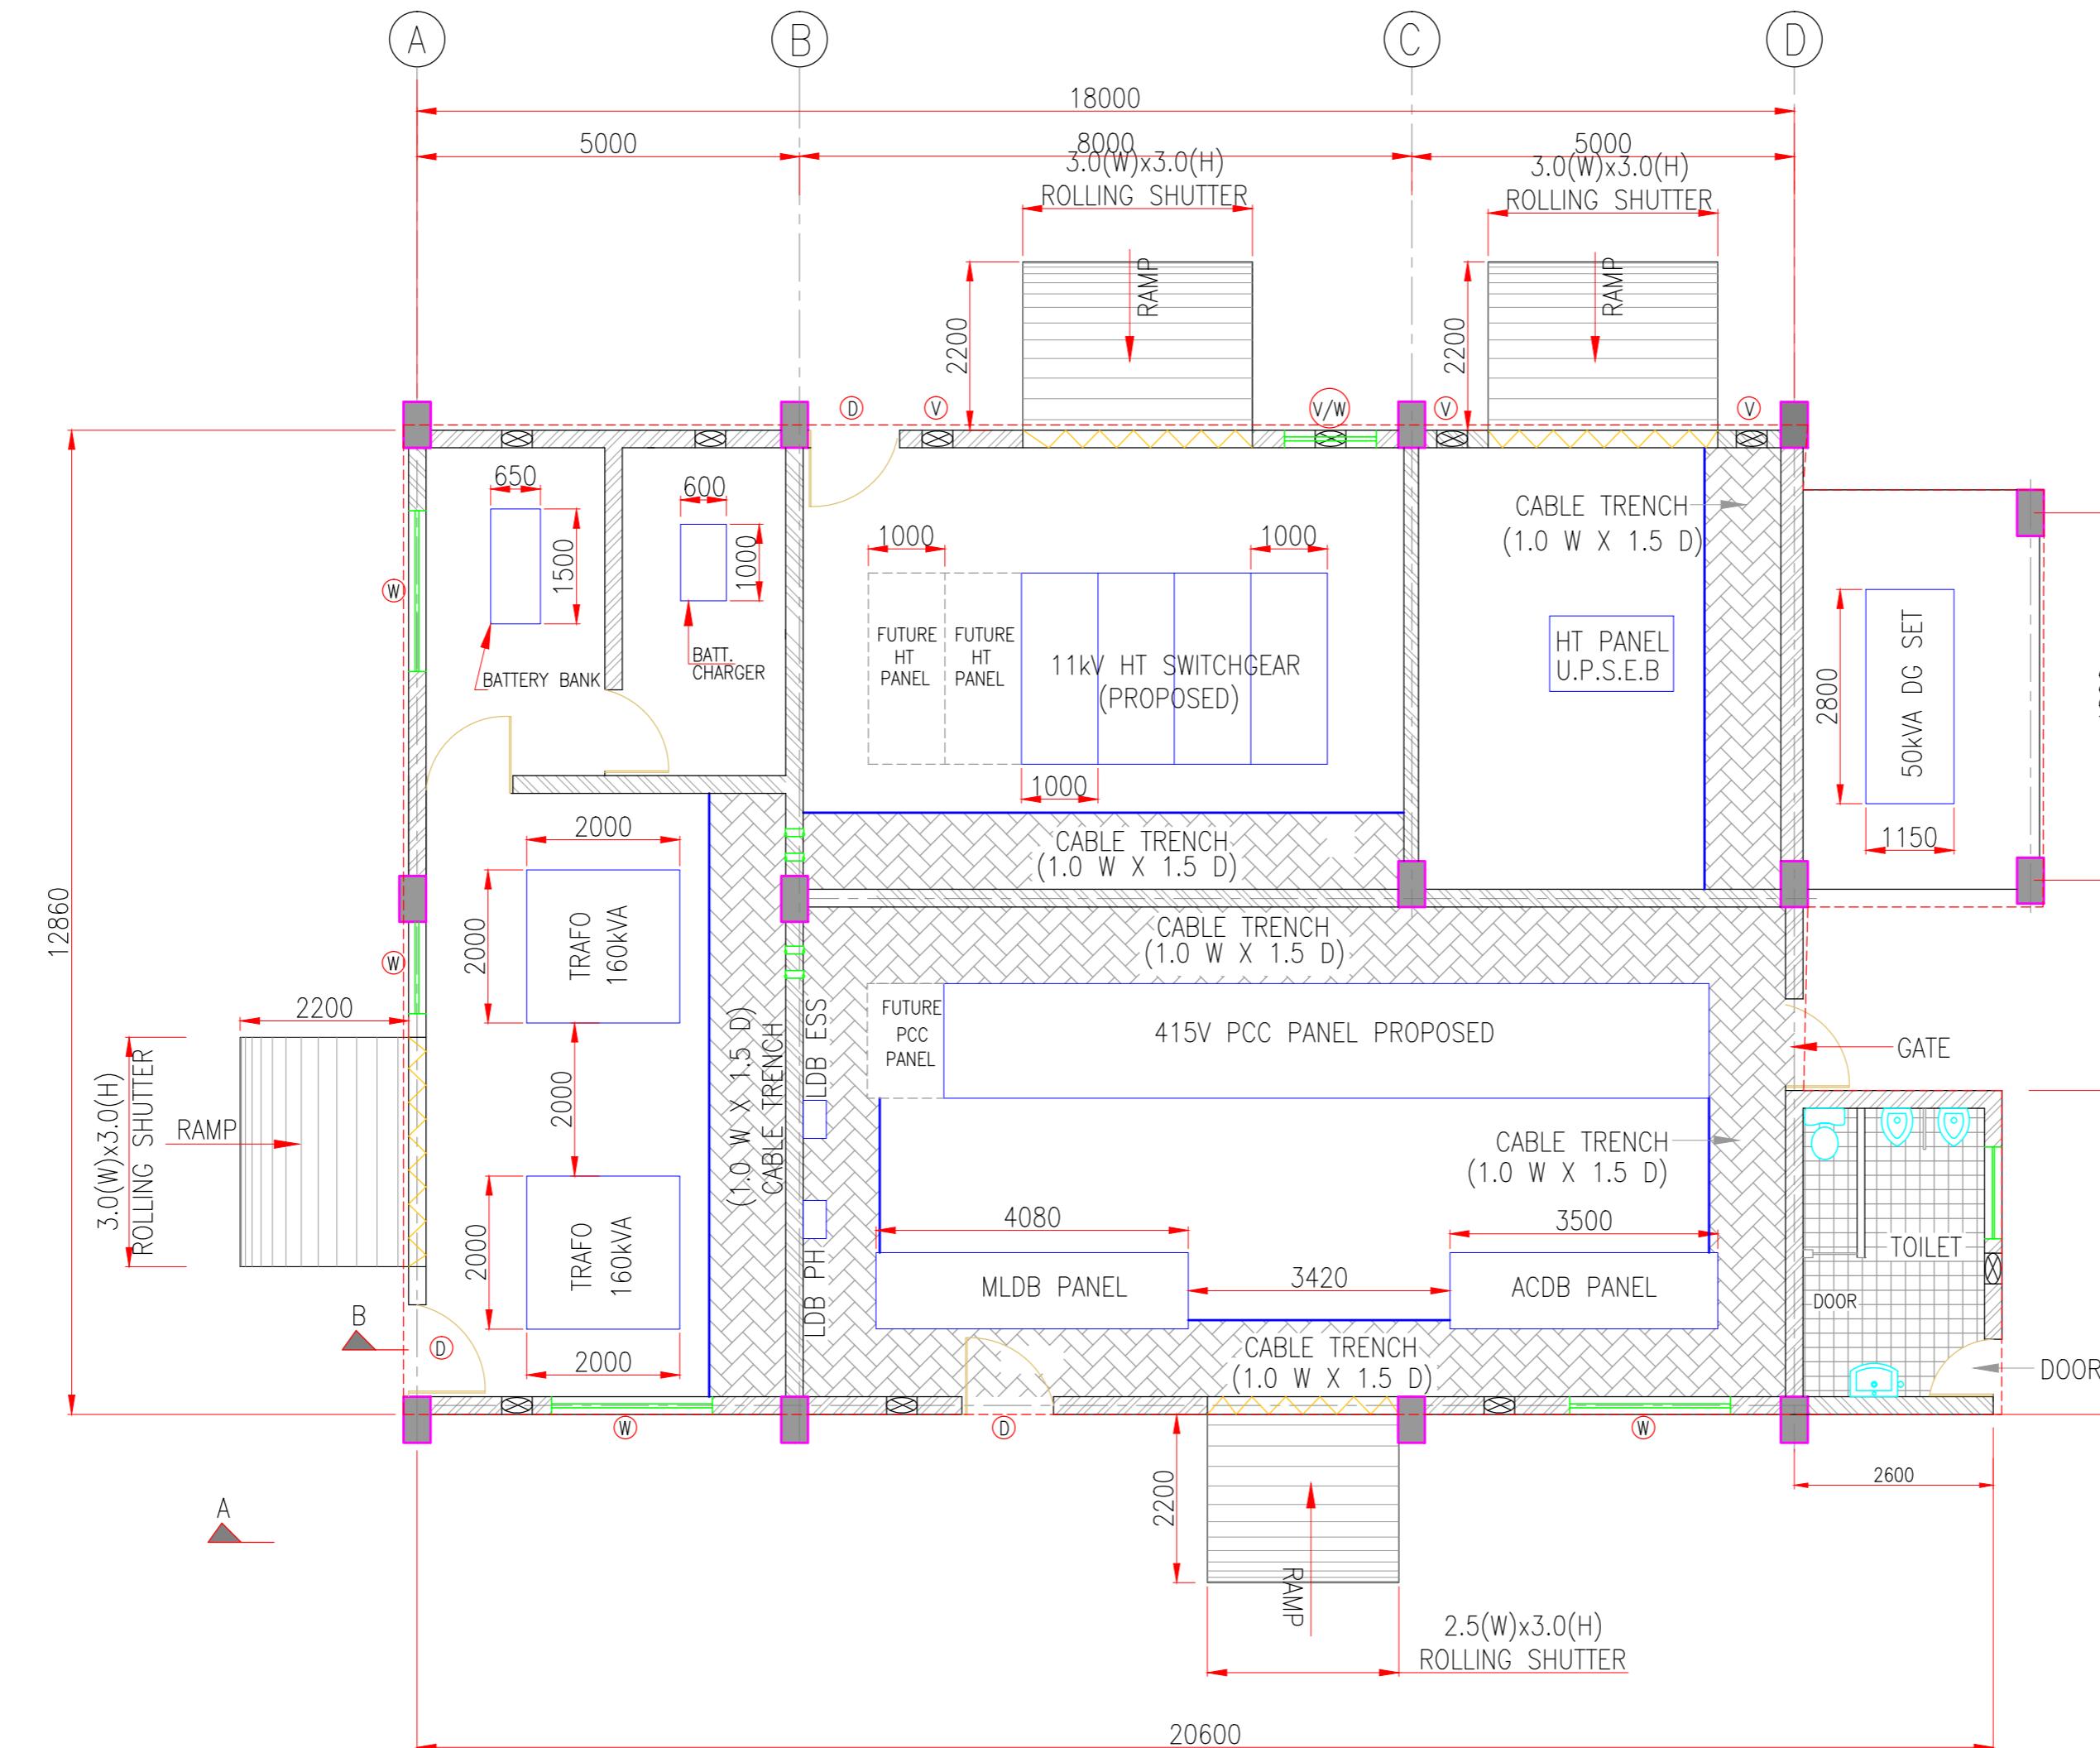

NOTES

- ALL DIMENSIONS ARE IN MILLIMETRE
- ALL LEVELS ARE IN METRE WITH & ARE RESPECT TO MSL

	INLAND WATERWAYS AUTHORITY OF INDIA																	
PROJ ID: DETAILED FEASIBILITY STUDY FOR CAPACITY AUGMENTATION OF NATIONAL WATERWAY-1 AND DETAILED ENGINEERING FOR ITS ANCILLARY WORKS AND PROCESS BETWEEN HALDIA TO ALLAHABAD (JAL VIKAS PROJECT)																		
CONSULTANT	HOWE	PMC PROJECTS INDIA PRIVATE LIMITED from vision to reality...	<table border="1"> <tr> <td>REV. DATE</td> <td>0 16/01/17</td> <td>VAP</td> <td>AM</td> <td>SP</td> </tr> <tr> <td colspan="5">THIS DESIGN OR DRAWING IS THE PROPERTY OF HOWE</td> </tr> <tr> <td colspan="5">IT IS SUBJECT TO THEIR RECALL AND MUST NOT BE LENT COPIED OR REPRODUCED WITHOUT THEIR WRITTEN PERMISSION.</td> </tr> </table>	REV. DATE	0 16/01/17	VAP	AM	SP	THIS DESIGN OR DRAWING IS THE PROPERTY OF HOWE					IT IS SUBJECT TO THEIR RECALL AND MUST NOT BE LENT COPIED OR REPRODUCED WITHOUT THEIR WRITTEN PERMISSION.				
REV. DATE	0 16/01/17	VAP	AM	SP														
THIS DESIGN OR DRAWING IS THE PROPERTY OF HOWE																		
IT IS SUBJECT TO THEIR RECALL AND MUST NOT BE LENT COPIED OR REPRODUCED WITHOUT THEIR WRITTEN PERMISSION.																		
IWT TERMINAL AT VARANASI ELECTRICAL SUBSTATION PLAN (ESS-1) (PHASE-1A)			L.C.R. NO. I-525 D.P.G. NO. VTR-238															
ENTER CO-ORD SYSTEM HERE																		
	UNIT	SCALE - AS SHOWN	Size : A1	P.P.V. 0														

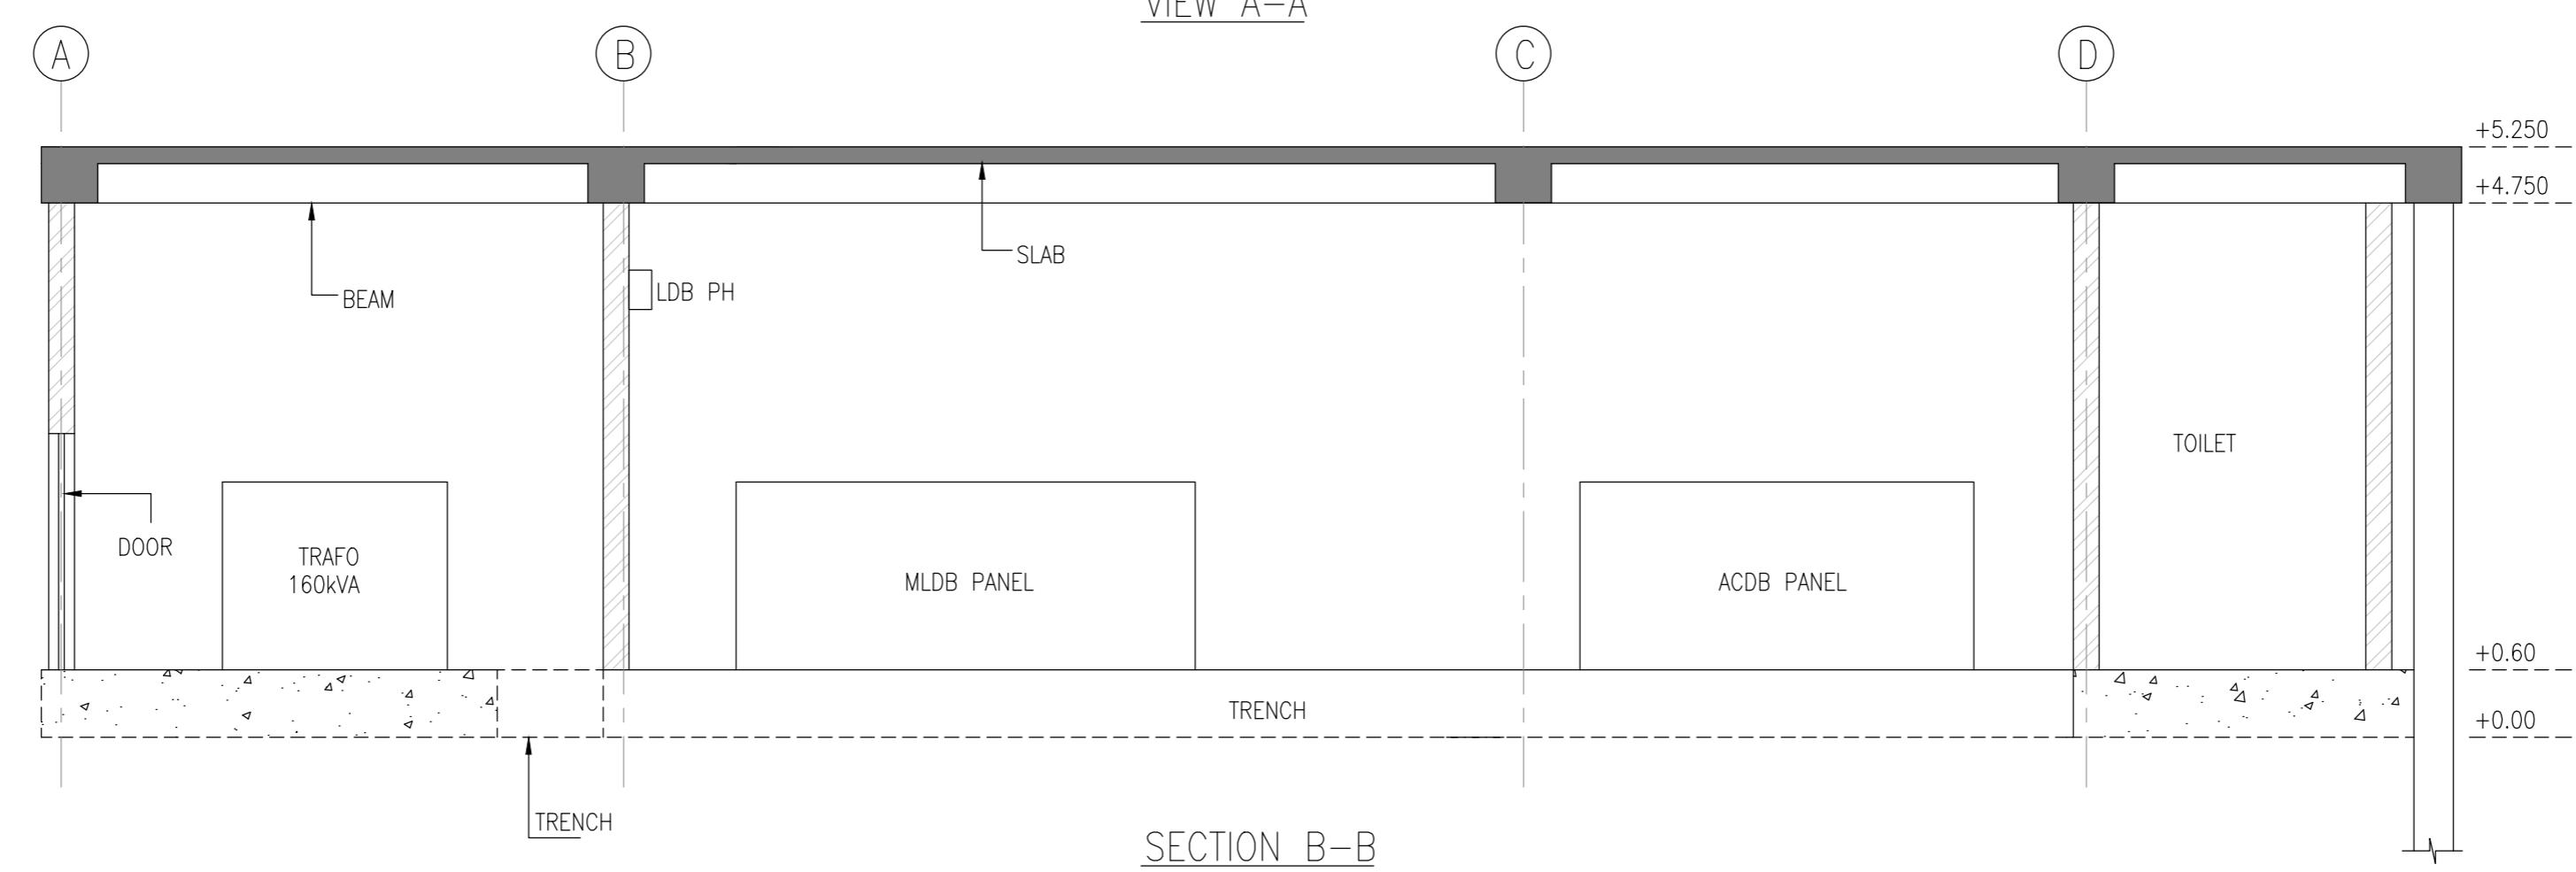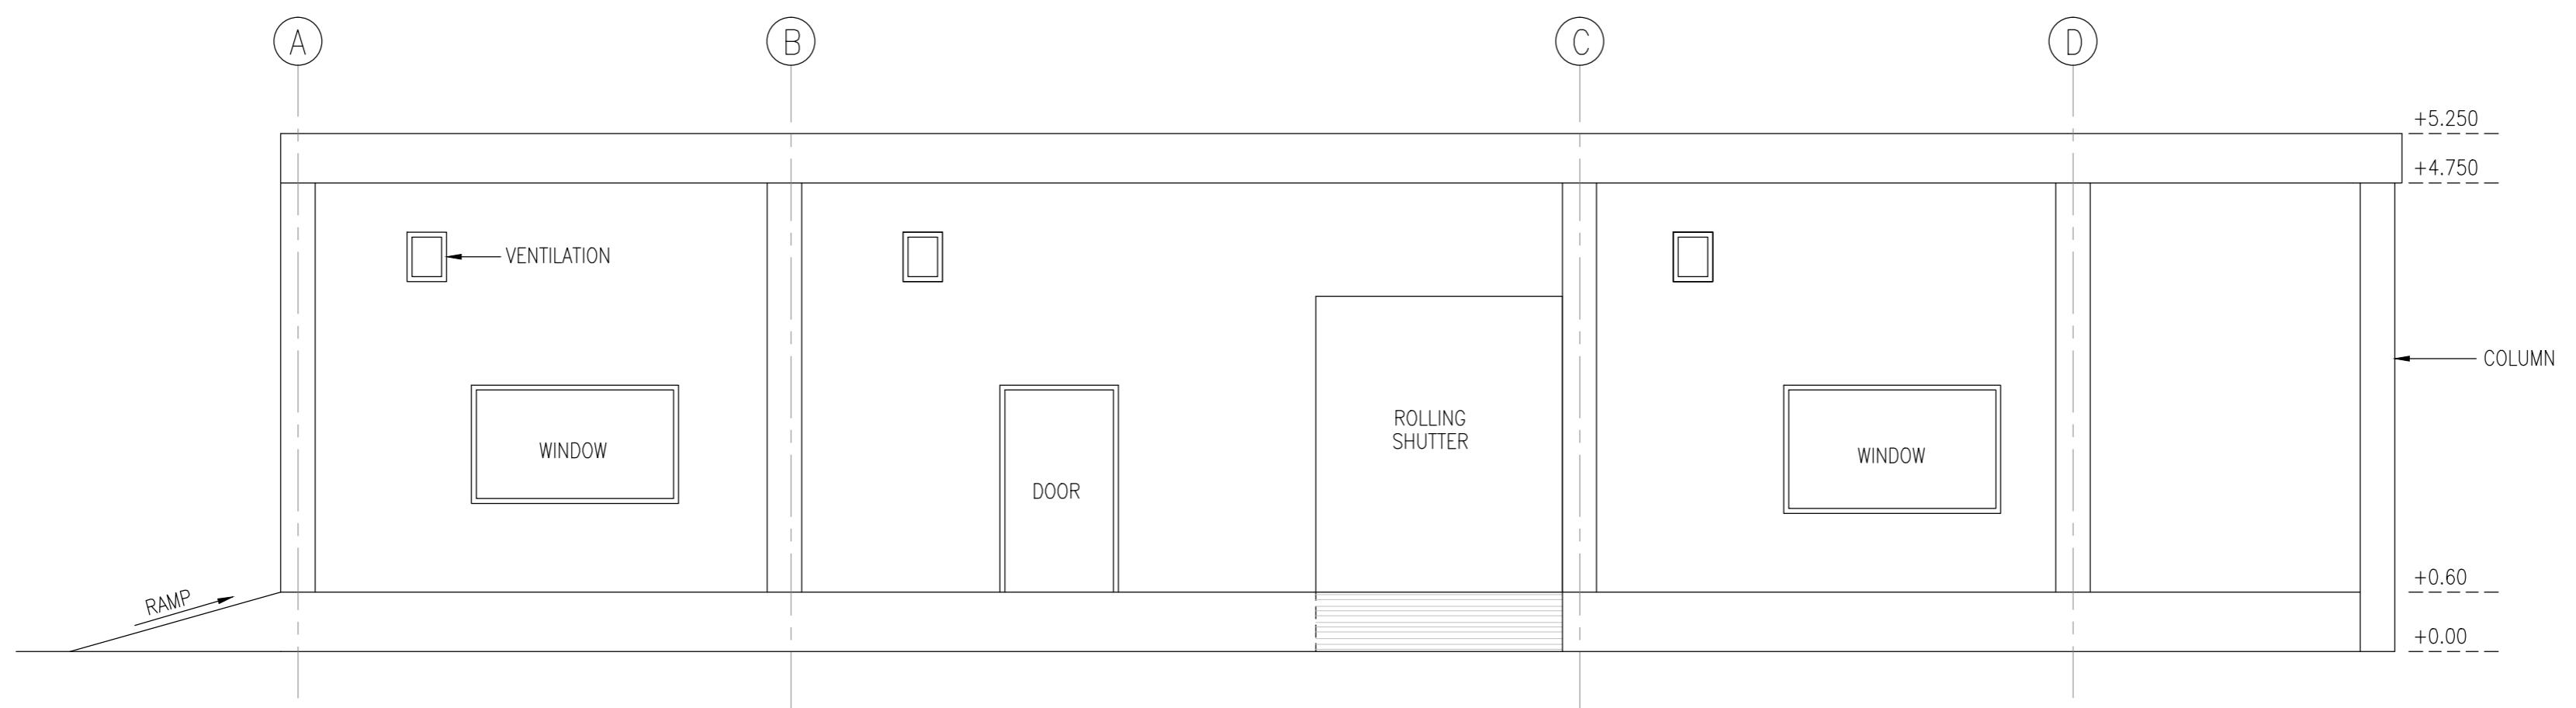

NOTES

- ALL DIMENSIONS ARE IN MILLIMETRE
- ALL LEVELS ARE IN METRE WITH & ARE RESPECT TO MSL



INLAND WATERWAYS AUTHORITY OF INDIA

PROJECT DETAILED FEASIBILITY STUDY FOR CAPACITY AUGMENTATION OF NATIONAL WATERWAY-1 AND DETAILED ENGINEERING FOR ITS ANCILLARY WORKS AND PROCESS BETWEEN HALDIA TO ALLAHABAD (JAL VIKAS PROJECT)

CONSULTANT

PMC PROJECTS
INDIA PRIVATE LIMITED
from vision to reality...
HOWE

REV.	DATE	DESCRIPTION	DRW.	C.H.D.	APPROV.	NAME	SIGN.	DATE
0	16/01/17		VAP	AM	SP			






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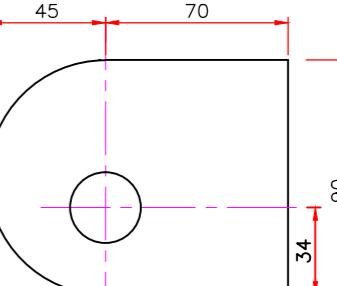
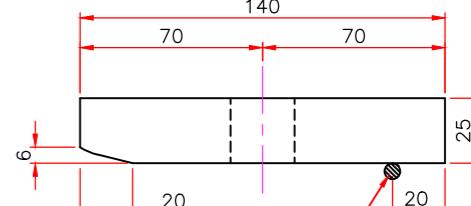
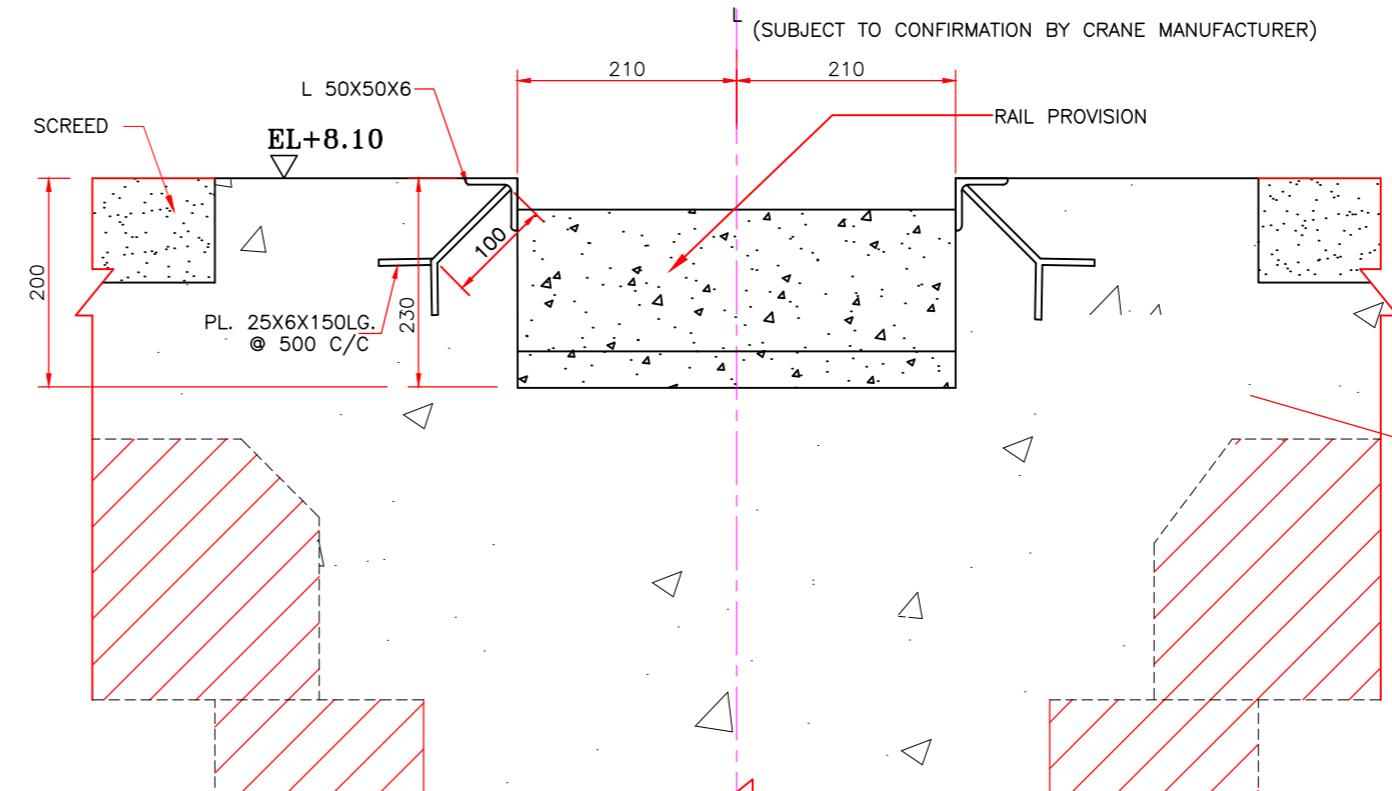
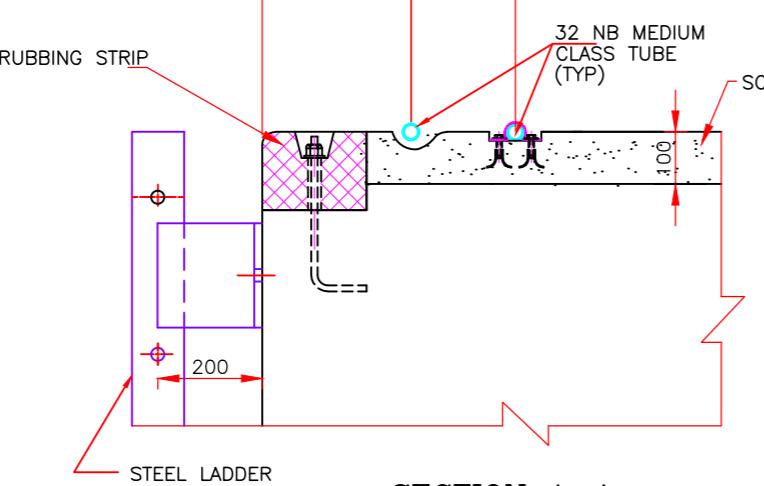
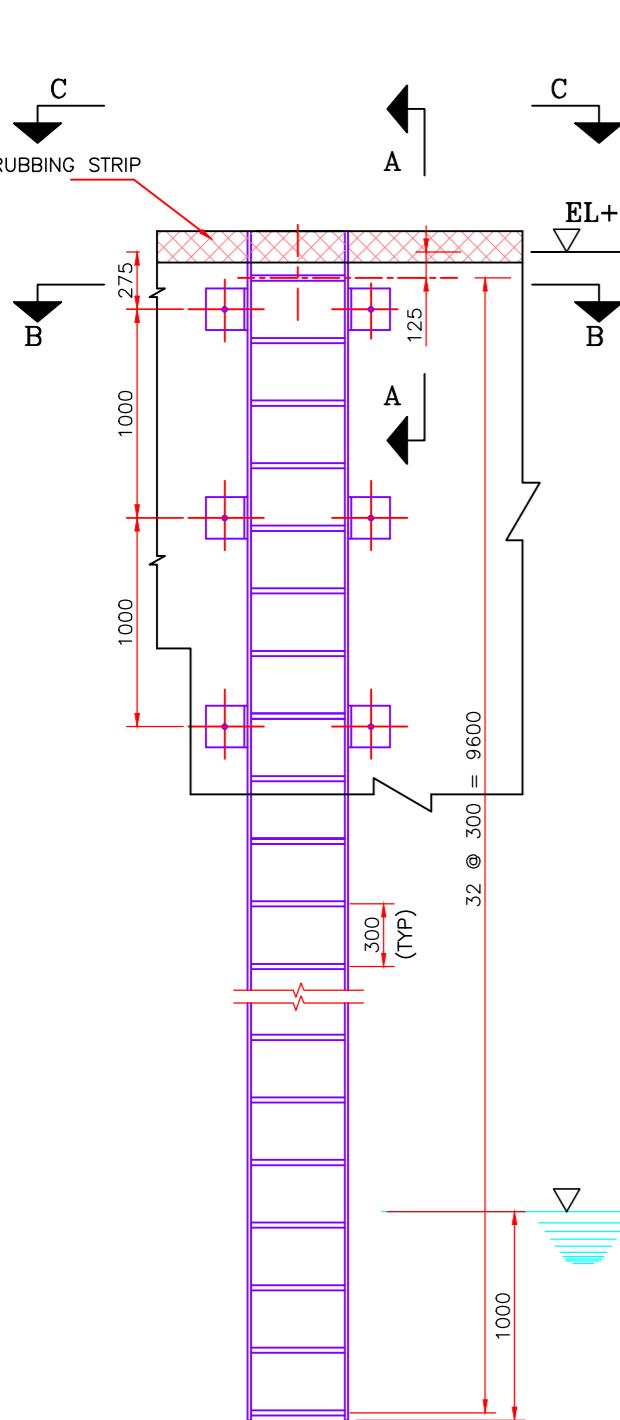
UNIT	SCALE - AS SHOWN	Size : A1	P.F.V. : 0

PROPOSED SCHEDULE OF FINISHING MATERIALS				
GROUND FLOOR	1	COMMON ROOM	VITRIFIED PORCELAIN TILES	PLASTIC EMULSION PAINTS
	2	FIRST-AID ROOM	VITRIFIED PORCELAIN TILES	PLASTIC EMULSION PAINTS
	3	TOILETS	WHITE MARBLE	FULL HEIGHT CERAMIC TILES
	4	BATH	WHITE MARBLE	FULL HEIGHT CERAMIC TILES
TERRACE FLOOR	1	TERRACE	BRICK TILES/ CHINA MOSAIC	
OUT SIDE FINISHING	1	CEMENT ROUGH PLASTERS IN TWO COATS WITH WEATHER PROOF PAINT		
	2	FLIGHT OF STEPS IN THE FRONT FINISHED WITH WHITE MARBLE		
	3	COLOUR ANODIZED COATED ALUMINUM WINDOWS WITH 5 MM THICK FLOAT GLASS		
	4	LARGE CLEAR GLAZING AS REQUIRED IN ELEVATION WITH COLOR ALUMINUM COATED ALUMINUM FRAMES		


OPENING SCHEDULE				
S.NO	TYPE	SIZE	CILL LEVEL	LINTEL LEVEL
1.	D1	750 X 2100		2100
2.	D2	900 X 2100		2100
3.	D3	1000 X 2100		2100
4.	W2	500 X 1200	900	2100
5.	W3	1000 X 1200	900	2100
6.	V1	800 X 450	1650	2100




NOTES			
1. ALL DIMENSIONS ARE IN MILLIMETRE			
2. ALL LEVELS ARE IN METRE WITH & ARE RESPECT TO MSL			
 INLAND WATERWAYS AUTHORITY OF INDIA			
PROJECT DETAILED FEASIBILITY STUDY FOR CAPACITY AUGMENTATION OF NATIONAL WATERWAY-1 AND DETAILED ENGINEERING FOR ITS ANCILLARY WORKS AND PROCESS BETWEEN HALDIA TO ALLAHABAD (JAL VIKAS PROJECT)			
CONSULTANT	PMC PROJECTS INDIA PRIVATE LIMITED from vision to reality...	DRN	VAP
HOWE		16/01/17	16/01/17
CHD	KP	16/01/17	16/01/17
AFD	SP	16/01/17	16/01/17
IWT TERMINAL AT VARANASI WORKERS AMENITY BLOCK (PHASE-1A)			
JOB. NO. I-525		DRC. NO. VTR-240	
COORDINATE SYSTEM USED ENTER CO-ORD SYSTEM HERE			
UNIT	SCALE - AS SHOWN	Size : A1	P.F.V. 0

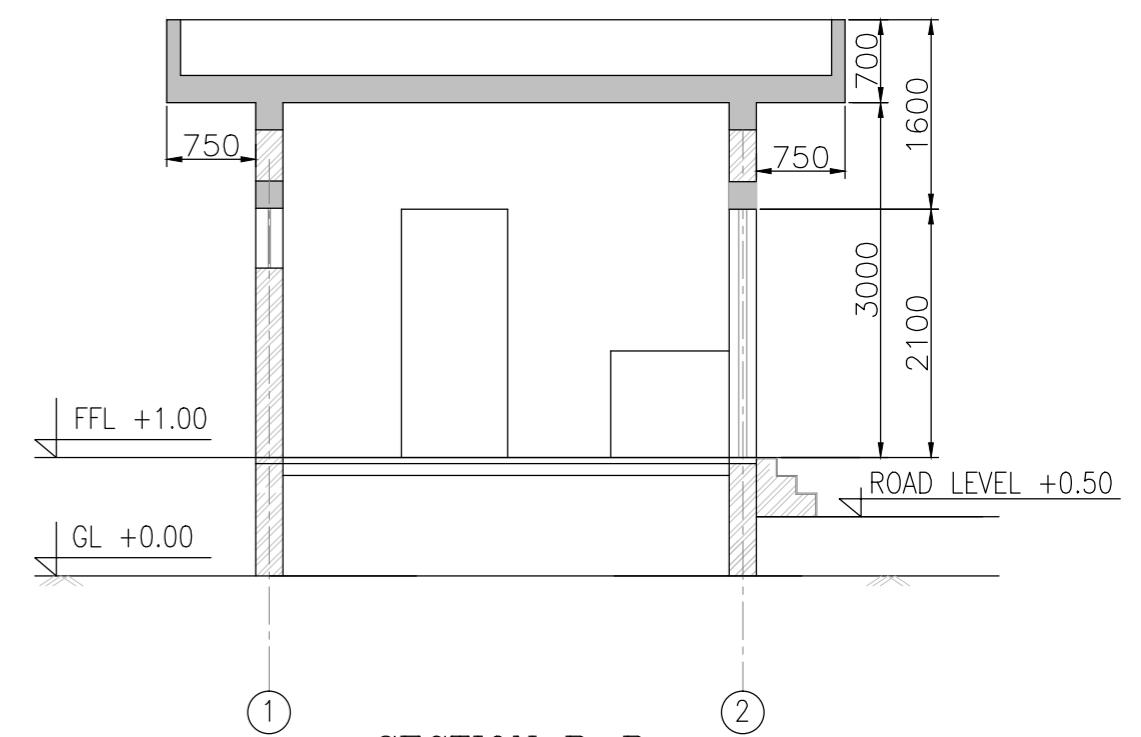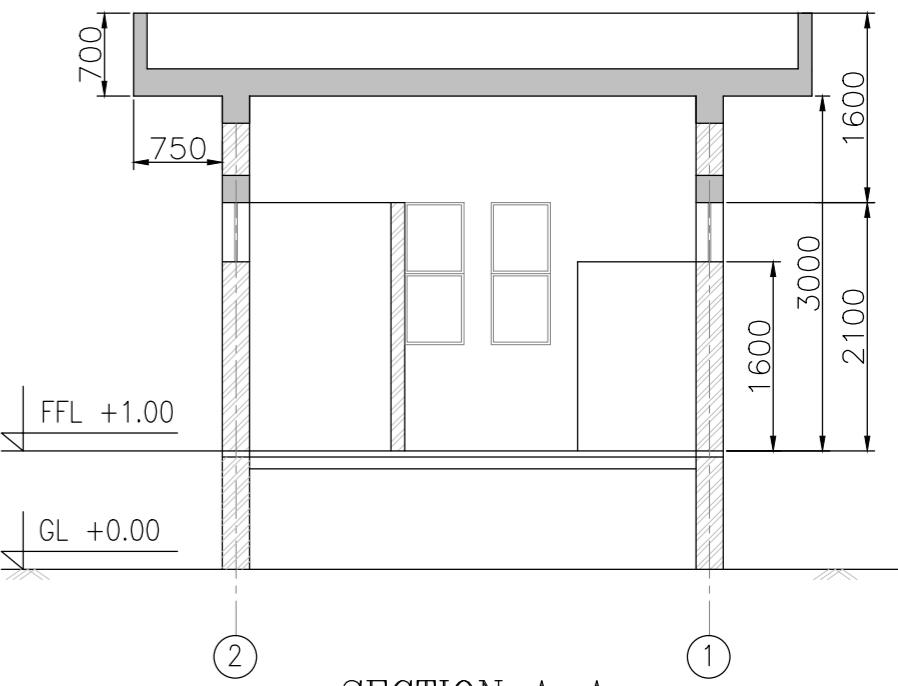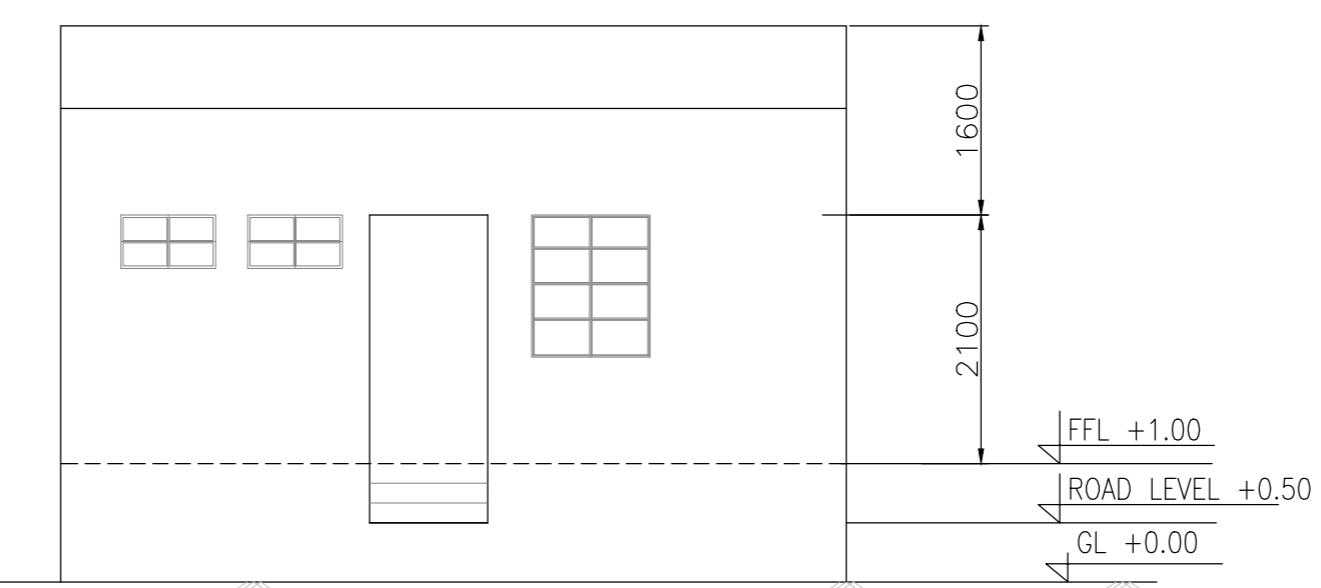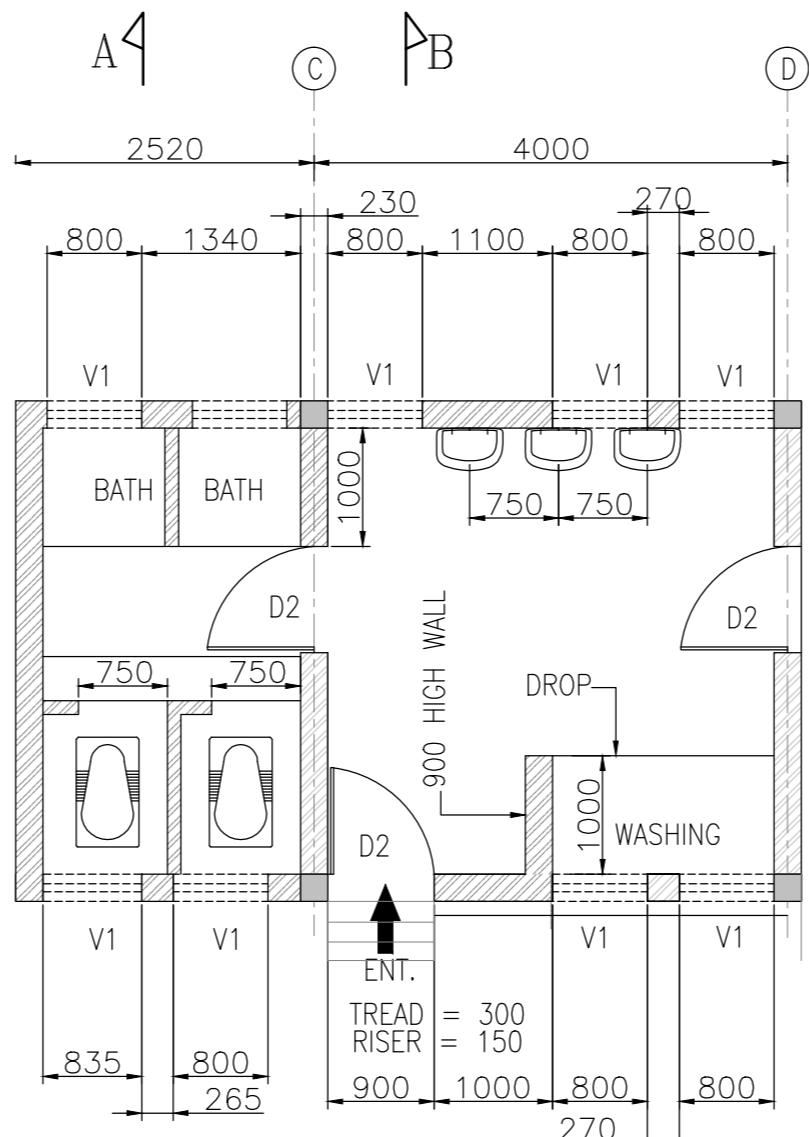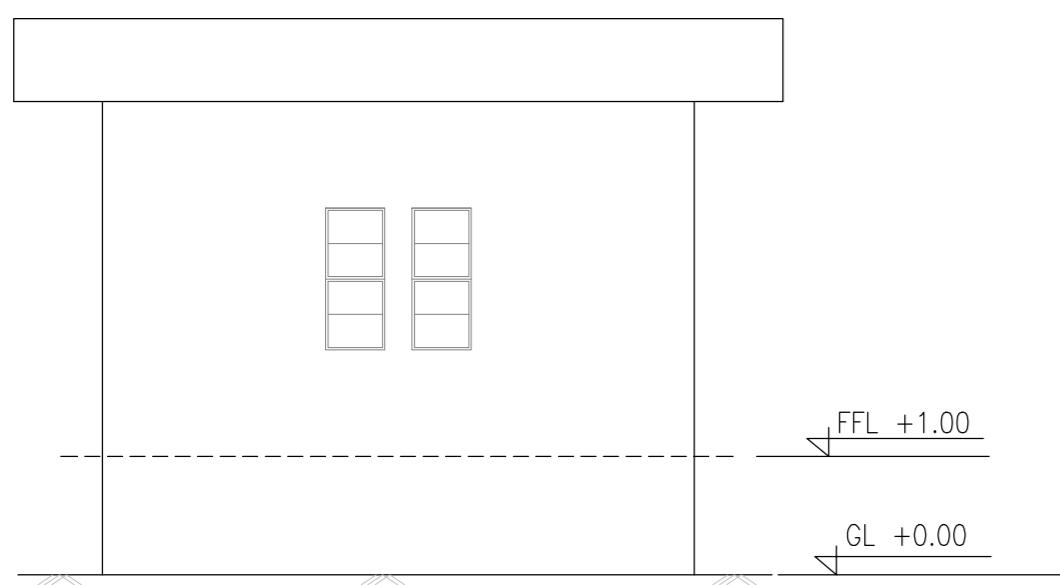


SCALE 1:2
TO BE TACK WELDED TO BASE PLATE
AFTER ALIGNMENT OF RAIL.

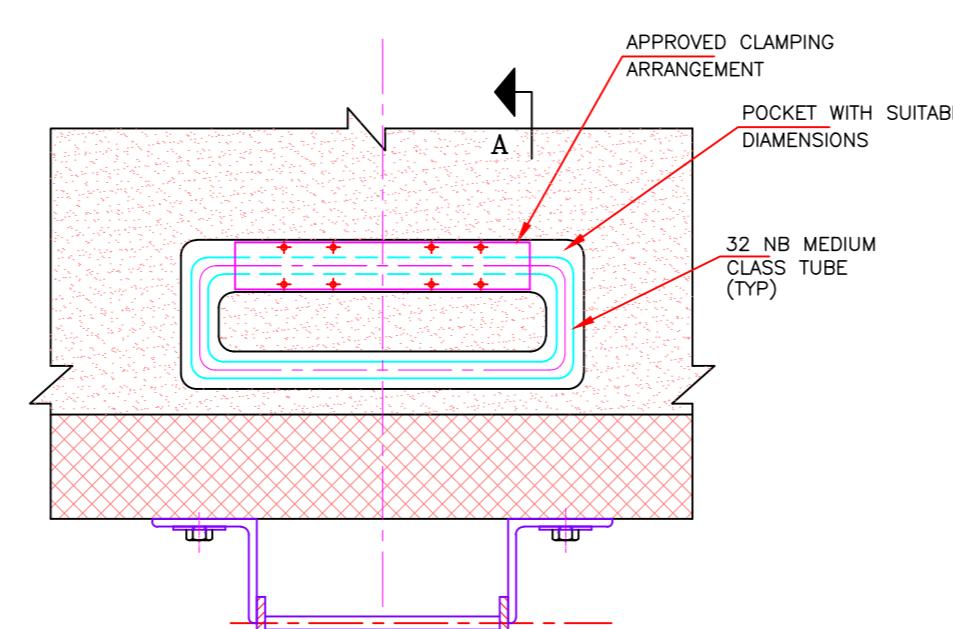


TYP. DETAIL OF RAIL GROOVE
(SCALE 1:5)

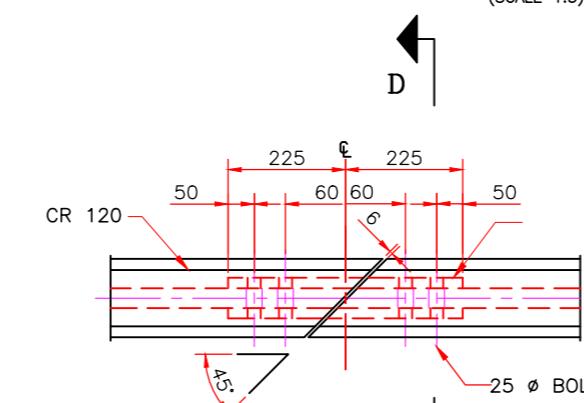





PLAN
(SHOWING RAIL JOINT)
(SCALE 1:10)

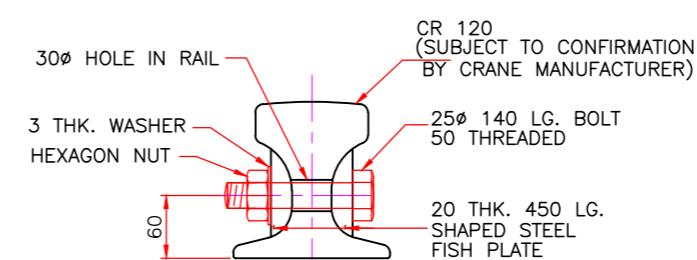

SECTION D-D
(SCALE 1:5)

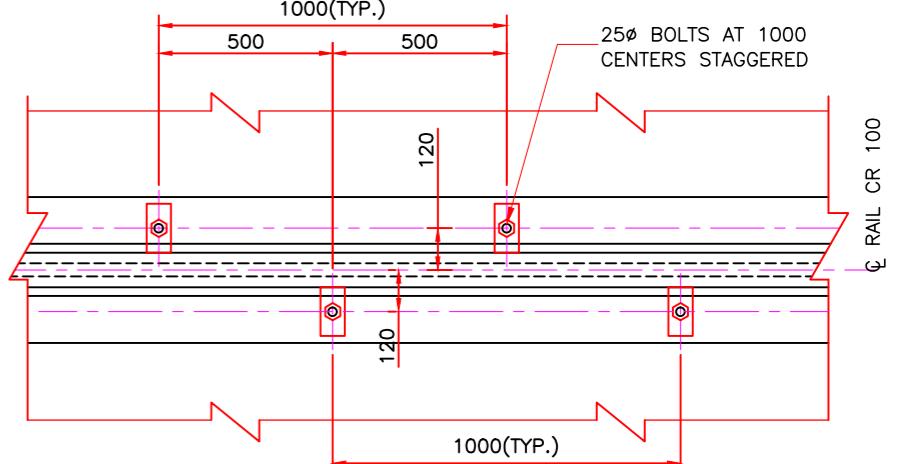

PLAN
(SHOWING RAIL FIXING)
(SCALE 1:15)

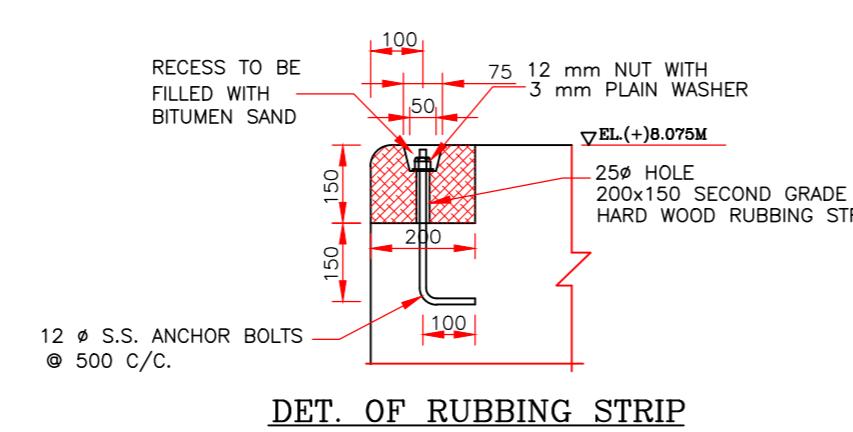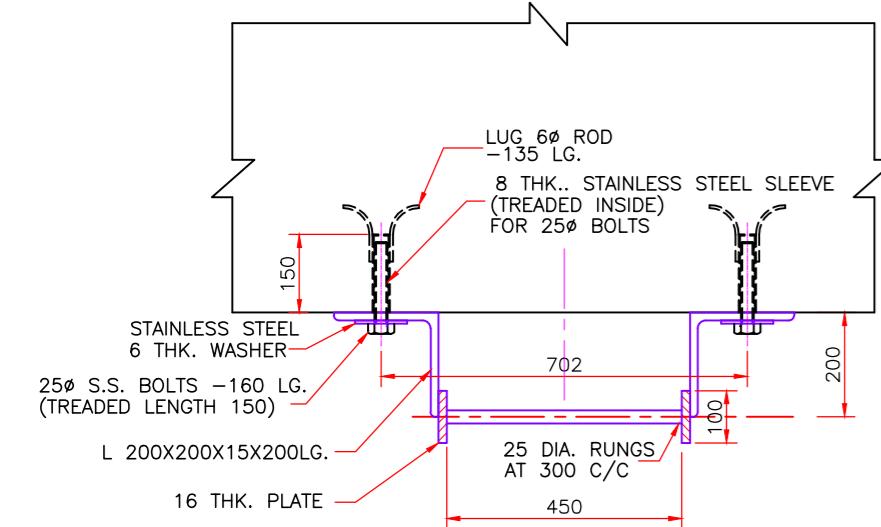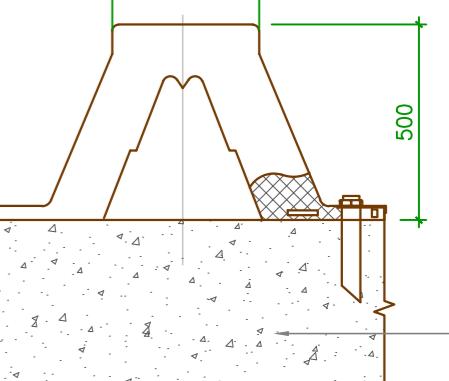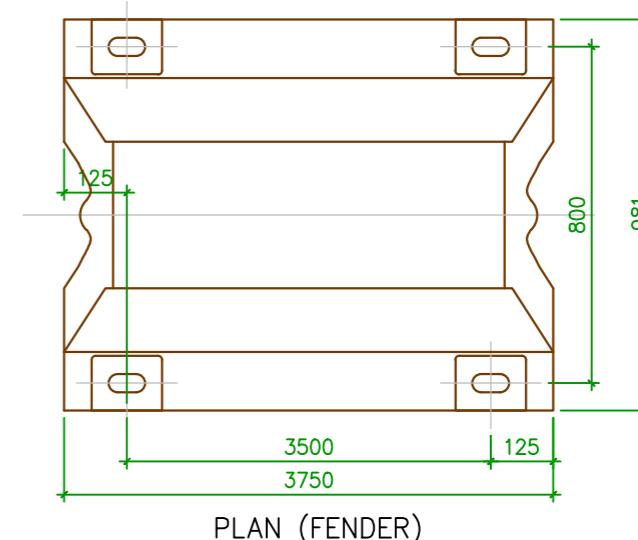

PLAN C-C

A



DET. OF RUBBING STRIP
SCALE 1:10

PLAN B-B

ALL STEEL SECTIONS EXCEPT STAINLESS STEEL
TO BE GALVANISED WITH 125 MICRONS ZINC COATING

NOTES:-

1. ALL DIMENSIONS ARE IN MILLIMETRES UNLESS NOTED OTHERWISE.
2. ALL LEVELS ARE IN METRES RELATED TO CHART DATUM.
3. ALL FIXTURES INCLUDING BOLTS FOR FIXING OF LADDERS SHALL BE OF GRADE SS 316.
4. MOORING RINGS AND 'U' BOLTS SHALL BE OF GRADE SS 316.
5. THE DETAILS OF CRANE RAIL AND ITS FIXTURES SHOWN ARE ONLY INDICATIVE. THE DETAILS OF RAIL FIXING, RAIL JOINT & SIZE AND TYPE OF RAILS SHALL BE AS PER THE SPECIFICATION OF CRANE MANUFACTURER.
6. ALL STEEL SECTIONS EXCEPT STAINLESS STEEL TO BE GALVANISED

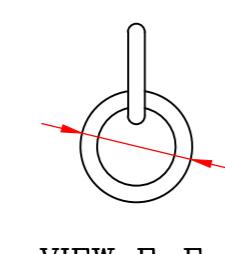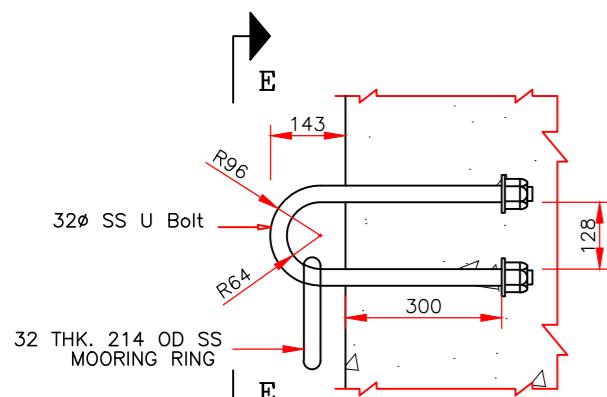

TYP. DET. OF MOORING RING
(SCALE 1:10)

REV.	DATE	DESCRIPTION	VAP	AM	SP	DRW.	C.H.D.	APR.
0	16/01/17							

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NOTES

1. ALL DIMENSIONS ARE IN MILLIMETRE
2. ALL LEVELS ARE IN METRE WITH & ARE RESPECT TO MSL

INLAND WATERWAYS AUTHORITY OF INDIA

PROJECT: DETAILED FEASIBILITY STUDY FOR CAPACITY AUGMENTATION OF NATIONAL WATERWAY-1 AND DETAILED ENGINEERING FOR ITS ANCILLARY WORKS AND PROCESS BETWEEN HALDIA TO ALLAHABAD (JAL VIKAS PROJECT)

CONSULTANT: **PMC PROJECTS** (INDIA) PRIVATE LIMITED
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HOWE


DRN	VAP	16/01/17
CHD	KP	16/01/17
APR	SP	16/01/17


IWT TERMINAL AT VARANASI
BERTHING APPURTENANCES DETAILS
(PHASE-1A)

JOB. NO. DRC. NO.
I-525 VTR-241

COORDINATE SYSTEM USED:
ENTER CO-ORD SYSTEM HERE

UNIT SCALE - AS SHOWN Size : A1 P.V. 0

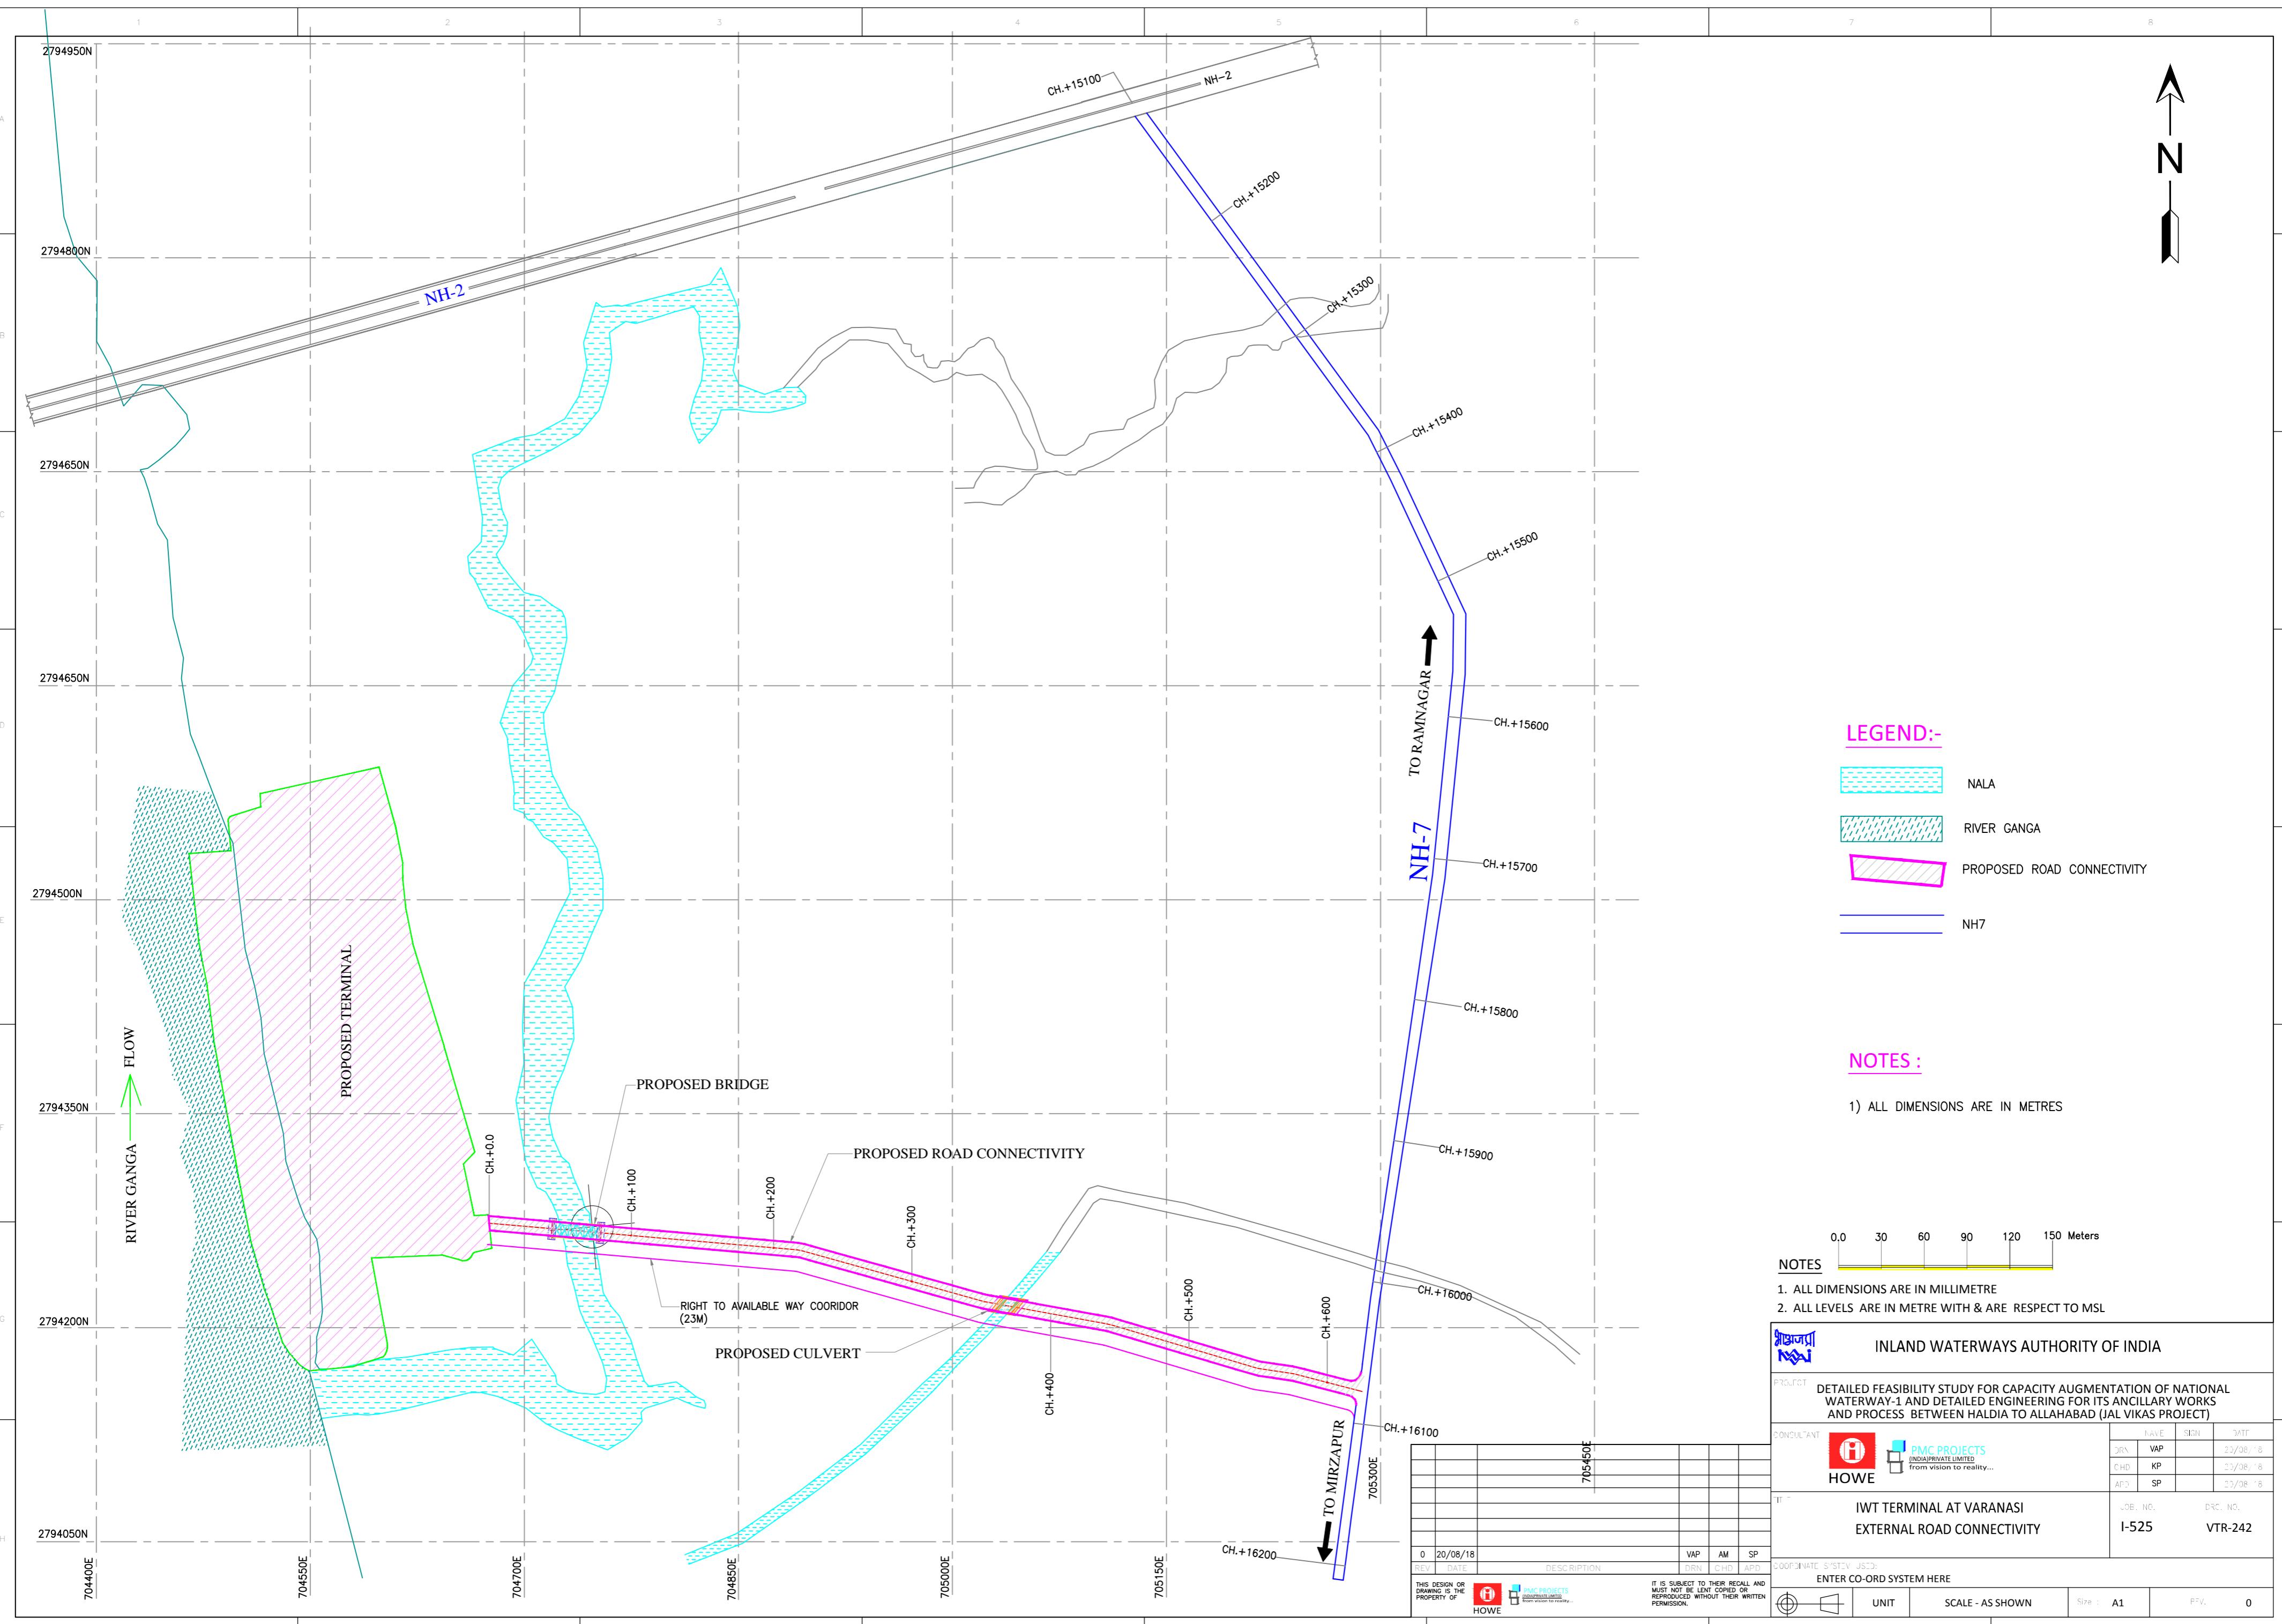

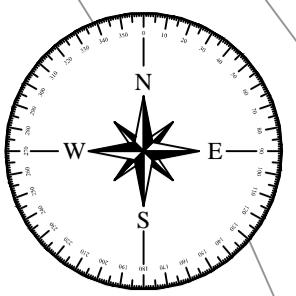

FACILITIES

- ① GODOWN-1
- ② CONTAINER HANDLING AREA 96TGS 7800 SQMT
- ③ BULK CARGO (CONSUMER GOODS) 6000 SQMT
- ④ BULK CARGO (CONSTRUCTION MATERIAL) 2500 SQMT
- ⑤ PROJECT CARGO 3600 SQMT
- ⑥ STP
- ⑦ WATER TANK & PUMP HOUSE
- ⑧ SOAK PIT & SEPTIC TANK
- ⑨ WORKERS AMENITY
- ⑩ PUMP ROOM
- ⑪ SUB-STATION
- ⑫ ADMINISTRATION BUILDING
- ⑬ EXISTING BERTH
- ⑭ PROPOSED BERTH
- ⑮ BANARASI HAAT
- ⑯ TOILET BLOCK
- ⑰ SHOPS / KIOSKS
- ⑱ JAI YATRI NIWAS (GUEST HOUSE)
- ⑲ PARKING AREA-20NOS
- ⑳ PROPOSED FUELSTATION
- ㉑ GATE COMPLEX
- ㉒ WEIGH BRIDGE
- ㉓ EXISTING BUILDING
- ㉔ WEIGH BRIDGE CABIN
- ㉕ SECURITY OFFICE
- ㉖ RAILWAY YARD AREA
- ㉗ UTILITY AREA
- ㉘ CONSTRUCTION MATERIAL BULK 22835 SQMT
- ㉙ CANTEEN & TOILET
- ㉚ 12NOS-E-RIKSHA STAND
- ㉛ 2NOS-BUS PARKING
- ㉜ 180NOS-SCOOTER PARKING
- ㉝ 45NOS-CYCLE PARKING
- ㉞ 240NOS-RIKSHA PARKING
- ㉟ 28NOS-CAR PARKING
- ㉟ 20NOS-E-RIKSHA STAND
- ㉟ ETP/UTILITY
- ㉟ EXISTING PUBLIC TEMPLE
- ㉟ EXISTING HOUSE

